# I.S. 171 - BROCKLYN

528 Ridgewood Ave. Brooklyn, NY 11208

DESIGN NO.: D021557

LLW NO.: 131161 EXTERIOR MASONRY



NEW YORK CITY SCHOOL CONSTRUCTION AUTHORITY 30-30 THOMSON AVENUE, LONG ISLAND CITY, NEW YORK 11101

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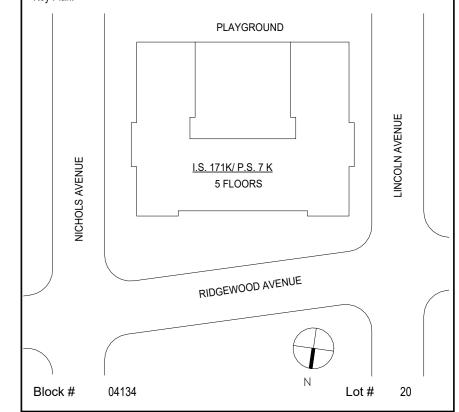
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TEG Taylor Environmental Group **Asbestos Consultants** Taylor Environmental Group, Inc. 130A Jericho Turnpike Floral Park, NY 11001 Phone: (516) 358-2955

Drawing may be printed at reduced scale

IT IS A VIOLATION OF THE STATE EDUCATION LAW SECTION 7209 (2) FOR ANY PERSON TO ALTER AN ITEM IN ANY WAY UNLESS SUCH PERSON IS ACTING UNDER THE DIRECTION OF A LICENSED PROFESSIONAL ENGINEER, AND THE ENGINEER STAMPS SUCH CHANGES

04/14/2023 Construction Documents Date PLAYGROUND



SCA Design Manager:		ASHRAF ELIAS, P.	 E
Project Architect/Engineer:		DAVID SAMMEL, R.	
Discipline Lead:	DAVID	HUNSBERGER, R.	Α
Designer:	JUAN SANTO	OS / JUAN POLANC	С
Drawn by:	JUAN SANTOS		
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Design No or LLW No.: D021557	Facility Code:	Date: 04/14/2023	

I.S. 171 - BROOKLYN EXTERIOR MASONRY

528 Ridgewood Ave. Brooklyn New York 11208

**COVER SHEET** 

DOB # B00836762 - I1

T001.00 Sheets in GC Work Type Contract Set

Sheets in GC Work Type DOB Filing Set

1 OF 43

<sup>1</sup> OF 38

# SPECIAL INSPECTIONS

SPECIAL INSPECTIONS REQUIRED UNDER THIS APPLICATION IN ACCORDANCE WITH CHAPTER 17 AND THE APPLICABLE SECTIONS OF THE NYC CONSTRUCTION CODE ARE LISTED IN THE FOLLOWING TABLES. SPECIAL INSPECTIONS FOR PORTIONS OF THE WORK THAT ARE FILED UNDER SEPARATE APPLICATION ARE NOT LISTED HERE AND ARE TO BE LISTED ON THOSE APPLICATIONS BY THE CONTRACTOR'S APPLICANT OF RECORD.

THE CONTRACTOR MUST NOTIFY THE RELEVANT SPECIAL INSPECTOR OR SPECIAL INSPECTION AGENCY IN WRITING FOR SPECIAL INSPECTIONS AT LEAST 72 HOURS BEFORE THE SPECIFIC WORK COMMENCES.

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THE FOLLOWING SPECIAL INSPECTIONS HAVE BEEN COMPLETED:

MASONRY:	BC 1705.3
STRUCTURAL STABILITY - ALTERATIONS TO EXISTING STRUCTURES	BC 1705.25.1
CONSTRUCTION OPERATIONS INFLUENCING ADJACENT STRUCTURES	BC 1705.25.2
POST INSTALLED ANCHORS - (BB# 2014-018, 2014-019)	BC 1705.37
SUBSURFACE CONDITIONS - FILL PLACEMENT & IN PLACE DENSITY	BC 1705 6 - ITEMS 2 & 3

REQUIRED INSPECTIONS AND TESTS OF MATERIALS DESIGNATED FOR "SPECIAL INSPECTION" BY THE CONTRACTOR SHALL BE MADE UNDER THE DIRECT SUPERVISION OF A LICENSED ARCHITECT OR ENGINEER RETAINED BY OR ON THE BEHALF OF THE CONTRACTOR WHO SHALL BE ACCEPTABLE TO THE ARCHITECT OR ENGINEER WHO SUPERVISED THE PREPARATION OF THE PLANS.

"THE CONCRETE WORK MEETS THE CRITERIA OF SECTION BB 1704.4 FOR EXEMPTION FROM THE REQUIREMENT OF SPECIAL INSPECTION OF 'CONCRETE-CAST IN PLACE,'AND I HEREBY ELECT SUCH AN EXEMPTION. IN ADDITION, THE TR3 & TR2 FORMS ARE NOT REQUIRED"

"STRUCTURAL STABILITY OF EXISTING STRUCTURE" IS LISTED AS A REQUIRED SPECIAL INSPECTION, GC'S ENGINEER'S STABILITY DRAWINGS AND SEQUENCE OF CONSTRUCTION OPERATIONS ARE REQUIRED PRIOR TO PERMIT. TR-1 ISSUED BY SCA LAB.

# PROGRESS INSPECTIONS

PROGRESS INSPECTIONS REQUIRED IN ACCORDANCE WITH CHAPTER 1 OF THE 2022 NYC BUILDING CODE AND THE APPLICABLE SECTIONS OF THE NYC CONSTRUCTION CODE ARE LISTED IN THE FOLLOWING TABLES:

THE CONTRACTOR MUST NOTIFY THE ARCHITECT OR ENGINEER FOR PROGRESS INSPECTIONS AT LEAST 72 HOURS BEFORE THE SPECIFIC WORK COMMENCES OR REQUIRES INSPECTION.

THE "AUTHORITY" SHALL BE RESPONSIBLE FOR THE FOLLOWING PROGRESS INSPECTIONS:

FINAL INSPECTION: 28-116.2.4.2 AND BC 110.5

	LIST OF DRAWINGS		
DRAWING NO.	DRAWING NAME	CONTRACT SET SHEET NO.	DOB SET
T001.00	COVER SHEET	1	1
T001A.00	COMPILED LIST OF DRAWINGS, SPECIAL INSPECTIONS & PROGRESS INSPECTIONS FOR CONTRACT	-	-
T002.00	SUMMARY OF WORK, GEN. NOTES, SITE SAFETY & PROTECTION NOTES, BUILDING DEPART. NOTES, SPECIAL INSPECTION, PROGRESS INSPECTIONS, PROVISIONS, ALLOWANCES, SHPO & LIST OF DRAWINGS	2	2
T003.00	ABBREVIATIONS, REFERENCE SYMBOLS, ROOFING NOTES, PARAPET/MASONRY NOTES, SITE PLAN & LOCATION PLAN	3	3
TEMPORARY EGRESS PLANS			
TE001.00	TEMPORARY EGRESS LOAD CALCULATIONS NOTES & LEGEND	4	4
TE101.00	PHASE 1 CELLAR FLOOR TEMPORARY EGRESS PLAN	5	5
TE102.00	PHASE 1 BASEMENT FLOOR TEMPORARY EGRESS PLAN	6	6
TE103.00	PHASE 2 BASEMENT FLOOR TEMPORARY EGRESS PLAN	7	7
TE104.00	PHASE 2 FIRST FLOOR TEMPORARY EGRESS PLAN	8	8
TE105.00	PHASE 2 SECOND FLOOR TEMPORARY EGRESS PLAN	9	9
TE106.00	PHASE 2 THIRD FLOOR TEMPORARY EGRESS PLAN	10	10
TE107.00	PHASE 2 FORTH FLOOR TEMPORARY EGRESS PLAN	11	11
ARCHITECTURE			
A030.00	SELECTIVE REMOVAL – SITE PLANS	12	12
A035.00	NEW WORK - SITE PLAN	13	13
A036.00	SITE DETAILS	14	14
A061.00	SELECTIVE REMOVAL ROOF PLAN	15	15
A062.00	SELECTIVE REMOVAL FOURTH FLOOR REFLECTED CEILING PLAN	16	16
A063.00	SELECTIVE REMOVAL - INTERIOR ELEVATIONS - 1	17	17
A064.00	SELECTIVE REMOVAL - INTERIOR ELEVATIONS - 2	18	18
A101.00	NEW WORK - ROOF PLAN	19	19
A201.00	EXTERIOR ELEVATION NORTH	20	20
A202.00	EXTERIOR ELEVATION EAST	21	21
A203.00	EXTERIOR ELEVATION SOUTH	22	22
A204.00	EXTERIOR ELEVATION WEST	23	23
A205.00	EXTERIOR ELEVATIONS COURTYARD-1	24	24
A206.00	EXTERIOR ELEVATIONS COURTYARD-2	25	25
A207.00	PARAPET INTERIOR ELEVATIONS-1	26	26
A208.00	PARAPET INTERIOR ELEVATIONS-2	27	27
A301.00	INTERIOR ELEVATIONS-1	28	28
A302.00	INTERIOR ELEVATIONS-2	29	29
A401.00	MASONRY DETAILS	30	30
A402.00	PILASTERS PLAN DETAILS	31	31
A403.00	PILASTER DETAILS - 1	32	32
A404.00	PILASTER DETAILS - 2	33	33
A405.00	PILASTER DETAILS - 3	34	34
A406.00	COPING DETAILS	35	35
A701.00	INTERIOR DETAILS	36	36
A801.00	REFLECTED CEILING PLAN	37	37
ENVIRONMENTAL	INCI LLO ILD OLILINO I LAN	JI	31
H101.00	ASBESTOS ABATEMENT GENERAL NOTES	38	
H102.00	ROOF LEVEL - ASBESTOS ABATEMENT PLAN	39	<del>-</del>
H103.00	EXTERIOR FACADE EAST AND WEST COURTYARD ELEVATIONS - ASBESTOS ABATEMENT PLAN	40	<del>-</del>
H104.00	EXTERIOR FACADE EAST AND WEST COURTYARD ELEVATIONS - ASBESTOS ABATEMENT PLAN  EXTERIOR FACADE SOUTH COURTYARD ELEVATION - ASBESTOS ABATEMENT PLAN	40	-
	LATERION FACADE SOUTH COUNTARD ELEVATION - ASDESTOS ADATEMENT PLAIN	41	-
REFERENCE	ZONE OF DUDU IC DROTECTION DUAN /FOR REFERENCE ONLY	40	
R001.00	ZONE OF PUBLIC PROTECTION PLAN (FOR REFERENCE ONLY)	42	-

FIRE DEPARTMENT ROOF ACCESS PLAN (FOR REFERENCE ONLY)

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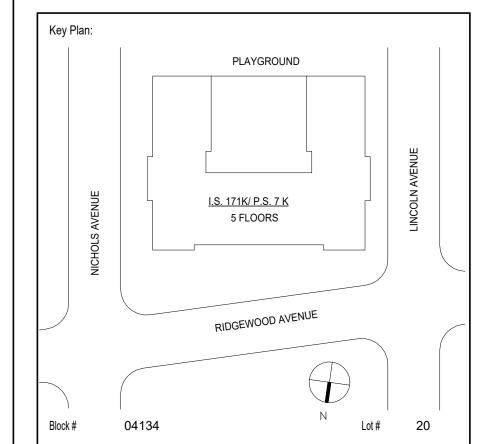
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04/14/2023 Construction Documents Date Revisions

43 38



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Project Architect/Engineer:	DAVID SAMMEL, R.A		
Discipline Lead:	DAVID HU	INSBERGER, R.A	
Designer:	JUAN SANTOS / JUAN POLANCO		
Drawn by:	JUAN SANTOS		
Checked by:	DA\	/ID SAMMEL, R.A	
Design No or LLW No.: D021557	Facility Code: K171	Date: 04/14/2023	

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**EXTERIOR MASONRY** 

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COMPILED LIST OF DRAWINGS, SPECIAL INSPECTIONS & PROGRESS INSPECTIONS FOR CONTRACT

DOB # B00836762 - I1

T001A.00

Sheets in GC Work Type Contract Set : - OF 43

Sheets in GC Work Type DOB Filing Set:

- OF 38

# SUMMARY OF WORK

THE WORK SHALL BE AS SHOWN AND CALLED FOR IN THE CONTRACT DOCUMENTS AND SHALL INCLUDE, BUT NOT BE LIMITED TO. THE FOLLOWING GENERAL ITEMS OF WORK

#### LLW # 131161 EXTERIOR MASONRY:

- PROVIDE NEW STONE AND FACE BRICK MASONRY REPOINTING
- REMOVE AND REPLACE CRACKED FACE BRICKS AND ANCHORS
- REMOVE AND REPLACE MASONRY CONTROL AND EXPANSION JOINTS SELANTS PROVIDE FLASHINGS AT WINDOW HEADS WHERE FACE BRICK REPLACEMENT LOCATIONS
- REMOVE ALL LOOSE, PEELING AND FLAKING MASONRY SEALER ON INTERIOR COURT SOUTH, EAST AND WEST
- WALLS. PREP WALL AND PROVIDE NEW SEALER AFTER REPOINTING PROVIDE NEW ANTI-GRAFFITI COATING
- REPLACE DETERIORATED CONC. STEPS TREAD, RISERS, AND LANDING, AND PROVIDE NEW RAILING ON SELECTED STAIRS.
- REPLACE AND PATCH DETERIORATED PLASTER CEILING AND WALLS, AND PROVIDE NEW PAINT FINISH
- REMOVE AND REPLACE HOIST VAULT ACCESS DOOR AND REPAIR CONC. CURB AT REMOVAL
- REMOVE DETERIORATED CHEEK WALL FACE AND CONC. COATING, REPAIR AND PROVIDE NEW ELASTOMERIC
- COATING. REPOINT INTERIOR PARAPETS WALLS INCLUDING MOTAR BED BELOW COPING.
- REMOVE AND REPLACE EXPANSION AND CONTROL JOINTS SEALANTS, AND SELANT BELOW AT COPING CAP
- FLASHING. M. REPLACE CAST STONE COPING CAP, PROVIDE NEW S.S. CAP FLASHINGS AND NEW CAST STONE COPING AND
- ANCHORS AT SELECTED PILASTERS AND PARAPETS.
- REMOVE AND REPLACE CRACKED FACE BRICKS AND ANCHORS

## **GENERAL NOTES:**

THE FOLLOWING NOTES SHALL APPLY THROUGHOUT, EXCEPTIONS ARE SPECIFICALLY NOTED ON EACH DRAWINGS.

- WHERE DIMENSIONS ARE INDICATED, DIMENSIONS GOVERN OVER SCALE. ALL DIMENSIONS AND CONDITIONS SHOWN AND ASSUMED ON THE DRAWINGS MUST BE VERIFIED AT THE SITE BY THE CONTRACTOR BEFORE ORDERING ANY MATERIAL OR DOING ANY WORK. ANY DISCREPANCIES IN THE DRAWINGS AND SPECIFICATIONS SHALL BE REPORTED TO THE AUTHORITY. NO CHANGE IN DRAWINGS OR SPECIFICATIONS IS PERMISSIBLE WITHOUT THE WRITTEN CONSENT OF THE ARCHITECT/ENGINEER. NO WORK SHALL PROCEED UNTIL SUCH DISCREPANCY HAS BEEN RECTIFIED.
- ALL WORK ON THESE DRAWINGS SHALL BE CONSIDERED NEW WORK WHETHER STATED OR NOT EXCEPT WHERE SPECIFICALLY NOTED AS "EXISTING TO REMAIN".
- COORDINATION OF ALL WORK UNDER THIS CONTRACT SHALL BE MAINTAINED TO ENSURE THE QUALITY AND TIMELY COMPLETION OF THE WORK/PROJECT.
- THE CONTRACTOR SHALL FURNISH AND INSTALL NEW MATERIALS AT NO ADDITIONAL COST TO THE **AUTHORITY FOR THE FOLLOWING CONDITIONS:**
- ANY EXISTING WORK THAT HAS BEEN REMOVED OR DAMAGED IN ORDER TO PERFORM THE CONTRACT WORK.
  - b) TO FURNISH THE WORK OF THIS CONTRACT IN WORKMANLIKE MANNER.
- THE CONTRACTOR SHALL BE RESPONSIBLE FOR ADEQUATELY BRACING AND PROTECTING ALL WORK DURING CONSTRUCTION AGAINST DAMAGE, BREAKAGE, COLLAPSE, DISTORTIONS AND OFF ALIGNMENTS ACCORDING TO CODES AND STANDARDS OF GOOD PRACTICE.
- THE CONTRACTOR SHALL INCLUDE ALL PREPARATORY AND ASSOCIATED SUPPLEMENTARY WORK TO PROVIDE A COMPLETE AND FINISHED INSTALLATION.
- WHERE MANUFACTURER'S NAMES AND PRODUCT NUMBERS ARE INDICATED ON DRAWINGS. IT SHALL BE CONSTRUED TO MEAN THE ESTABLISHMENT OF QUALITY AND PERFORMANCE STANDARDS OF SUCH ITEMS. ALL OTHER PRODUCTS MUST BE SUBMITTED TO THE ARCHITECT FOR APPROVAL BEFORE THEY SHALL BE DEEMED EQUAL.
- FIRESTOPPING SHALL BE INSTALLED AT ALL PENETRATIONS OF FIRE-RATED CONSTRUCTION AS PER SPECIFICATIONS. FIRESTOPPING MATERIALS ARE TO BE APPROPRIATE FOR, AND BE PART OF A LISTED AND LABELED ASSEMBLY IN ACCORDANCE WITH THE BUILDING CODE OR HAVE OTCR OR MEA APPROVAL.
- SIZE OF MASONRY UNITS AND WOOD MEMBERS ON PLANS, BUILDING ELEVATIONS AND SECTIONS ARE SHOWN AS NOMINAL SIZE
- 10. DIMENSIONS ON PLANS ARE INDICATED FROM SURFACE TO SURFACE BETWEEN WALLS, PARTITIONS AND OTHER ITEMS EXCLUSIVE OF FINISHES.
- 11. PROVIDE GUARDS, RAILS, BARRICADES, FENCES, SIDEWALK SHEDS, CATCH PLATFORMS, DECKING, NIGHT LIGHTING, ETC., AS REQUIRED BY SECTION BC 3307.3 OF THE 2022 NEW YORK CITY BUILDING CODE AND AS REQUIRED TO PROVIDE ADEQUATE PROTECTION. ALSO, COMPLY WITH SECTION S01500, S01535 AND S01900 OF THE SPECIFICATION.
- THE CONTRACTOR SHALL KEEP WORK SITE FREE FROM DEBRIS AND ACCUMULATED REFUSE, AND SHALL HAVE SOLE RESPONSIBILITY FOR PROTECTING ALL DANGEROUS AREAS FROM ENTRY BY UNAUTHORIZED PARTIES. SITE SHALL BE LEFT BROOM CLEAN AT THE END OF EACH WORKING DAY.
- 13. THE CONTRACTOR SHALL MAINTAIN FREE AND UNOBSTRUCTED ACCESS FROM ALL ADJACENT SPACES INTO THE EXISTING FIRE STAIRS TO OUTSIDE OF THE BUILDING AT ALL TIMES.
- 14. WHERE INDICATED OR REQUIRED TO PERFORM THE WORK, PACK, PROTECT AND RELOCATE BOOKS. MATERIALS, FURNITURE, CABINETS, ETC. TO DESIGNATED LOCATIONS WITHIN THE BUILDING AND RETURN ITEMS UPON COMPLETION OF WORK OR WHEN DIRECTED BY THE AUTHORITY.
- 15. THE CONTRACTOR SHALL, UNLESS OTHERWISE PROVIDED IN THE CONTRACT DOCUMENTS, SECURE AND PAY FOR THE REQUIRED CONSTRUCTION PERMIT(S), FEES, LICENSES AND INSPECTIONS NECESSARY FOR THE PROPER EXECUTION OF THE WORK. APPLICATION FOR CONSTRUCTION PERMITS SHALL BE PROCESSED THRU THE BUILDING CODE COMPLIANCE DIVISION OF THE AUTHORITY.
- 16. THERE WILL BE NO CHANGE IN USE, EGRESS OR OCCUPANCY BECAUSE OF THE WORK OF THIS CONTRACT.
- 17. ADDITIONAL NOTES THAT ARE APPLICABLE TO THIS PROJECT MAY BE FOUND THROUGHOUT THE CONTRACT
- 18. THE CONTRACTOR SHALL COORDINATE THE REMOVAL OF THE EXISTING SHED AND INSTALLATION OF NEW SHED IMMEDIATELY UPON REMOVAL OF THE EXISTING SHED. THE EXISTING SHED MUST BE MAINTAINED FROM THE DATE OF N.T.P. AND NEW SHED MUST BE ERECTED WITHIN SEVEN CALENDAR DAYS OF N.T.P. OR MAKE AN ALTERNATE ARRANGEMENT WITH OWNER OF THE EXISTING SHED TO PAY RENT.
- THE CONTRACTOR SHALL PROVIDE PIPE SCAFFOLDING ON ALL ELEVATIONS FOR FULL HEIGHT. THE PIPE SCAFFOLDING SHALL HAVE PLANKS AT ALL FLOOR LEVELS. PROVIDE STAIRS TO ACCESS PLANKS AT ALL LEVELS. NO OTHER TYPE OF SCAFFOLDING IS ACCEPTABLE. THE PIPE SCAFFOLDING SHALL BE CONSTRUCTED ON ALL FACADES PRIOR TO THE COMMENCEMENT OF ANY CONTRACT WORK AND BE MAINTAINED UNTIL THE PROJECT IS SUBSTANTIALLY COMPLETED AND SIGNED BY THE ARCHITECT/ENGINEER OR RECORD. THE CONTRACTOR SHALL PROVIDE TEMPORARY LIMIT STOPS AT UPPER AND LOWER SASHES OF ALL WINDOWS, WHICH ARE ARE ACCESSIBLE FORM THE SCAFFOLDING, THE DAY BEFORE ERECTING THE PIPE SCAFFOLDING. THE TEMPORARY STOPS SHALL BE ELIMINATED AFTER THE PIPE SCAFFOLDING IS REMOVED. ALSO, FILL AND SEAL AREAS OF REMOVED ANCHORS.
- 20. PROVIDE PROJECT INFORMATION SIGNAGE MEETING REQUIREMENTS OF SECTION BC 3301.9.
- 21. THE CONTRACTOR SHALL FIELD VERIFY ALL DIMENSIONS AND CONDITIONS OF THE SITE AND/OR BUILDING.

# **GENERAL NOTES: CONTINUED**

- 24. THE CONTRACTOR SHALL PERFORM ALL CUTTING AND PATCHING REQUIRED TO COMPLETE THE WORK OR TO MAKE ITS PARTS FIT TOGETHER PROPERLY WITHOUT COMPROMISING THE QUALITY OF THE WORK.
- 25. ALL ELEVATIONS SHOWN ARE BASED ON THE NORTH AMERICAN VERTICAL DATUM OF 1988 (NAVD88) AS
- ESTABLISHED AND MAINTAINED BY NATIONAL GEODETIC SURVEY OF THE NATIONAL OCEAN SERVICE. NATIONAL OCEANIC AND ATMOSPHERIC ADMINISTRATION OR SUCCESSOR AGENCY.
- 26. THE TERM "FINISH FLOOR" SHALL MEAN THE NORMAL FINISHED SURFACE OF THE FLOOR LEVEL. ALL ELEVATIONS GIVEN FOR EXISTING BUILDINGS ARE TO FINISHED FLOOR. THE CONTRACTOR SHALL FIELD VERIFY ALL ELEVATIONS FOR EXISTING STRUCTURES PRIOR TO THE COMMENCEMENT OF WORK.
- 27. THE CONTRACTOR SHALL PATCH AND REPAIR ALL FLOORS, WALLS CEILINGS, ETC.. DAMAGED OR EXPOSED DUE TO WORK OR REMOVALS AND FINISH TO MATCH ADJOINING SURFACES.
- 28. ALL UNSUPPORTED LINTELS GREATER THAN 4'-0" SHALL BE FIREPROOFED AS PER BUILDING CODE.
- 29. THE CONTRACTOR SHALL EXTEND ALL WALL FINISHES A MINIMUM OF 6" ABOVE THE SUSPENDED OR FURRED CEILING.
- UNLESS OTHERWISE NOTED, EXTERIOR BRICK WALLS SHALL BE INSTALLED IN A RUNNING BOND.
- 31. THE CONTRACTOR SHALL COORDINATE AND INSTALL ALL CLEANOUT AND ACCESS DOORS IN PARTITIONS AND HUNG CEILINGS AS REQUIRED BY THE CONTRACT DOCUMENTS.
- 32. CONSTRUCTION MEETS THE REQUIREMENTS OF TITLE 14 CODE OF FEDERAL REGULATIONS PART 77 SUBPART B. THECONTRACTOR SHALL FILE A FEDERAL AVIATION AUTHORITY (FAA) FORM 7460-1 60 DAYS PRIOR TO BEGINNING OF CONSTRUCTION.

# **SITE SAFETY AND PROTECTION NOTES**

- THE CONTRACTOR MUST FOLLOW THE REQUIREMENTS INCLUDED IN THE SCA SAFETY UNIT'S 'SAFETY PROGRAM AND PROCEDURES MANUAL'. WHERE THE REQUIREMENTS OF THE 'SAFETY PROGRAM AND PROCEDURES MANUAL' DIFFER FROM THE NYC BUILDING CODE REQUIREMENTS, THE MORE STRINGENT OF THE TWO REQUIREMENTS MUST BE MET.
- THE CONTRACTOR SHALL PROVIDE CONSTRUCTION FENCE AROUND ENTIRE PERIMETER OF WORK SITE
- 3. THE CONTRACTOR SHALL MAINTAIN ACCESS TO STREET UTILITY COVERS.
- 4. THE CONTRACTOR SHALL LOCATE AND CONFIRM ALL UTILITY CONNECTIONS ASSOCIATED WITH THE BUILDING AND SITE. ANY DISCREPANCIES SHALL BE BROUGHT TO THE IMMEDIATE ATTENTION OF THE ARCHITECT AND
- 5. ALL REMOVALS SHALL BE PERFORMED AS PER APPROVED REMOVAL APPLICATION.
- 6. ALL SCAFFOLDING TO BE PROTECTED BY TOE BOARDS, SCREENS, GUARDRAILS, STRONGMAN NETTING OR OTHER OSHA APPROVED SYSTEMS FOR FALLING OBJECT PROTECTION. DESIGN OF SAFETY NETTING TO COMPLY WITH BC3308.3 OF THE 2022 NYC BUILDING CODE.
- CLEARANCE BETWEEN SCAFFOLDS AND OVERHEAD UTILITY LINES SHALL BE PER OSHA 1926.451.
- PROVIDE A SITE SAFETY PLAN FOR REVIEW BY THE AUTHORITY'S SAFETY UNIT. THE FOLLOWING ZONE OF PUBLIC PROTECTION DRAWING(s) IS PROVIDED FOR REFERENCE ONLY TO SHOW AT A MINIMUM ADJACENT PROPERTIES WITH APPROXIMATE DISTANCES REQUIRING PROTECTION. R001.00
- 9. THE CONTRACTOR SHALL PROVIDE BARRICADES FOR LANE CLOSINGS AS REQUIRED BY NYCDOT HIGHWAY
- THE CONTRACTOR SHALL ENSURE UNINTERRUPTED UTILITIES AND SERVICES TO ADJACENT STRUCTURES DURING THE DURATION OF THE PROJECT.
- 11. THE CONTRACTOR SHALL COMPLY WITH BC 3306 FOR REMOVAL WORK.
- 12. THE CONTRACTOR SHALL COMPLY WITH BC 3307 FOR PROTECTION OF PEDESTRIANS.
- THE CONTRACTOR SHALL COMPLY WITH BC 3309 FOR PROTECTION OF ADJOINING PROPERTIES

# **BUILDING DEPARTMENT NOTES**

THE FOLLOWING NOTES SHALL APPLY THROUGHOUT:

- WORK SHALL BE EXECUTED IN FULL COMPLIANCE WITH THE APPLICABLE PROVISIONS OF ALL LAWS, BY-LAWS, STATUTES, ORDINANCES, CODES, RULES, REGULATIONS AND LAWFUL ORDERS OF PUBLIC AUTHORITIES BEARING ON THE PERFORMANCE AND EXECUTION OF THE WORK.
  - THIS APPLICATION IS FILED UNDER 2022 NYC BUILDING CODE FOR COMPLIANCE WITH CHAPTERS 1, 17, 32 & 33 REGARDING ADMINISTRATION, INSPECTION AND SAFETY REQUIREMENTS.

AVAILABLE RECORDS INDICATE THAT THIS BUILDING WAS CONSTRUCTED APPROXIMATELY IN 1927

ALTERATIONS ARE DONE IN ACCORDANCE WITH THE 1938 BUILDING CODE, WITH THE EXCEPTION THAT PORTIONS OF THE BUILDING REGULATED BY RETROACTIVE CODE PROVISIONS ARE DESIGNED TO COMPLY WITH THE 2022 CODE. THE FOLLOWING ITEMS ARE DESIGNED AS PER THE 2022 CONSTRUCTION CODES.

A. HAND RAILINGS

APPROVED BY OTCR

THE CONTRACTOR SHALL PROMPTLY NOTIFY THE AUTHORITY OF ANY PORTIONS OF THE WORK, IN THE CONTRACT DOCUMENTS THAT ARE AT VARIANCE WITH THE ABOVE.

- 2. THE CONTRACTOR SHALL CONSTRUCT STREETS AND STREET CURBING IN ACCORDANCE WITH THE RULES AND REGULATIONS OF THE BUREAU OF HIGHWAYS FOR THE BOROUGH IN WHICH THIS CONTRACT IS TO BE
- ALL MATERIALS, ASSEMBLIES, FORMS METHODS OF CONSTRUCTION AND SERVICE EQUIPMENT SHALL MEET THE FOLLOWING REQUIREMENTS:
- a. THEY SHALL HAVE BEEN ACCEPTABLE PRIOR TO THE EFFECTIVE DATE OF THE CODE BY THE BOARD OF STANDARDS AND APPEALS OR MEA.
- THEY SHALL HAVE BEEN ACCEPTED FOR THE USE UNDER THE PRESCRIBED TEST METHODS BY THE COMMISSIONER (OR)
- APPROVED BY THE OFFICE OF TECHNICAL CERTIFICATION AND RESEARCH (OTCR) d. SHALL BE LISTED AND LABELED BY DOB RECOGNIZED AGENCY TO MEET REQUIRED STANDARD.
- 4. MATERIALS OR ASSEMBLIES REQUIRED TO HAVE A FIRE RESISTANCE RATING SHALL COMPLY WITH ONE OF THE FOLLOWING:
  - THEY SHALL CONFORM WITH CHAPTER 7 OF THE 2022 NYC BUILDING CODE THEY SHALL HAVE BEEN TESTED IN ACCORDANCE WITH ASTM E119 OR UL 263, STANDARD METHODS OF
- FIRE TESTS OF BUILDING CONSTRUCTION AND MATERIALS BY A NATIONALLY RECOGNIZED AGENCY. THEY SHALL HAVE BEEN ACCEPTABLE PRIOR TO THE EFFECTIVE DATE OF THE CODE.
- ALL MASONRY UNITS SHALL CONFORM TO THE BUILDING CODE WITH BOARD OF STANDARDS AND APPEALS APPROVAL. MASONRY WALLS AND CONSTRUCTION SHALL CONFORM TO RS 10-2 OF THE BUILDING CODE.

# **BUILDING DEPARTMENT NOTES: CONTINUED**

- THE CONSTRUCTION CLASSIFICATION OF THE BUILDING IS "TYPE IB" (TABLE 601). THE CONSTRUCTION ELEMENTS SHALL BE OF THE REQUIRED MINIMUM FIRE RESISTANCE RATINGS AS OUTLINED IN TABLE 601 AND DEFINED IN CHAPTER 6 OF THE 2022 NYC BUILDING CODE
- ALLOWABLE BUILDING HEIGHT SHALL BE IN ACCORDANCE WITH TABLE 504.3.
- NUMBER OF STORIES SHALL BE IN ACCORDANCE WITH TABLE 504.4. ALLOWABLE BUILDING AREA SHALL BE IN ACCORDANCE WITH TABLE 506.2. BC 506.3 AND BC 507.11
- THE FOLLOWING SHALL BE MADE UNDER SEPARATE APPLICATION BY THE CONTRACTOR'S LICENSED PROFESSIONAL IN ACCORDANCE WITH SECTION 28-104.2.6 OF TITLE 28:

SIDEWALK SHEDS	PRIOR TO PERMIT
CONSTRUCTION FENCES	PRIOR TO PERMIT
CHUTES, SCAFFOLDS, HOISTS	PRIOR TO PERMIT

- THE ITEMS LISTED IN NOTES 7 ABOVE ARE TO BE FILED UNDER SEPARATE APPLICATION i.e. DEFERRED TO BE FILED, SHALL NOT BE CONSTRUCTED PRIOR TO OBTAINING SUCH PERMIT. THESE DRAWINGS HAVE BEEN PREPARED BY OR AT THE DIRECTION OF THE UNDERSIGNED AND TO THE BEST OF THE UNDERSIGNED'S KNOWLEDGE, BELIEF AND PROFESSIONAL JUDGEMENT ARE IN COMPLIANCE WITH THE NYC CONSTRUCTION
- ALL NEW WORK DOES NOT HAVE TO COMPLY WITH THE 2020 NEW YORK CITY ENERGY CONSERVATION CODE, AS THE BUILDING IS SHPO.
- 10. ALL NEW INTERIOR FINISHES SHALL BE CONSTRUCTED OF MATERIALS MEETING SECTION 27-529 FOR FLAME SPREAD RATINGS.
- 11. FOLLOW CHAPTER 33 OF THE 2022 NYC BUILDING CODE PROTECTION OF THE PUBLIC AND ADJACENT PROPERTIES.
- NO OPEN VIOLATIONS
- PROGRESS INSPECTIONS REQUIRED TO BE PERFORMED DURING CONSTRUCTION FOR ANY NEW BUILDING, ADDITION OR ALTERATION PROJECT ARE IDENTIFIED BY THE APPLICANT ACCORDING TO THE SCOPE OF WORK AND LISTED AND DESCRIBED IN THE DRAWING. IN ACCORDANCE WITH SECTION BC 110.9, WHERE AN INSPECTION OR TEST FAILS, THE CONSTRUCTION SHALL BE CORRECTED.
- IN ACCORDANCE WITH ARTICLE 116 OF TITLE 28 AND SECTION BC 110, CONSTRUCTION SHALL BE SCHEDULED. TO ALLOW REQUIRED PROGRESS INSPECTIONS TO TAKE PLACE, AND THAT ROOFS, CEILINGS, EXTERIOR WALLS, INTERIOR WALLS, FLOORS, FOUNDATIONS, BASEMENTS AND ANY OTHER CONSTRUCTION SHALL NOT BE COVERED OR ENCLOSED UNTIL REQUIRED PROGRESS INSPECTIONS ARE COMPLETED OR THE PROGRESS INSPECTOR INDICATES THAT SUCH COVERING OR ENCLOSURE MAY PROCEED AT EACH STAGE OF CONSTRUCTION, AS APPLICABLE.
- PARAPETS
- 16. HEIGHT OF PARAPETS/GUARDS IS TO BE 3'-6" (MIN.) FROM HIGH POINT OF ROOF IN ACCORDANCE WITH 27-334 OF THE 1968 BUILDING CODE.

# SPECIAL INSPECTIONS

SPECIAL INSPECTIONS REQUIRED UNDER THIS APPLICATION IN ACCORDANCE WITH CHAPTER 17 AND THE APPLICABLE SECTIONS OF THE NYC CONSTRUCTION CODE ARE LISTED IN THE FOLLOWING TABLES. SPECIAL INSPECTIONS FOR PORTIONS OF THE WORK THAT ARE FILED UNDER SEPARATE APPLICATION ARE NOT LISTED HERE AND ARE TO BE LISTED ON THOSE APPLICATIONS BY THE CONTRACTOR'S APPLICANT OF RECORD.

THE CONTRACTOR MUST NOTIFY THE RELEVANT SPECIAL INSPECTOR OR SPECIAL INSPECTION AGENCY IN WRITING FOR SPECIAL INSPECTIONS AT LEAST 72 HOURS BEFORE THE SPECIFIC WORK COMMENCES.

THE CONTRACTOR MUST NOTIFY THE RELEVANT SPECIAL INSPECTOR OR SPECIAL INSPECTION AGENCY IN WRITING FOR SPECIAL INSPECTIONS AT LEAST 72 HOURS BEFORE THE SPECIFIC WORK COMMENCES.

THE FOLLOWING SPECIAL INSPECTIONS HAVE BEEN COMPLETED:

MASONRY:	BC 1705.3
STRUCTURAL STABILITY - ALTERATIONS TO EXISTING STRUCTURES	BC 1705.25.1
CONSTRUCTION OPERATIONS INFLUENCING ADJACENT STRUCTURES	BC 1705.25.2
POST INSTALLED ANCHORS - (BB# 2014-018, 2014-019)	BC 1705.37
SUBSURFACE CONDITIONS - FILL PLACEMENT & IN PLACE DENSITY	BC 1705.6 - ITEMS 2 & 3

FINAL INSPECTION:

REQUIRED INSPECTIONS AND TESTS OF MATERIALS DESIGNATED FOR "SPECIAL INSPECTION" BY THE CONTRACTOR SHALL BE MADE UNDER THE DIRECT SUPERVISION OF A LICENSED ARCHITECT OR ENGINEER RETAINED BY OR ON THE BEHALF OF THE CONTRACTOR WHO SHALL BE ACCEPTABLE TO THE ARCHITECT OR ENGINEER WHO SUPERVISED THE PREPARATION OF THE PLANS.

"THE CONCRETE WORK MEETS THE CRITERIA OF SECTION BB 1704.4 FOR EXEMPTION FROM THE REQUIREMENT OF SPECIAL INSPECTION OF 'CONCRETE-CAST IN PLACE, 'AND I HEREBY ELECT SUCH AN EXEMPTION. IN ADDITION, THE TR3 & TR2 FORMS ARE NOT REQUIRED"

"STRUCTURAL STABILITY OF EXISTING STRUCTURE" IS LISTED AS A REQUIRED SPECIAL INSPECTION. GC'S ENGINEER'S STABILITY DRAWINGS AND SEQUENCE OF CONSTRUCTION OPERATIONS ARE REQUIRED PRIOR TO PERMIT. TR-1 ISSUED BY SCA LAB.

# PROGRESS INSPECTIONS

PROGRESS INSPECTIONS REQUIRED IN ACCORDANCE WITH CHAPTER 1 OF THE 2022 NYC BUILDING CODE AND THE APPLICABLE SECTIONS OF THE NYC CONSTRUCTION CODE ARE LISTED IN THE FOLLOWING TABLES:

THE CONTRACTOR MUST NOTIFY THE ARCHITECT OR ENGINEER FOR PROGRESS INSPECTIONS AT LEAST 72 HOURS BEFORE THE SPECIFIC WORK COMMENCES OR REQUIRES INSPECTION.

THE "AUTHORITY" SHALL BE RESPONSIBLE FOR THE FOLLOWING PROGRESS INSPECTIONS:

28-116.2.4.2 AND BC 110.5

# **PROVISIONS:**

THE FOLLOWING ITEMS ARE TO BE INCLUDED IN THE BID. THE QUANTITIES PROVIDED ARE IN ADDITION TO THOSE INDICATED ELSEWHERE IN THE DOCUMENTS. INCLUDE THE COST OF ALL MEANS (SCAFFOLDING, LIFTS, ETC.) TO INSTALL THE WORK AT VARIOUS LOCATIONS THROUGHOUT THE BUILDING.

ANY QUANTITY MORE OR LESS WILL BE AN EXTRA/CREDIT TO THE AUTHORITY. PROVIDE SHOP DRAWINGS FOR APPROVAL OF INTENDED AREA OF WORK AFTER INSPECTION FROM THE SCAFFOLDING OR AS DIRECTED BY THE ENGINEER/ARCHITECT OF RECORD, PRIOR TO PROCEEDING WITH WORK.

- 1. SPOT REPOINTING OF MASONRY JOINTS AS PER 2/A401 500 SF.
- REPAIR OF INTERIOR PLASTER WALL SURFACES AS PER 1, 2, 3 & 4/ A701 500 SF
- INTERIOR PAINTING -500 SF
- 4. PROVIDE REPLACEMENT OF CRACKED FACE BRICK AS PER 1&3/A401 1000 BRICKS
- PROVIDE 25 SF AT 2" DEEP OF SPALL STONE REPAIR. AS PER DETAIL 4B/A401
- 6. PROVIDE 25 LF OF CRACKED STONE REPAIR, AS PER DETAIL 4A/A401

## **STATE HISTORIC PRESERVATION OFFICE:**

THIS BUILDING IS DESIGNATED AS ELIGIBLE FOR LISTING ON THE NATIONAL REGISTER OF HISTORICAL PLACES AS DETERMINED BY THE STATE HISTORIC PRESERVATION OFFICE (SHPO).

DRAWING NO.	DRAWING NAME	CONTRACT SET SHEET NO.	DOB SE
T001.00	COVER SHEET	1	1
T001A.00	COMPILED LIST OF DRAWINGS, SPECIAL INSPECTIONS & PROGRESS INSPECTIONS FOR CONTRACT		-
T002.00	SUMMARY OF WORK, GEN. NOTES, SITE SAFETY & PROTECTION NOTES, BUILDING DEPART. NOTES, SPECIAL INSPECTION, PROGRESS INSPECTIONS, PROVISIONS, ALLOWANCES, SHPO & LIST OF DRAWINGS	2	2
T003.00	ABBREVIATIONS, REFERENCE SYMBOLS, ROOFING NOTES, PARAPET/MASONRY NOTES, SITE PLAN & LOCATION PLAN	3	3
TEMPORARY EGRESS PLANS			
TE001.00	TEMPORARY EGRESS LOAD CALCULATIONS NOTES & LEGEND	4	4
TE101.00	PHASE 1 CELLAR FLOOR TEMPORARY EGRESS PLAN	5	5
TE102.00	PHASE 1 BASEMENT FLOOR TEMPORARY EGRESS PLAN	6	6
TE103.00	PHASE 2 BASEMENT FLOOR TEMPORARY EGRESS PLAN	7	7
TE104.00	PHASE 2 FIRST FLOOR TEMPORARY EGRESS PLAN	8	8
TE105.00	PHASE 2 SECOND FLOOR TEMPORARY EGRESS PLAN	9	9
TE106.00	PHASE 2 THIRD FLOOR TEMPORARY EGRESS PLAN	10	10
TE107.00	PHASE 2 FORTH FLOOR TEMPORARY EGRESS PLAN	11	11
ARCHITECTURE			
A030.00	SELECTIVE REMOVAL – SITE PLANS	12	12
A035.00	NEW WORK - SITE PLAN	13	13
A036.00	SITE DETAILS	14	14
A061.00	SELECTIVE REMOVAL ROOF PLAN	15	15
A062.00	SELECTIVE REMOVAL FOURTH FLOOR REFLECTED CEILING PLAN	16	16
A063.00	SELECTIVE REMOVAL - INTERIOR ELEVATIONS - 1	17	17
A064.00	SELECTIVE REMOVAL - INTERIOR ELEVATIONS - 2	18	18
A101.00	NEW WORK - ROOF PLAN	19	19
A201.00	EXTERIOR ELEVATION NORTH	20	20
A202.00	EXTERIOR ELEVATION EAST	21	21
A203.00	EXTERIOR ELEVATION SOUTH	22	22
A204.00	EXTERIOR ELEVATION WEST	23	23
A205.00	EXTERIOR ELEVATIONS COURTYARD-1	24	24
A206.00	EXTERIOR ELEVATIONS COURTYARD-2	25	25
A207.00	PARAPET INTERIOR ELEVATIONS-1	26	26
A208.00	PARAPET INTERIOR ELEVATIONS-2	27	27
A301.00	INTERIOR ELEVATIONS-1	28	28
A302.00	INTERIOR ELEVATIONS-2	29	29
A401.00	MASONRY DETAILS	30	30
A402.00	PILASTERS PLAN DETAILS	31	31
A403.00	PILASTER DETAILS - 1	32	32
A404.00	PILASTER DETAILS - 2	33	33
A405.00	PILASTER DETAILS - 3	34	34
A406.00	COPING DETAILS	35	35
A701.00	INTERIOR DETAILS	36	36
A801.00	REFLECTED CEILING PLAN	37	37
ENVIRONMENTAL		<b>.</b>	<u> </u>
H101.00	ASBESTOS ABATEMENT GENERAL NOTES	38	_
H102.00	ROOF LEVEL - ASBESTOS ABATEMENT PLAN	39	_
H103.00	EXTERIOR FACADE EAST AND WEST COURTYARD ELEVATIONS - ASBESTOS ABATEMENT PLAN	40	-
H104.00	EXTERIOR FACADE SOUTH COURTYARD ELEVATION - ASBESTOS ABATEMENT PLAN	41	
REFERENCE	EXTENSION FOR THE PROPERTY OF	11	
ROO1.00	ZONE OF PUBLIC PROTECTION PLAN (FOR REFERENCE ONLY)	42	
R002.00	FIRE DEPARTMENT ROOF ACCESS PLAN (FOR REFERENCE ONLY)	43	38

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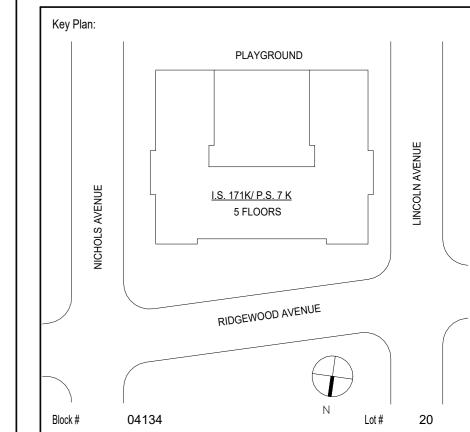
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**Eg** Taylor Environmental Group **Asbestos Consultants** Taylor Environmental Group, Inc. 130A Jericho Turnpike Floral Park, NY 11001 Phone: (516) 358-2955

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04/14/2023 Construction Documents Date Revisions



ASHRAF ELIAS, P.E. SCA Design Manager: DAVID SAMMEL, R.A Project Architect/Engineer: DAVID HUNSBERGER, R.A Discipline Lead: Designer: JUAN SANTOS / JUAN POLANCO **JUAN SANTOS** Drawn by: DAVID SAMMEL, R.A Checked by: Facility Code: Design No or LLW No.: K171 D021557 04/14/2023

> I.S. 171 - BROOKLYN EXTERIOR MASONRY

528 Ridgewood Ave. Brooklyn New York 11208

SUMMARY OF WORK, GEN. NOTES, SITE SAFETY & PROTECTION NOTES, BUILDING DEPART. NOTES, SPECIAL INSPECTION, PROGRESS INSPECTIONS, PROVISIONS, ALLOWANCES, SHPO & LIST OF DRAWINGS

DOB # B00836762 - I1

Sheets in GC Work Type Contract Set:

Sheets in GC Work Type DOB Filing Set:

2 OF 43

2 OF 38

# **ABBREVIATIONS**

-ACCESS DOOR

-ABOVE

DEEN
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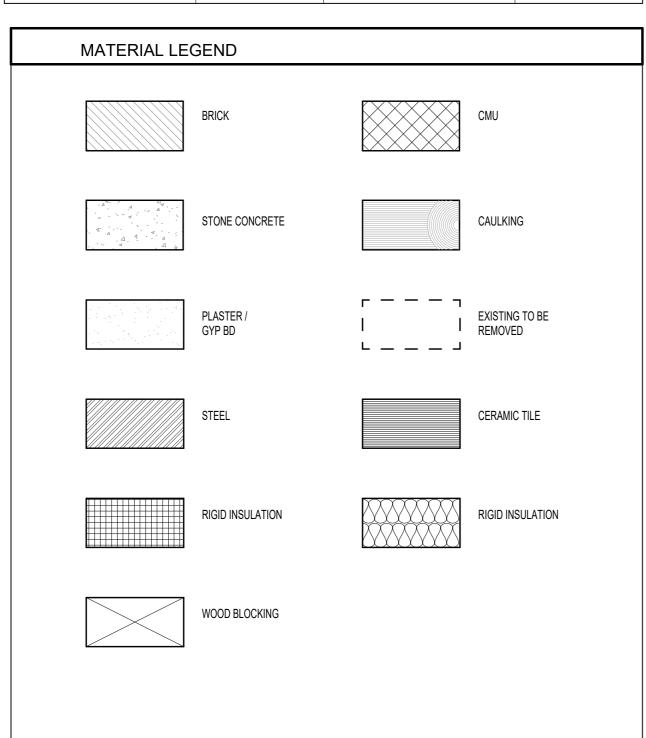
-INTERIOR

-INSTRUCTOR

-OVERFLOW SCUPPER

ELEI EMGE; E.L -E; ENTEI EOR -EI EQE( EQUIPE( E.WE/	LEVATION  XPANDED METAL GUARD  XISTING LEADER TO REMAIN  NTRANCE  NGINEER OR RECORD  QUAL  QUIPMENT	STD. STL. ST.PL. S.L. STRUCT. STD.DET. S.Y.	-SQUARE FEET -STANDARD -STEEL -STEEL PLATE -SECURITY LIGHT -STRUCTURAL -STANDARD DETAIL -SQUARE YARD -STRUCTURAL FACING TILE
EXISTEX	XISTING XTERIOR LECTRICAL CONDUIT	T.O.S. T.W.	-THICKNESS -TOP OF SLAB -TOP OF WALL -TYPICAL
F.B.RF/ FINFI FLFI	ACE BRICK REPLACEMENT INISH LOOR	T.C. <u>U</u>	-TERRA COTTA -UNIT VENTILATOR
F.A.IFf F.PFI	RESH AIR INTAKE IREPROOFING RAME	U.O.N. <u>∨</u>	-UNLESS OTHERWISE NOTED
GALVG G.B.W -G	SAUGE SALVANIZED	VERT. V.I.F. V.	-VENTILATOR -VERTICAL -VERIFY IN FIELD -VENT -VERTICAL CRACK
G.IG. GLG GRNTG	ALVANIZED IRON BLASS BRANITE	WO. W.F	-WITH -WOOD -WIRE FENCE (OR) WIDE FLANGE
HDCP -H, HGTHI H.MHI HORIZHI H.PHI	ORIZONTAL CRACK IANDICAPPED IEIGHT IOLLOW METAL ORIZONTAL	W.I W.M W.M.G W.P WT.	-WEEPHOLE -WROUGHT IRON -WIRE MESH -WIRE MESH GUARD -WATERPROOFING -WEIGHT -WELDED WIRE FABRIC

MBOLS	DESCRIPTION	SYMBOLS	DESCRIPTION
A PARTITION TYPE 1 HOUR RATING	PARTITION TAG		EXISTING TO REMAIN
XXX DOOR NUMBER	DOORS		EXISTING TO BE
WORK SCOPE NUMBER	WORK SCOPE NOTE		REMOVED
4 A205	DETAILS		EXISTING DOOR, FRAN & ASSOCIATED HARDWARE TO REMAI
DRAWING NUMBER SHEET NUMBER	SECTIONS		EXISTING DOOR, FRAM ASSOCIATED HARDWA TO REMAIN
1 DRAWING NUMBER A205 SHEET NUMBER	EXTERIOR ELEVATIONS		
# DRAWING NUMBER # A205 SHEET NUMBER	INTERIOR ELEVATIONS		NEW DOOR, FRAME & ASSOCIATED HARDWARE TO REMAI
1	DRAWING REVISONS	OFFICE = ROOM NAME  123A = ROOM NUMBER	EXISTING ROOM
(12) (A)	COLUMN GRID	ROOM NUMBER ROOM NAME  NET SQUARE FOOTAGE NUMBER OF OCCUPANTS  OCCUPANCY CLASS	ROOM DATA
		FD	EL COD DDAIN
S#	SIGNAGE TAG (SEE SHEET A930)		FLOOR DRAIN
S00	TOILET & LOCKERS LEGEND TAG	RD	ROOF DRAIN
#EX" - DENOTES EXISTING	NEW DUPLEX OUTLET		VENT STACK
"EX" - DENOTES EXISTING	NEW TELEPHONE OUTLET	CJ	CONTROL JOINT
(FINISH)	ROOM FINISH (SEE FINISH SCHEDULE SHEET A910)		



# **CONCRETE NOTES**

# **GENERAL**

- 1. DESIGN IS IN ACCORDANCE WITH THE REQUIREMENTS OF THE NEW YORK CITY BUILDING CODE OF 1968, LOCAL LAW NO. 76, INCLUDING THE LATEST AMENDMENTS.
- 2. VERIFY ALL FIELD DIMENSIONS BY MEASUREMENT AT THE JOB SITE BEFORE SUBMITTING SHOP DRAWINGS.
- 3. DO NOT PLACE CONCRETE WITHOUT APPROVED STRUCTURAL SHOP DRAWINGS.

### CONCRETE - DESIGN

- DESIGN OF REINFORCED CONCRETE MEMBERS IS IN ACCORDANCE WITH THE PROVISIONS OF THE BUILDING CODE REQUIREMENTS FOR REINFORCED CONCRETE (ACI 318-89), AS MODIFIED BY THE NYC BUILDING CODE, USING LOAD FACTORS AND STRENGTH REDUCTION FACTORS.
- 2. CONCRETE FOR REPLACING ROOF FILL SHALL BE AIR-ENTRAINED LIGHTWEIGHT CONCRETE WITH A MINIMUM COMPRESSIVE STRENGTH OF 3500 PSI AT 28 DAYS. ALL OTHER CONCRETE SHALL BE AIR-ENTRAINED NORMAL WEIGHT STONE CONCRETE WITH A MINIMUM COMPRESSIVE STRENGTH OF 4,000 PSI AT 28 DAYS AND A MAXIMUM WATER/CEMENT RATIO OF 0.45 BY WEIGHT (LB. PER LB.)
- 3. ROUGHENED SURFACE AT INTERFACE OF SEPARATE CONCRETE POURS (JOINTS) SHALL BE PREPARED AS FOLLOWS:
  - a. ROUGHEN SURFACE TO A FULL AMPLITUDE OF APPROXIMATELY 1/4" WITH STIFF BROOM AFTER INITIAL SET.
  - b. BEFORE PLACING FRESH CONCRETE, CLEAN SURFACE AND REMOVE LAITANCE WITH WIRE BRUSH.
  - IMMEDIATELY BEFORE NEW CONCRETE IS PLACED, WET SURFACE AND REMOVE STANDING WATER.

# CONCRETE REINFORCEMENT


- ALL REINFORCING BARS SHALL BE DEFORMED BILLET STEEL BARS AND SHALL CONFORM TO ASTM A615 GRADE 60. REINFORCEMENT TO BE WELDED SHALL CONFORM TO ASTM A706, GRADE 60. WELDED WIRE FABRIC (WIRE MESH) SHALL CONFORM TO ASTM A185. PROVIDE EPOXY-COATED REINFORCEMENT IN ACCORDANCE WITH ASTM A775 FOR STEEL BARS AND ASTM A933 FOR WIRE MESH FOR CONCRETE EXPOSED TO THE ELEMENTS.
- THE CONTRACTOR SHALL SUBMIT CHECKED SHOP DRAWINGS CONSISTING OF COMPLETE PLANS AND DETAILS OF REINFORCEMENT, LOCATIONS OF POUR LINES, CONSTRUCTION JOINTS, ETC. FOR APPROVAL BEFORE PROCEEDING WITH THE WORK.
- ALL DETAILING, FABRICATION AND ERECTION OF REINFORCING BARS SHALL COMPLY WITH THE REQUIREMENTS OF ACI 315 AND ACI 318-89, CHAPTERS 7 AND 12.
- ALL SPLICES SHALL BE IN ACCORDANCE WITH ACI 318-89, CHAPTER 12. THE LOCATIONS SHALL BE INDICATED ON THE SHOP DRAWINGS AND APPROVED BY THE ENGINEER OF RECORD. GENERALLY, ALL SPLICES SHALL BE STAGGERED AND LOCATED AWAY FROM THE SECTION OF MAXIMUM TENSILE STRESS.
- ALL REINFORCEMENT SHALL BE ACCURATELY PLACED AND SECURELY WIRED TO PREVENT DISLOCATION FROM PROPER POSITION.
- PROVIDE CHAIRS FOR SUPPORT OF ALL REINFORCEMENT, LIFTING OF BARS OR MESH DURING PLACEMENT OF CONCRETE IS NOT PERMITTED.
- WHERE NOT OTHERWISE INDICATED, PROVIDE A MINIMUM OF 2-#5 BARS TOP AND BOTTOM AT ALL SIDES OF UNFRAMED OPENINGS.


# **ROOFING NOTES**

THE GENERAL CONTRACTOR IS RESPONSIBLE FOR PROTECTION OF ROOFING AND DOE PROPERTIES AT ALL TIMES DURING THE WORK OF THIS CONTRACT. THE CONTRACTOR SHALL PROTECT CUT PORTIONS OF THE ROOF, REMOVE TEMPORARY PROTECTION PRIOR TO INSTALLATION OF BASE SHEETS.

# PARAPET/MASONRY NOTES

- 1. ALL CELLS IN THE HOLLOW MASONRY WALLS AND ALL JOINTS IN SOLID, CAVITY OR MASONRY BONDED HOLLOW WALL CONSTRUCTION SHALL BE FILLED SOLID WITH MORTAR. ALL CORNERS OF MASONRY PARAPET WALLS SHALL BE REINFORCED WITH JOINT REINFORCEMENT OR ITS EQUIVALENT AT VERTICAL INTERVALS NOT GREATER THAN 12 INCHES. SUCH REINFORCEMENT SHALL EXTEND AROUND THE CORNER FOR AT LEAST 4 FEET IN BOTH DIRECTIONS AND SPLICE SHALL BE LAPPED AT LEAST 6" IN COMPLIANCE WITH REFERENCE STANDARD RS-10-1A SECTION 10.4 OF THE 1968 N.Y.C. BUILDING CODE.
- FACE BRICKS SHALL COMPLY WITH REQUIREMENTS OF ASTM C216. MORTAR SHALL COMPLY WITH ASTM C270 AND BIA M1-88. THE USE OF MASONRY CEMENT IS PROHIBITED.
- 3. AFTER REMOVAL OF MASONRY, REPAIR BACK-UP BY REMOVING LOOSE MATERIAL AND FILLING IN ALL OPEN JOINTS AND VOIDS. WHEN REBUILDING, COLLAR JOINTS, HEAD AND BED JOINTS ARE TO BE FILLED COMPLETELY.
- 4. PROTECT OPEN PARAPETS AND OTHER AREAS OF MASONRY REMOVAL FROM WATER PENETRATION.
- 5. DO NOT REMOVE PARAPETS OR OTHER MASONRY UNTIL NEW BRICKS ARE ON SITE. SUBMIT SHOP DRAWINGS FOR APPROVAL AT EACH AREA OF POINTING OF BRICK AND STONE JOINTS, AND BRICK REPAIR WORK FOR LOCATIONS AND EXTENT OF WORK PRIOR TO START OF WORK.

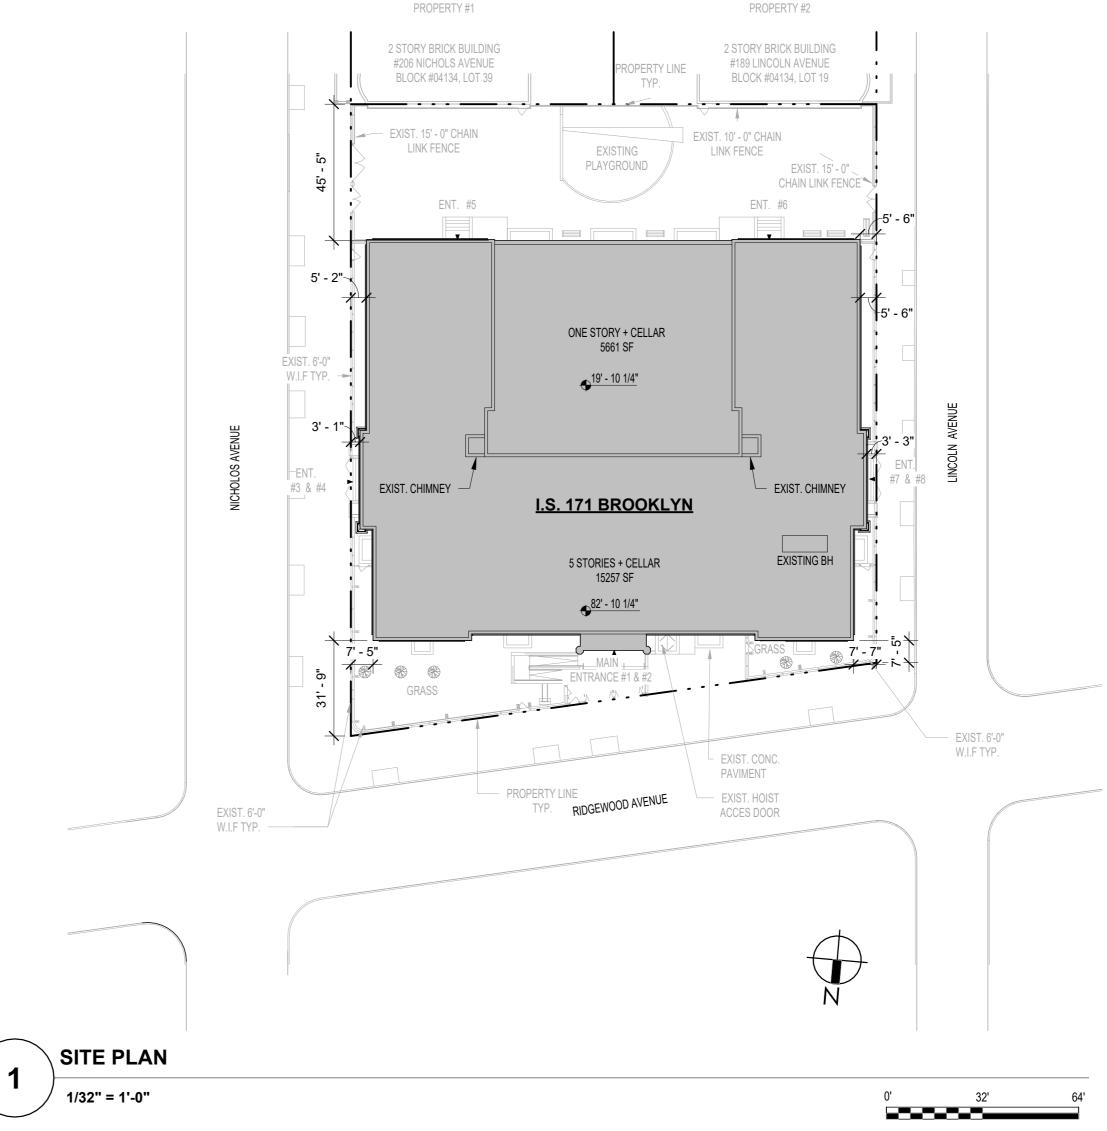

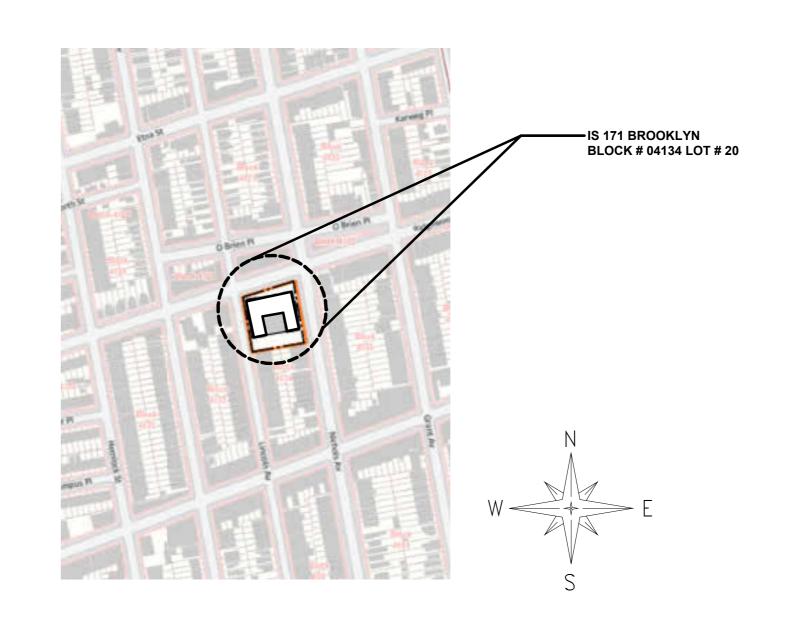

LOCATION PLAN

President & CEO A. Nina Kubota

Peter McCree

**Board of Trustees** Chancellor David C. Banks, Chairman Lorraine Grillo



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Consultants: 2875 ROUTE 35, SUITE 7S-1

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Drawing may be printed at reduced scale

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04/14/2023 Construction Documents Date Revisions Key Plan: PLAYGROUND I.S. 171K/ P.S. 7 K 5 FLOORS RIDGEWOOD AVENUE

Block # Lot# ASHRAF ELIAS, P.E SCA Design Manager: DAVID SAMMEL, R.A Project Architect/Engineer: DAVID HUNSBERGER, R.A Discipline Lead: JUAN SANTOS / JUAN POLANCO Designer: JUAN SANTOS Drawn by: DAVID SAMMEL, R.A Checked by: Facility Code: Design No or LLW No.: K171 D021557 04/14/2023

> I.S. 171 - BROOKLYN **EXTERIOR MASONRY**

528 Ridgewood Ave. Brooklyn New York 11208

ABBREVIATIONS, REFERENCE SYMBOLS, ROOFING NOTES, PARAPET/MASONRY NOTES, SITE PLAN & LOCATION PLAN


DOB # B00836762 - I1

T003.00

Sheets in GC Work Type Contract Set : 3 OF 43

Sheets in GC Work Type DOB Filing Set: 3 OF 38

PLANS ARE REPRODUCED FROM AN SCA RECORD SET. THE AREA OF WORK HAS BEEN VERIFIED TO MATCH THIS REFERENCE DRAWINGS

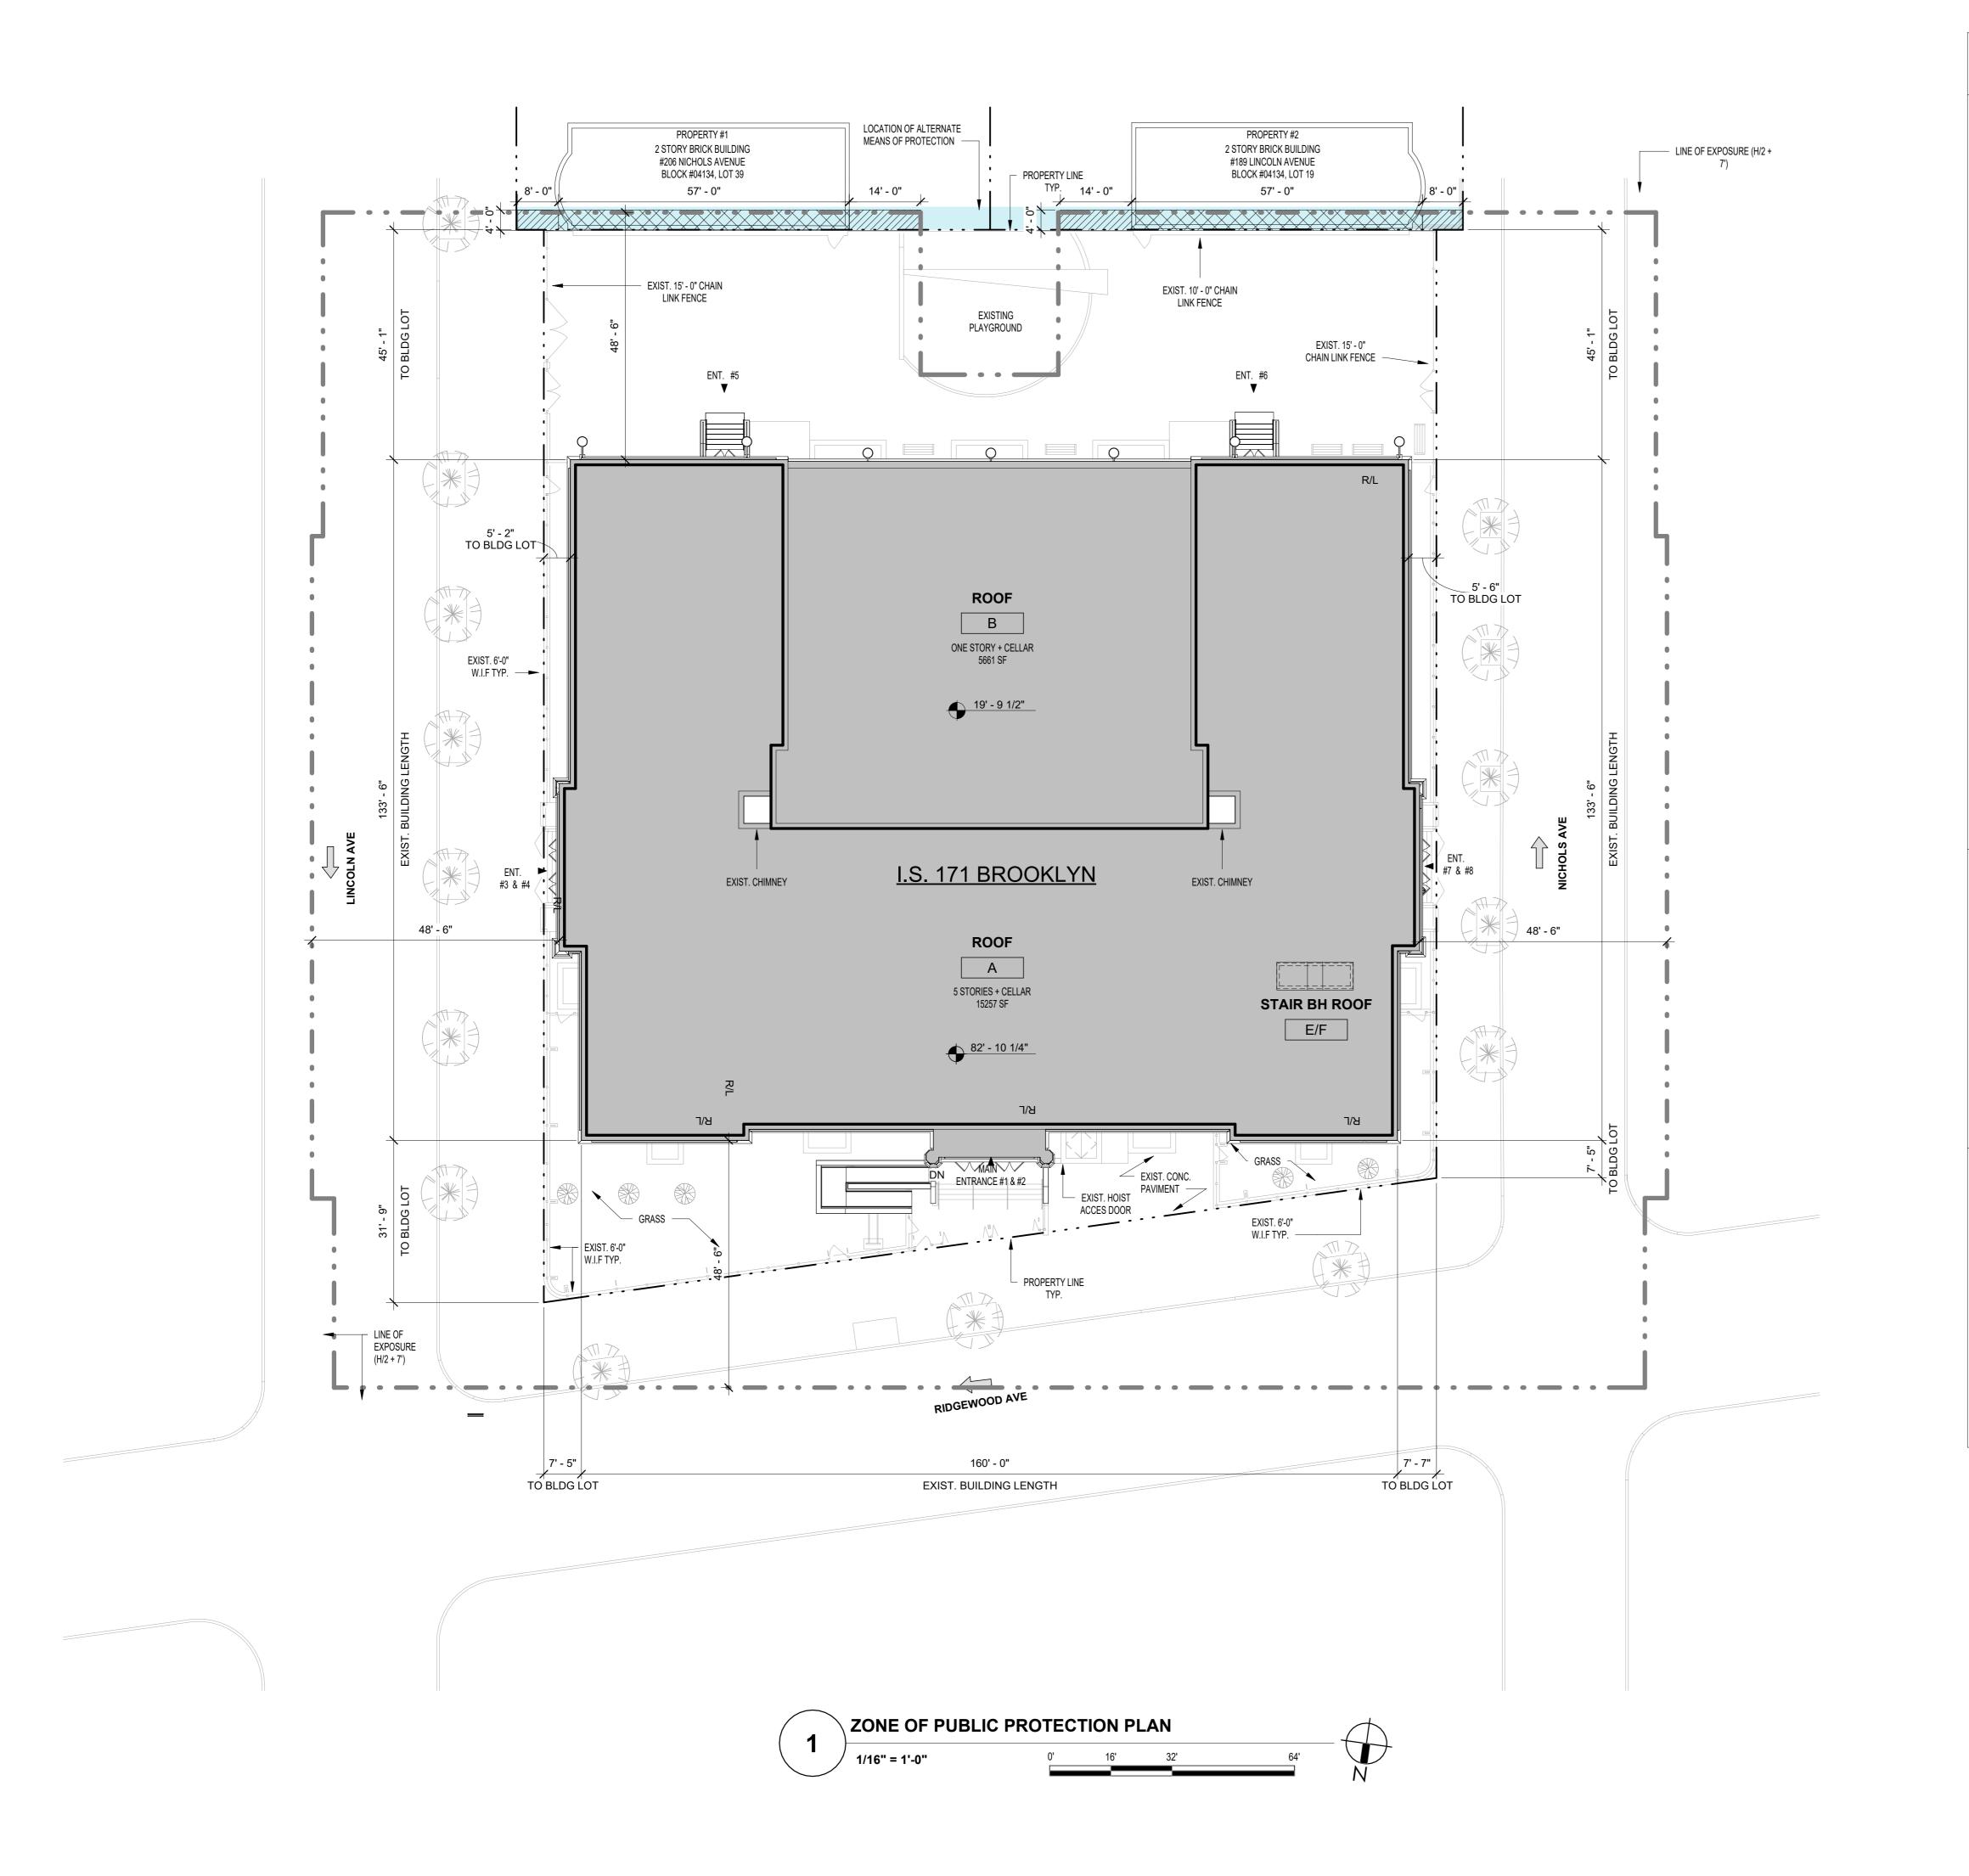

# **LEGEND**:

— · · · — PROPERTY LINE



**EXISTING TREE** 



**EXISTING TREE/ TREE PIT** 





EXISTING SHRUBS OR SMALL TREES



PUBLIC PROJECTION ZONE = 1/2" HEIGHT OF THE BUILDING

SUBJECT BUILDING



**BUILDING EXITS** 

AT ROOF + 7' - 0"



SHED PROTECTION

SHED PROTECTION IS REQUIRED ON NEIGHBORS BACKYARDS TO PROTECT THE FALL ZONE.



**ROOF PROTECTION** 

ROOF AND WINDOW PROTECTION IS REQUIRED ON NEIGHBORS BUILDINGS TO PROTECT THE FALL ZONE.



ALTERNATE MEANS OF PROTECTION REQUIRED

# NOTES:

1. THIS IS A REFERENCE DRAWING AND IS MEANT FOR LICENSING AGREEMENT ONLY AND SHALL BE SUPERSEDED BY THE SITE SAFETY PLAN SUBMITTED BY THE CONTRACTOR.

2. THE SITE SAFETY REQUIREMENTS WITHIN THE PROPERTY LINE WILL BE SHOWN ON THE CONTRACTOR'S SITE SAFETY PLAN AND SHALL NOT BE SHOWN ON THIS DRAWINGS.

3. CONTRACTOR IS RESPONSIBLE TO FILE FOR ALTERNATE MEANS OF PROTECTION AT LOCATIONS SHOWN ON THIS DRAWINGS

# **SCOPE OF WORK:**

1. PARAPETS: A. REPOINT EXISTING INTERIOR BRICK PARAPETS. B. REPLACE SEALANT AT COPINGS AND EXPANSION JOINTS.

C.PROVIDE CLEAR BREATHABLE MASONRY SEALANT. D. REPLACE PILASTER COPING & FLASHING.

# 2. EXTERIOR MASONRY:

A. REPOINT EXTERIOR BRICK MASONRY B. REPLACE CRACKED EXTERIOR FACE BRICK C.REPLACE EXP. JT. EXTERIOR SEALANTS. D.REPAIR CRACKS AND SPALLS IN STONE CORNICE.

President & CEO A. Nina Kubota

> Lorraine Grillo Peter McCree

**Board of Trustees** Chancellor David C. Banks, Chairman



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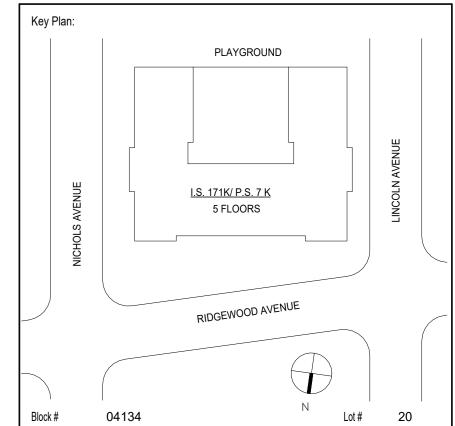
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04/14/2023 Construction Documents Date Revisions



ASHRAF ELIAS, P.E SCA Design Manager: DAVID SAMMEL, R.A Project Architect/Engineer: DAVID HUNSBERGER, R.A Discipline Lead: Designer: JUAN POLANCO ANA LIDIA LARA Drawn by: DAVID SAMMEL, R.A Checked by: Facility Code: Design No or LLW No.: K171 D021557 04/14/2023

> I.S. 171 - BROOKLYN **EXTERIOR MASONRY**

528 Ridgewood Ave.

Brooklyn New York 11208

ZONE OF PUBLIC PROTECTION PLAN (FOR REFERENCE ONLY)


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Sheets in GC Work Type Contract Set : 42 OF 43

Sheets in GC Work Type DOB Filing Set:


- OF 38



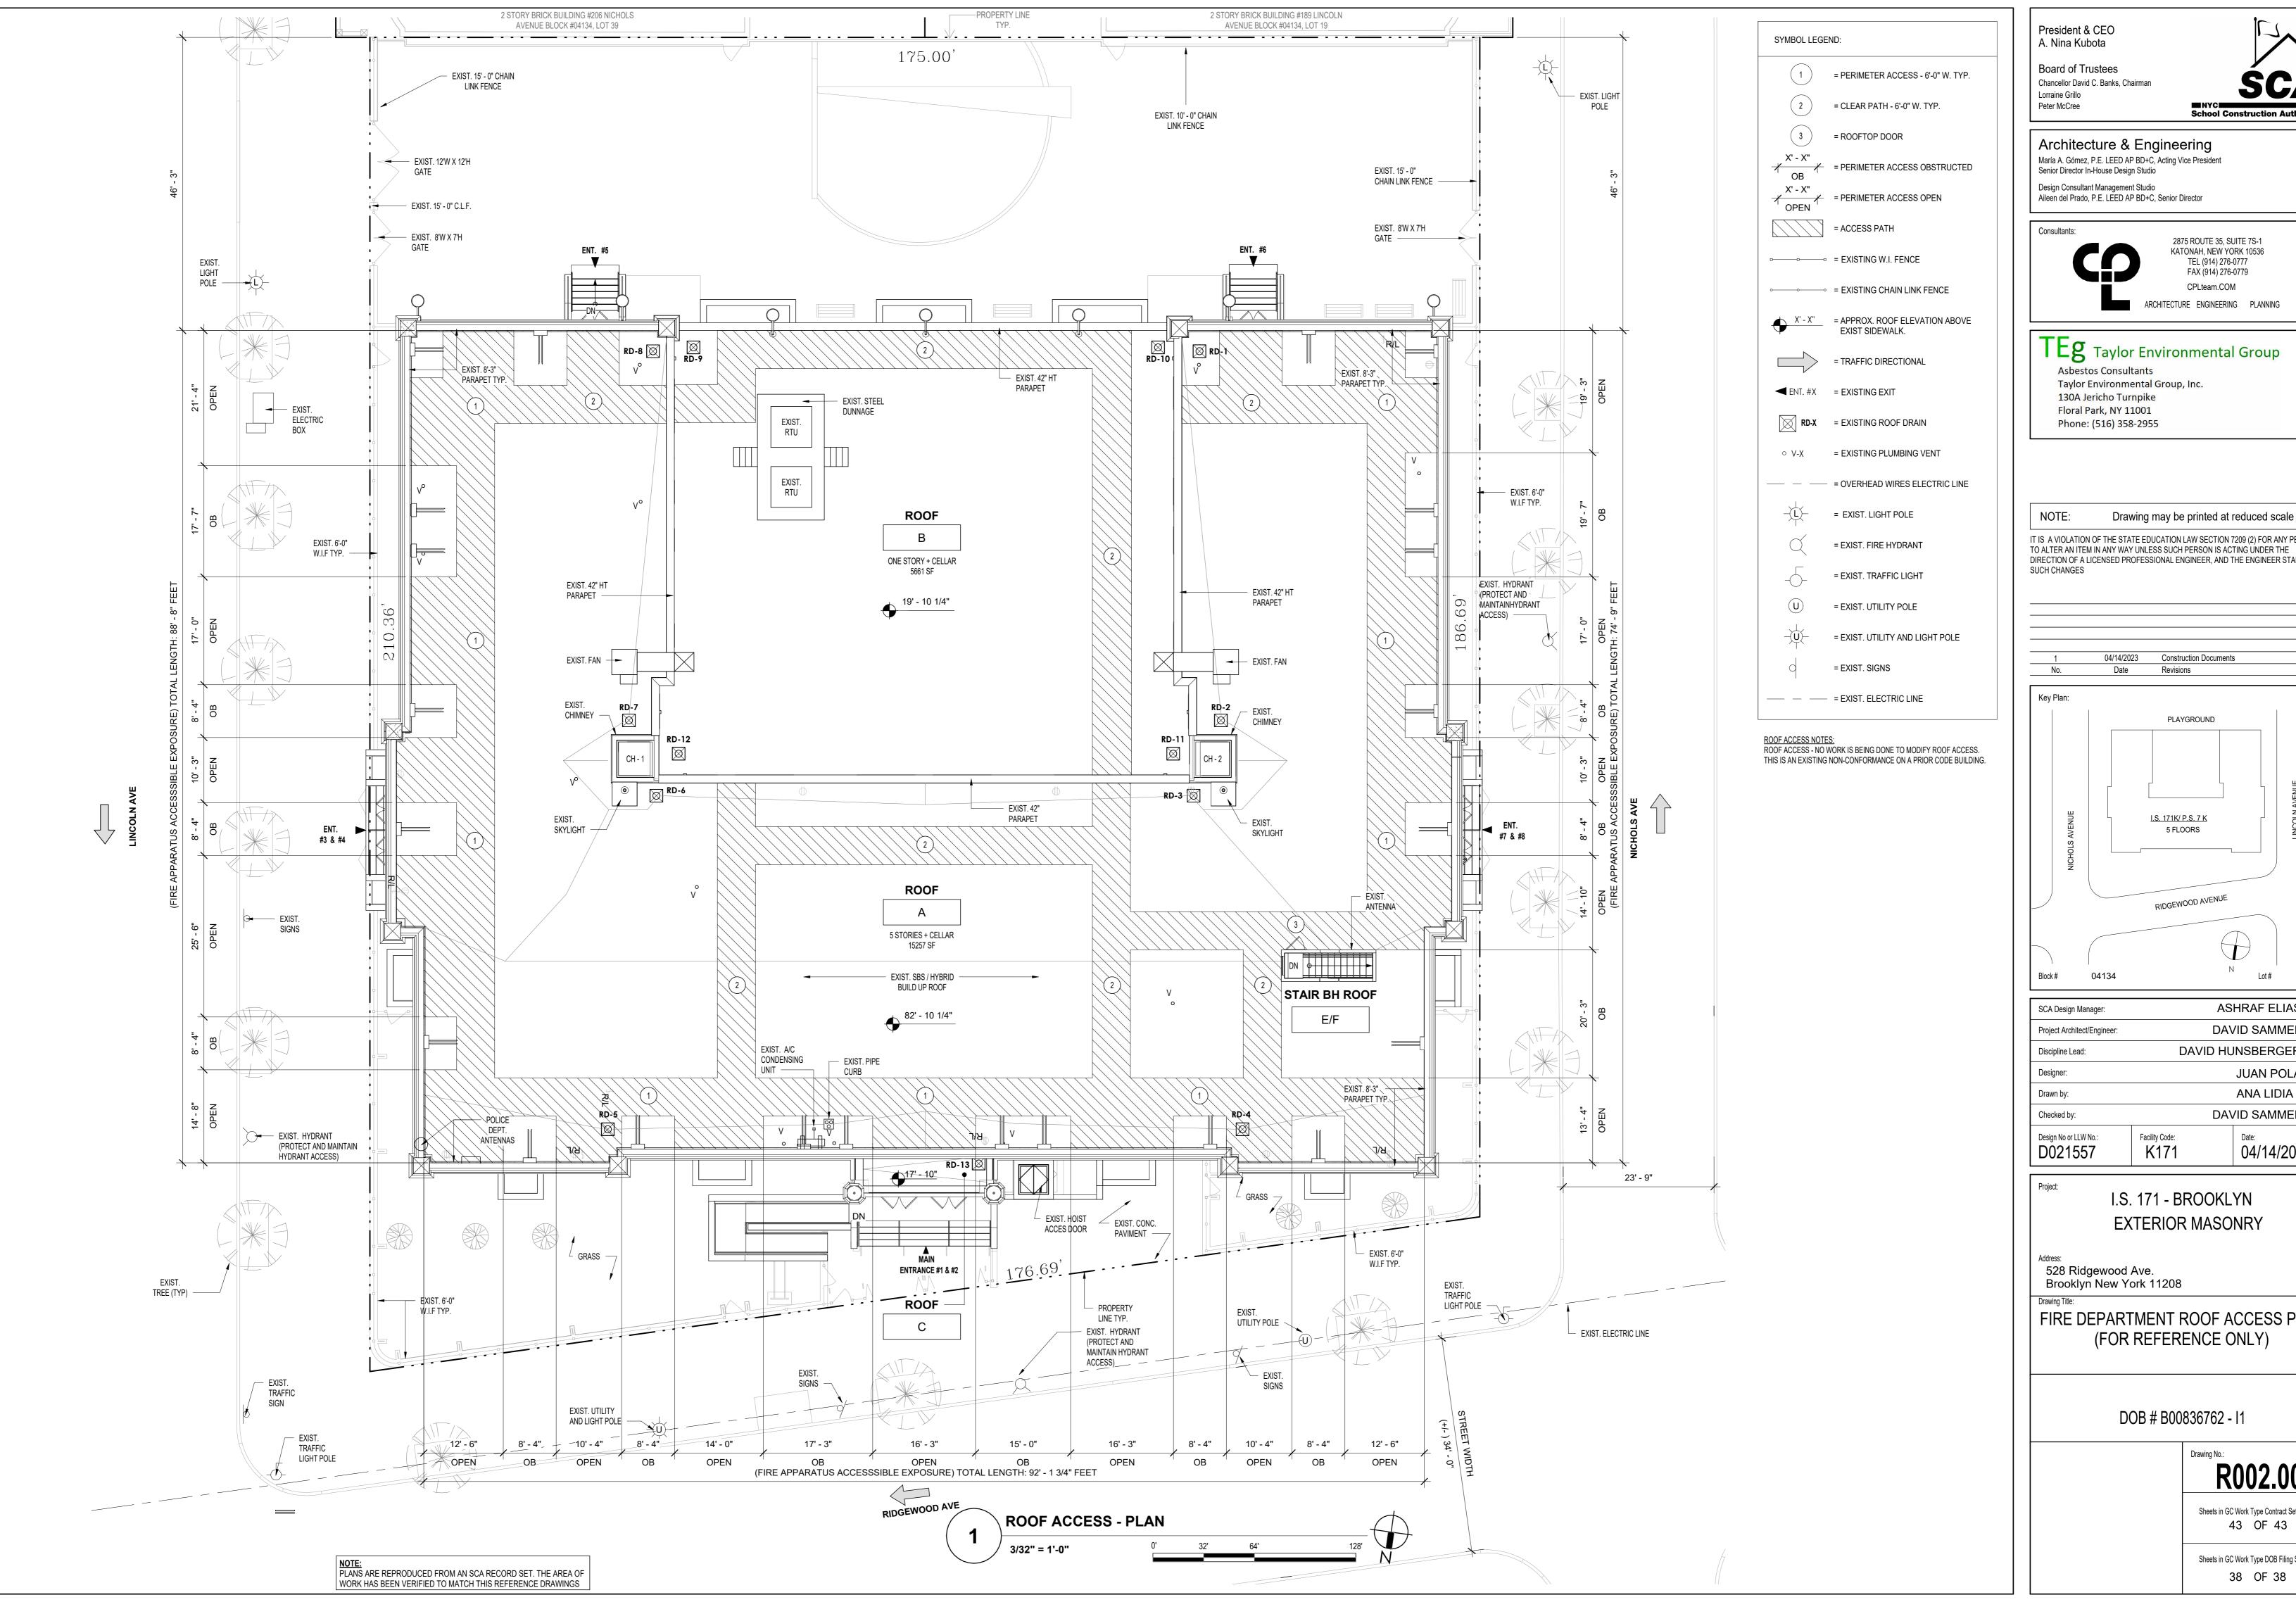

ARCHITECTURE ENGINEERING PLANNING

IT IS A VIOLATION OF THE STATE EDUCATION LAW SECTION 7209 (2) FOR ANY PERSON TO ALTER AN ITEM IN ANY WAY UNLESS SUCH PERSON IS ACTING UNDER THE DIRECTION OF A LICENSED PROFESSIONAL ENGINEER, AND THE ENGINEER STAMPS

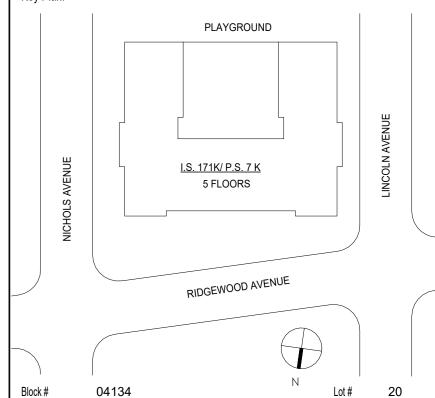

ASHRAF ELIAS, P.E DAVID SAMMEL, R.A DAVID HUNSBERGER, R.A JUAN POLANCO ANA LIDIA LARA DAVID SAMMEL, R.A 04/14/2023


**EXTERIOR MASONRY** 

FIRE DEPARTMENT ROOF ACCESS PLAN (FOR REFERENCE ONLY)

R002.00


Sheets in GC Work Type Contract Set : 43 OF 43

Sheets in GC Work Type DOB Filing Set: 38 OF 38

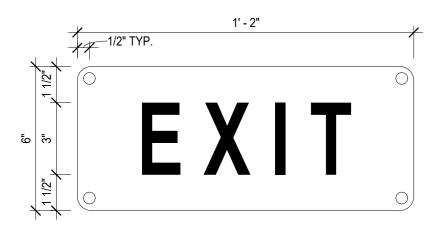

NOTE: SIGNAGE TO BE POSTED @ TEMPORARY EXIT ROUTE AS INDICATED IN PLANS. SEE DETAILS S & S1 FOR TYPICAL NOTES.


TEMPORARY EXIT SIGNAGE

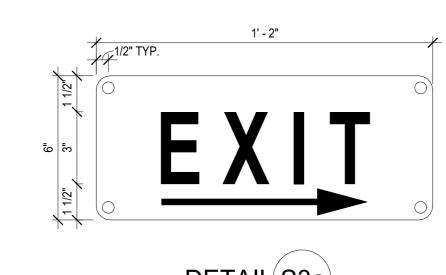

NOTE: SIGNAGE TO BE POSTED @ TEMPORARY EXIT ROUTE AS INDICATED IN PLANS. SEE DETAILS S & S1

FOR TYPICAL NOTES.


TEMPORARY DIRECTIONAL EXIT SIGNAGE

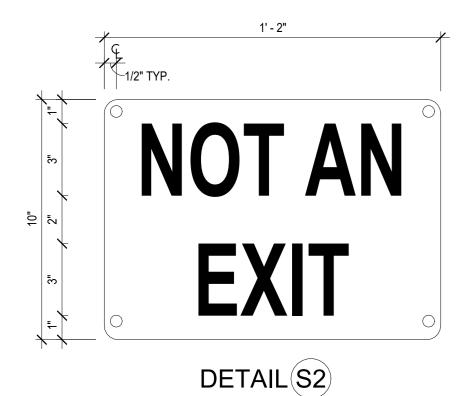

NOTE: SIGNAGE TO BE POSTED @ CORRIDOR DOORS OR OTHER LOCATIONS INDICATED IN PLANS EACH PHASE TO INFORM OCCUPANTS THAT NO AVAILABLE EXIT AT THESE LOCATIONS. SEE DETAILS S & S1 FOR

TEMPORARY EXIT SIGNAGE @ CORRIDOR DOORS

TEMPORARY EXIT CLOSURE SIGNAGE

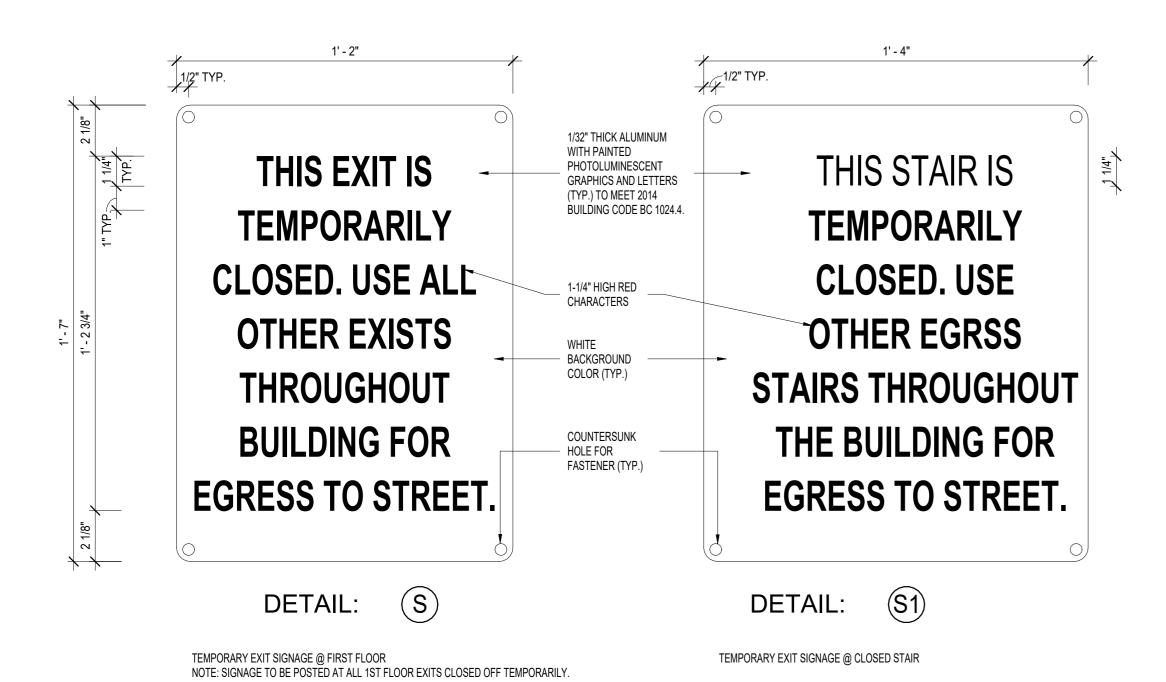

# **LEGEND TEMPORARY EGRESS: TEMPORARY EGRESS & PHASING NOTES:**

ROOM OCCUPANCY TAG OCCUPANCY CLASSIFICATION AREA -NUMBER OF OCCUPANT EGRESS DOOR TAG EGRESS STAIR TAG

DOOR / EXIT ID → DOOR ### STAIR ID ► STAIR ### OCC. PER UNITS OCC. PER UNITS QUANTITY OF 6-INCH UNITS -INCHES PER UNITS CLEAR WIDTH - 3'-0" | 6(25) CLEAR WIDTH - 3'-6" | 22(30) | 150 EGRESS CAPACITY EGRESS CAPACITY PROVIDED -PROVIDED -

EXIT DISCHARGE PUBLIC WAY (S) TEMPORARY EGRESS / SIGNS

(111A) INTERIOR DOOR NUMBER AREA OF TEMPORARY RESTRICTED EGRESS


ROOMS OR SPACES TO COMPLETELY CLOSED (NO OCCUPANCY) PER PHASE EGRESS TRAVEL PATH TEMPORARY DEAD END CORRIDOR **●**·-·→ 125'-0" PER 1938 BC C26-273.0(d)(1) 2ND MEANS OF EGRESS TRAVEL PATH •---->

TRAVEL PATH I.D. TRAVEL PATH #.# DISTANCE DISTANCE -EXISTING EXIT SIGNS 

EXISTING EXIT SIGNS TO BE MASKED DURING THE ASSOCIATED PHASE IF EXIT

TO REMAIN

IS CLOSED

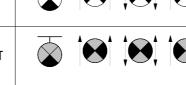

TEMPORARY EGRESS PLANS ARE FILED AND TO BE REVIEWED UNDER 1938

BUILDING CODE. BUILDING OCCUPANCY CALCULATIONS SHOWN PER CERTIFICATE OF OCCUPANCY DATED MONTH DAY YEAR. CALCULATIONS ARE SHOWN ONLY FOR OBTAINING APPROVAL FOR REQUIRED TEMPORARY EGRESS PLAN FOR THE REQUIRED WORK UNDER DOB ##### NO CHANGE TO OCCUPANCY OR BUILDING OCCUPANCY LOAD.

CONTRACTOR TO PERFORM WORK ON ONE EXIT AT A TIME ONLY, NO EXCEPTIONS.

CONTRACTOR TO PROVIDE TO BCC (BUILDING CODE COMPLIANCE DIVISION) LETTER OF CONCURRENCE WITH THIS TEMPORARY EGRESS PLAN PRIOR TO PERMIT.

PHASING ORDER SHOWN ARE FOR REFERENCE ONLY, ACTUAL CONSTRUCTION PHASING ORDER IS UP TO GENERAL CONTRACTOR'S SEQUENCE OF OPERATIONS. GENERAL CONTRACTOR IS TO COORDINATE AND NOTIFY SCA PROJECT OFFICER AND SCHOOL CUSTODIAN ENGINEER THE ACTUAL PHASING ORDER AND SCHEDULE OF PHASED WORK.

CLOSURE OF EXITS SHOWN UNDER THIS APPLICATION ARE TEMPORARY ONLY TO PERFORM WORK INDICATED BELOW.

EXITS 005, 005A, 006 & 006A, VESTIBULE & EXIT 5 AND EXIT 6 STAIRS TO RE REOPENED WHEN WORK HAS BEEN COMPLETED.

EXIT #5 & EXIT #6: REMOVAL OF CONCRETE STAIRS (TREADS, RISERS, AND LANDING) PROVIDED NEW CONCRETE STAIRS (TREADS, RISER, AND LANDING)

ALL PROPOSED WORK AT EXITS AND STAIRS SHOWN ON TEMPORARY EGRESS PLANS (TE - SHEETS ) ARE TO BE PREFORMED ONLY DURING EVENINGS/AFTER HOURS/SUMMER/WEEKENDS WHEN THE BUILDING IN ONLY OCCUPIED BY MAXIMUM OF 20 OCCUPANTS (CUSTODIAL STAFF, CONTRACTOR AND SCA STAFF), NO EXCEPTIONS.

GENERAL CONTRACTOR TO NOTE THAT SOME ROOMS, CLASSROOMS AND P.A. (PUBLIC ASSEMBLY) SPACES WILL NEED TO BE CLOSED (NO OCCUPANCY) ON EACH PHASE TO PERFORM REQUIRED WORK. PRIOR TO CLOSING SELECTED ROOMS AND/OR SPACES GENERAL CONTRACTOR TO COORDINATE THE SCHOOL WITH SCA PROJECT OFFICER, SCHOOL AND SCHOOL CUSTODIAN ENGINEER TO VERIFY SCHOOLS SCHEDULE AND NOT TO INTERFERE SCHOOLS OPERATION.

ALL ROOMS, CLASSROOMS AND P.A. (PUBLIC ASSEMBLY) SPACES INDICATED AS TO BE CLOSED OFF ON EACH PHASE SHALL NOT BE OCCUPIED OR NO OCCUPANCY ALLOWED (NO AFTER HOURS/NO EVENING/NO WEEKEND/ NON NON-SCHOOL DAY/NO HOLIDAY/NO SUMMER CLASSES AND/OR COMMUNITY ACTIVITIES) UNTIL REQUIRED WORK HAS BEEN COMPLETED.

CONTRACTOR TO INCLUDE ALL NECESSARY SIGNAGE WHEN CLOSING AN EXIT OR STAIR. ADD TEMPORARY SIGNS AND MASK EXISTING SIGNS FOR CLEAR DELINEATION. UPON COMPLETION OF A PHASE, REMOVE EXISTING EXIT SIGN MASK OR RETURN TO PREVIOUSLY EXISTING CONDITION & REMOVE TEMPORARY SIGNS. ALL TEMPORARY SIGNAGE TO BE PROVIDED SHALL BE PHOTOLUMINESCENCE TYPE.

ALL NEW DOORS AND HARDWARE THAT ARE TO BE INSTALLED TEMPORARILY TO ACCOMMODATE TEMPORARY EGRESS REQUIREMENTS SHALL BE CAREFULLY REMOVED AND DELIVERED TO SCHOOL CUSTODIAN

AFTER REMOVING TEMPORARY PARTITIONS & SIGNAGE GENERAL CONTRACTOR TO PATCH & REPAIR EXISTING SURFACES, FILL HOLES & PAINT WALLS CORNER TO CORNER FLOOR TO CELING. WALL COLOR IS TO MATCH EXISTING.

President & CEO A. Nina Kubota

Peter McCree

**Board of Trustees** Chancellor David C. Banks, Chairman Lorraine Grillo



Architecture & Engineering

María A. Gómez, P.E. LEED AP BD+C, Acting Vice President Senior Director In-House Design Studio Design Consultant Management Studio

Aileen del Prado, P.E. LEED AP BD+C, Senior Director

Consultants:

KATONAH, NEW YORK 10536 TEL (914) 276-0777 FAX (914) 276-0779 CPLteam.COM ARCHITECTURE ENGINEERING PLANNING


2875 ROUTE 35, SUITE 7S-1

TEG Taylor Environmental Group Asbestos Consultants Taylor Environmental Group, Inc. 130A Jericho Turnpike Floral Park, NY 11001 Phone: (516) 358-2955

Drawing may be printed at reduced scale

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04/14/2023 Construction Documents Date Revisions

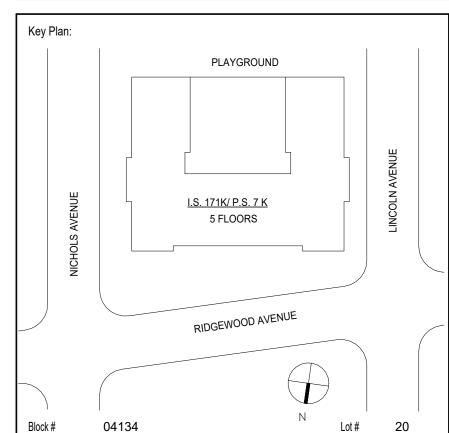

ASHRAF ELIAS, P.E SCA Design Manager: DAVID SAMMEL, R.A Project Architect/Engineer DAVID HUNSBERGER, R.A JUAN SANTOS / JUAN POLANCO JUAN SANTOS DAVID SAMMEL, R.A Checked by: Facility Code: Design No or LLW No.: K171 D021557 04/14/2023

> I.S. 171 - BROOKLYN **EXTERIOR MASONRY**

528 Ridgewood Ave. Brooklyn New York 11208

TEMPORARY EGRESS LOAD **CALCULATIONS NOTES & LEGEND** 


DOB # B00836762 - I1


TE001.00

Sheets in GC Work Type Contract Set: 4 OF 43

Sheets in GC Work Type DOB Filing Set: 4 OF 38

NOTE:
PLANS ARE REPRODUCED FROM AN SCA RECORD SET. THE AREA OF WORK HAS BEEN VERIFIED TO MATCH THIS REFERENCE DRAWINGS

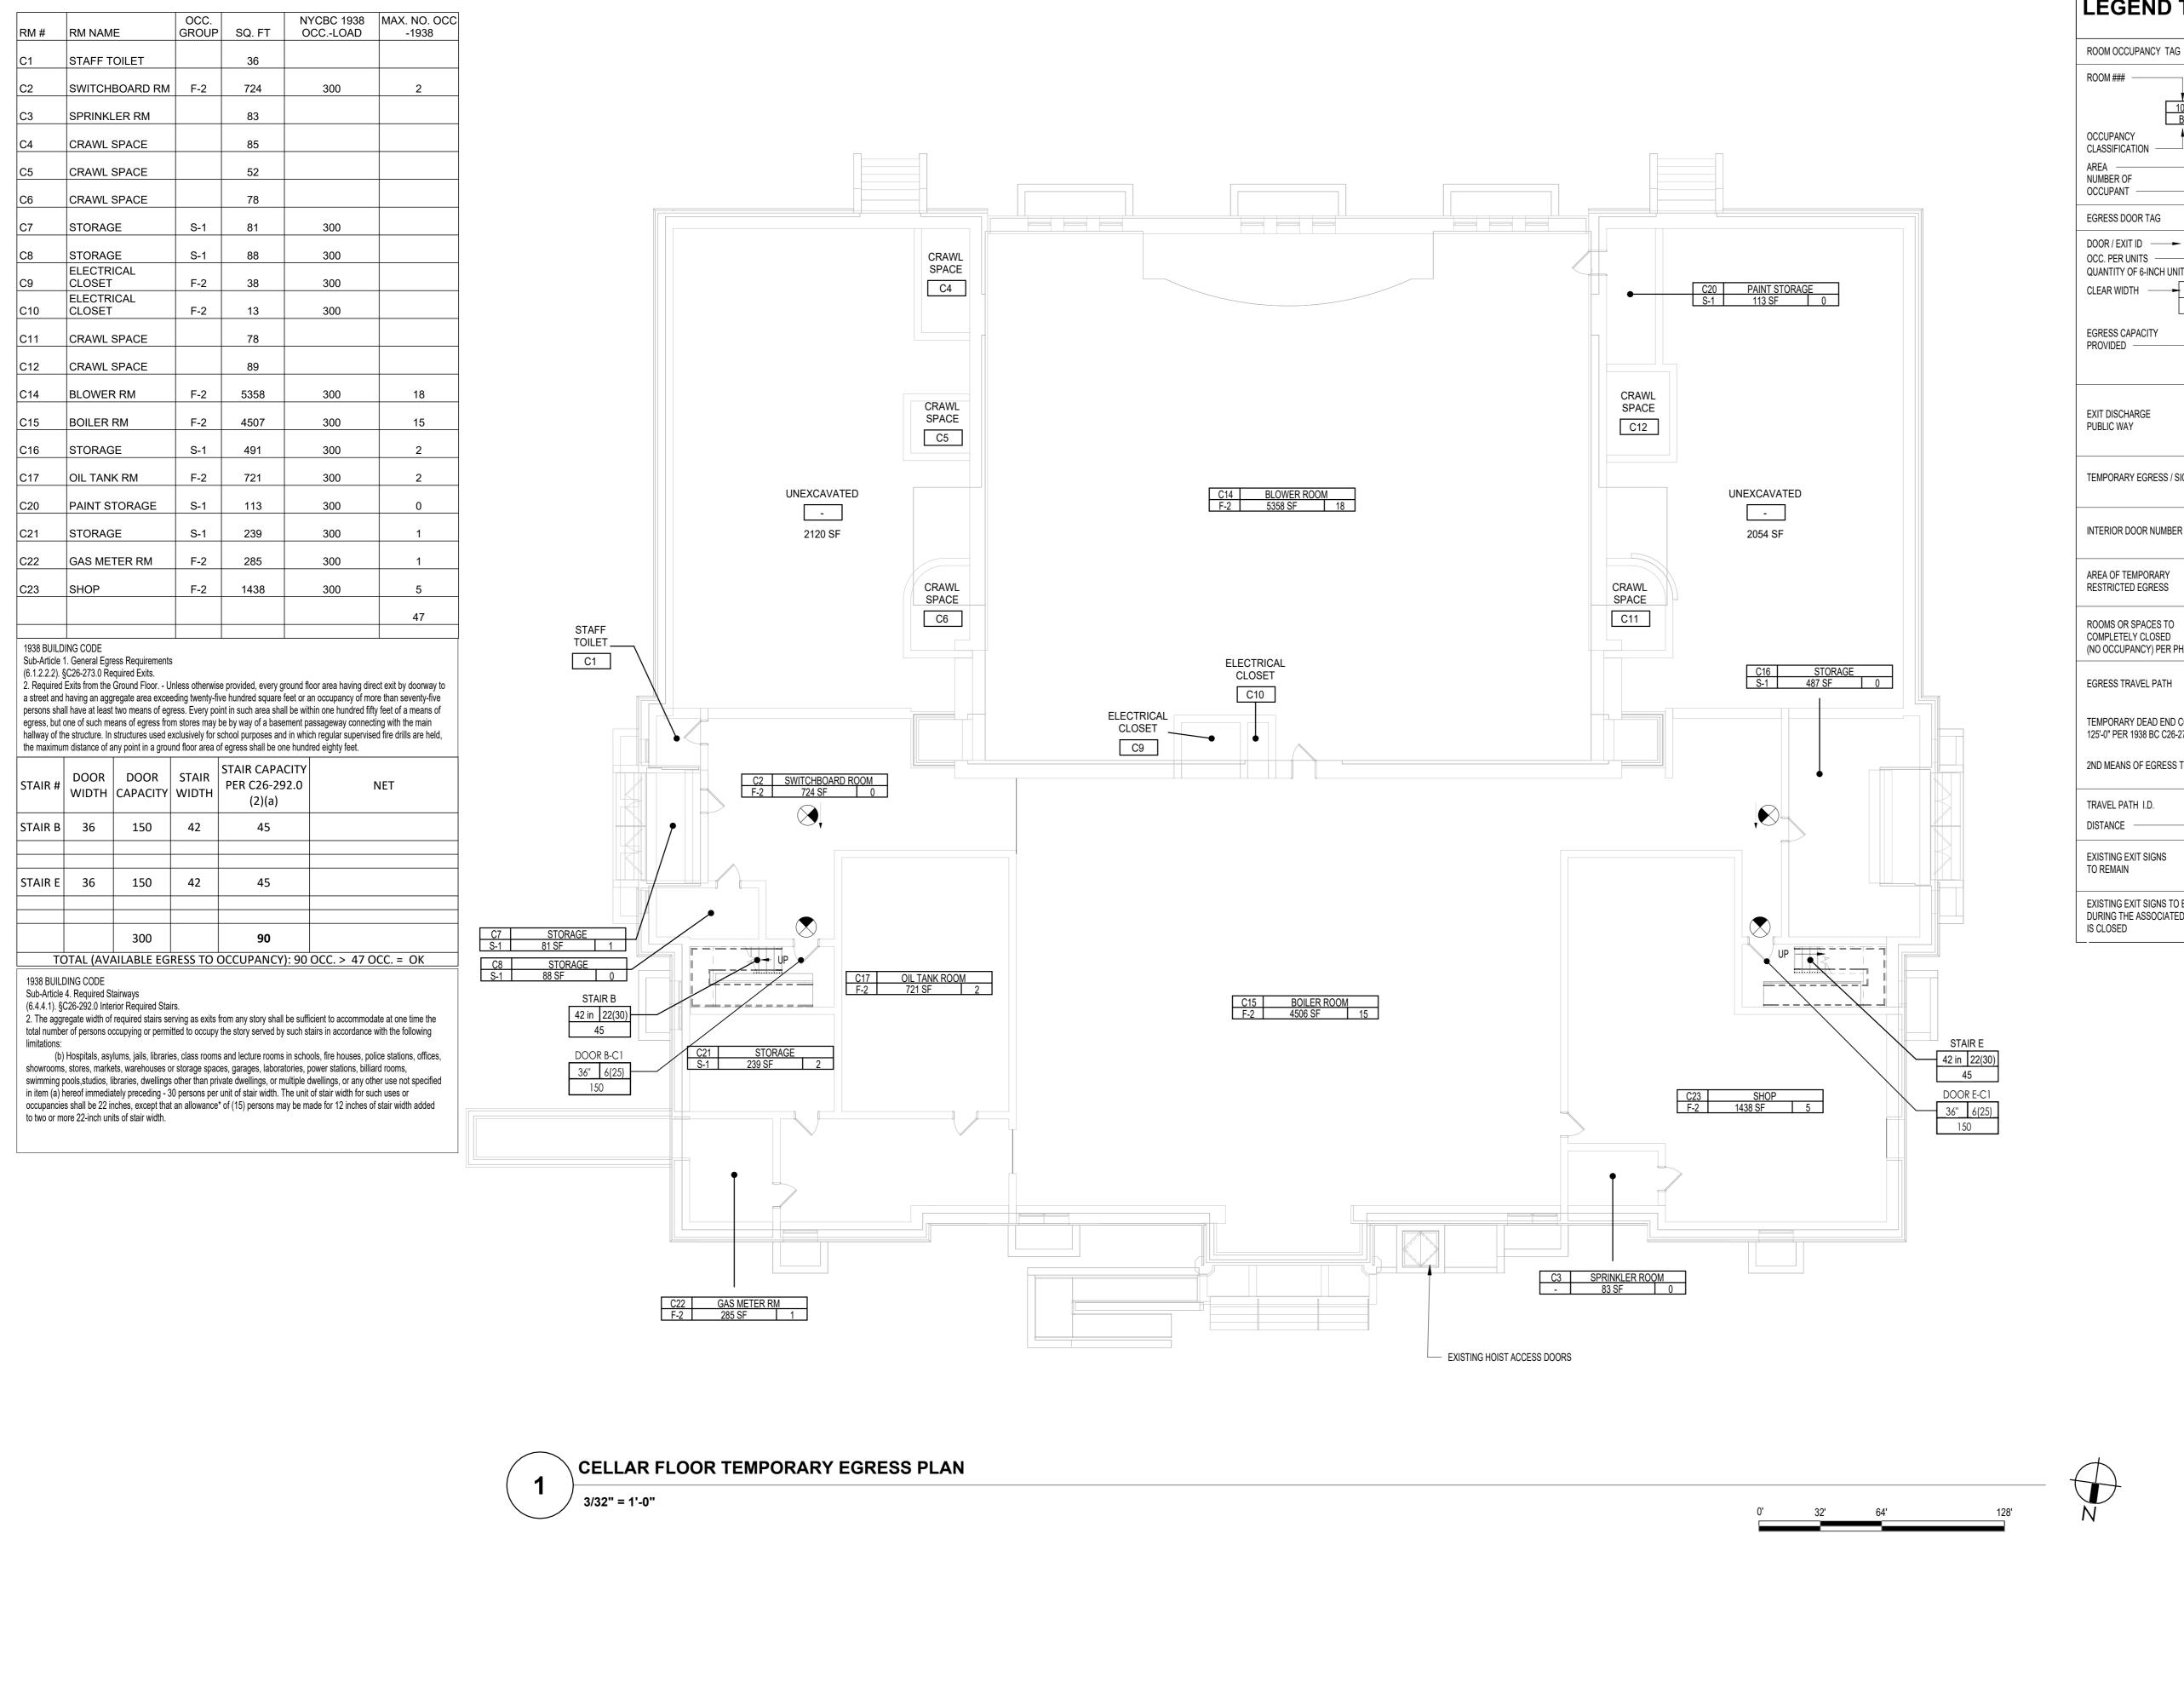

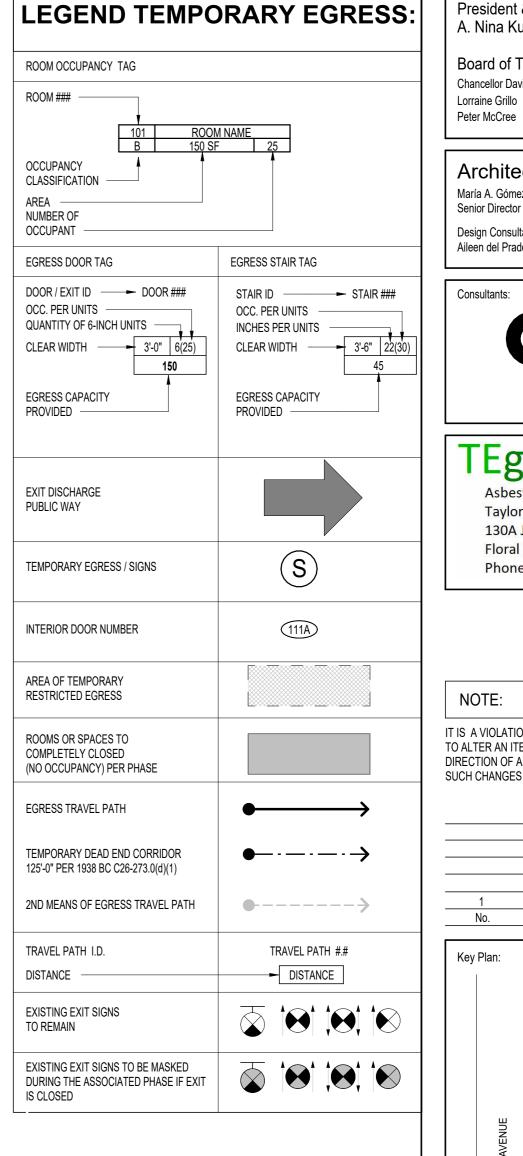

> **Board of Trustees** Chancellor David C. Banks, Chairman



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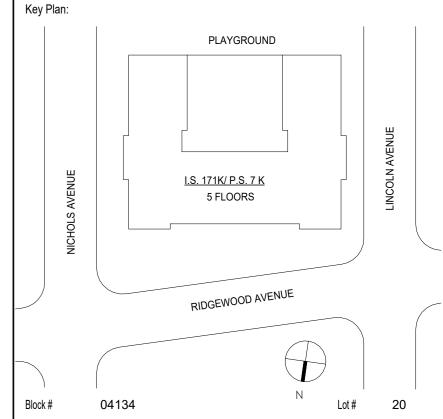
2875 ROUTE 35, SUITE 7S-1 KATONAH, NEW YORK 10536 TEL (914) 276-0777 FAX (914) 276-0779 CPLteam.COM ARCHITECTURE ENGINEERING PLANNING

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04/14/2023 Construction Documents Date Revisions



ASHRAF ELIAS, P.E SCA Design Manager: DAVID SAMMEL, R.A Project Architect/Engineer: DAVID HUNSBERGER, R.A Discipline Lead: Designer: JUAN SANTOS / JUAN POLANCO JUAN SANTOS Drawn by: DAVID SAMMEL, R.A Checked by: Facility Code: Design No or LLW No.: K171 D021557 04/14/2023

> I.S. 171 - BROOKLYN **EXTERIOR MASONRY**

528 Ridgewood Ave. Brooklyn New York 11208

PHASE 1 CELLAR FLOOR TEMPORARY EGRESS PLAN


DOB # B00836762 - I1

TE101.00

Sheets in GC Work Type Contract Set : 5 OF 43

Sheets in GC Work Type DOB Filing Set: 5 OF 38

NOTE:
PLANS ARE REPRODUCED FROM AN SCA RECORD SET. THE AREA OF WORK HAS BEEN VERIFIED TO MATCH THIS REFERENCE DRAWINGS

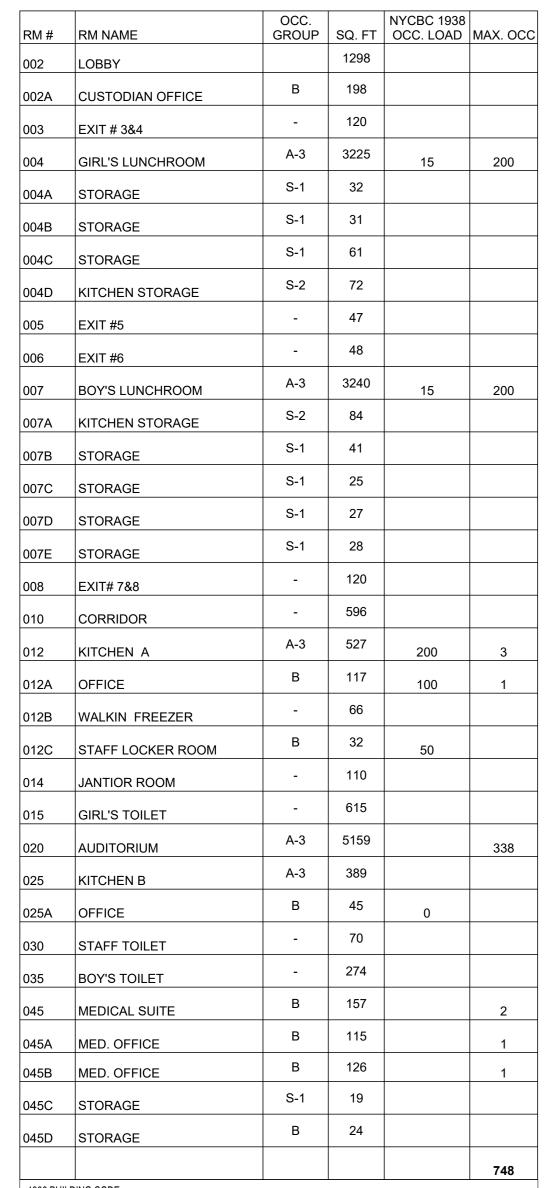

#### 1938 BUILDING CODE Sub-Article 1. General Egress Requirements

(6.1.2.2.2). §C26-273.0 Required Exits.

2. Required Exits from the Ground Floor. - Unless otherwise provided, every ground floor area having direct exit by doorway to a street and having an aggregate area exceeding twenty-five hundred square feet or an occupancy of more than seventy-five persons shall have at least two means of egress. Every point in such area shall be within one hundred fifty feet of a means of egress, but one of such means of egress from stores may be by way of a basement passageway connecting with the main hallway of the structure. In structures used exclusively for school purposes and in which regular supervised fire drills are held, the maximum distance of any point in a ground floor area of egress shall be one hundred eighty feet.


EXIT #	DOOR #	DOOR WIDTH	DOOR CAPACITY
EXIT # 1 & 2	1	86	358
EXIT # 1 & 2	2	86	358
EXIT # 3 & 4	3	72	300
EXIT # 3 & 4	4	72	300
EXIT # 6	6	66	275
EXIT # 7 & 8	7	72	300
EXIT # 7 & 8	8	72	300
			2192

# 1938 BUILDING CODE

Sub-Article 4. Required Stairways (6.4.4.1). §C26-292.0 Interior Required Stairs.

2. The aggregate width of required stairs serving as exits from any story shall be sufficient to accommodate at one time the total number of persons occupying or permitted to occupy the story served by such stairs in accordance with the following

(b) Hospitals, asylums, jails, libraries, class rooms and lecture rooms in schools, fire houses, police stations, offices, showrooms, stores, markets, warehouses or storage spaces, garages, laboratories, power stations, billiard rooms, swimming pools, studios, libraries, dwellings other than private dwellings, or multiple dwellings, or any other use not specified in item (a) hereof immediately preceding - 30 persons per unit of stair width. The unit of stair width for such uses or occupancies shall be 22 inches, except that an allowance\* of (15) persons may be made for 12 inches of stair width added to two or more 22-inch units of stair width.

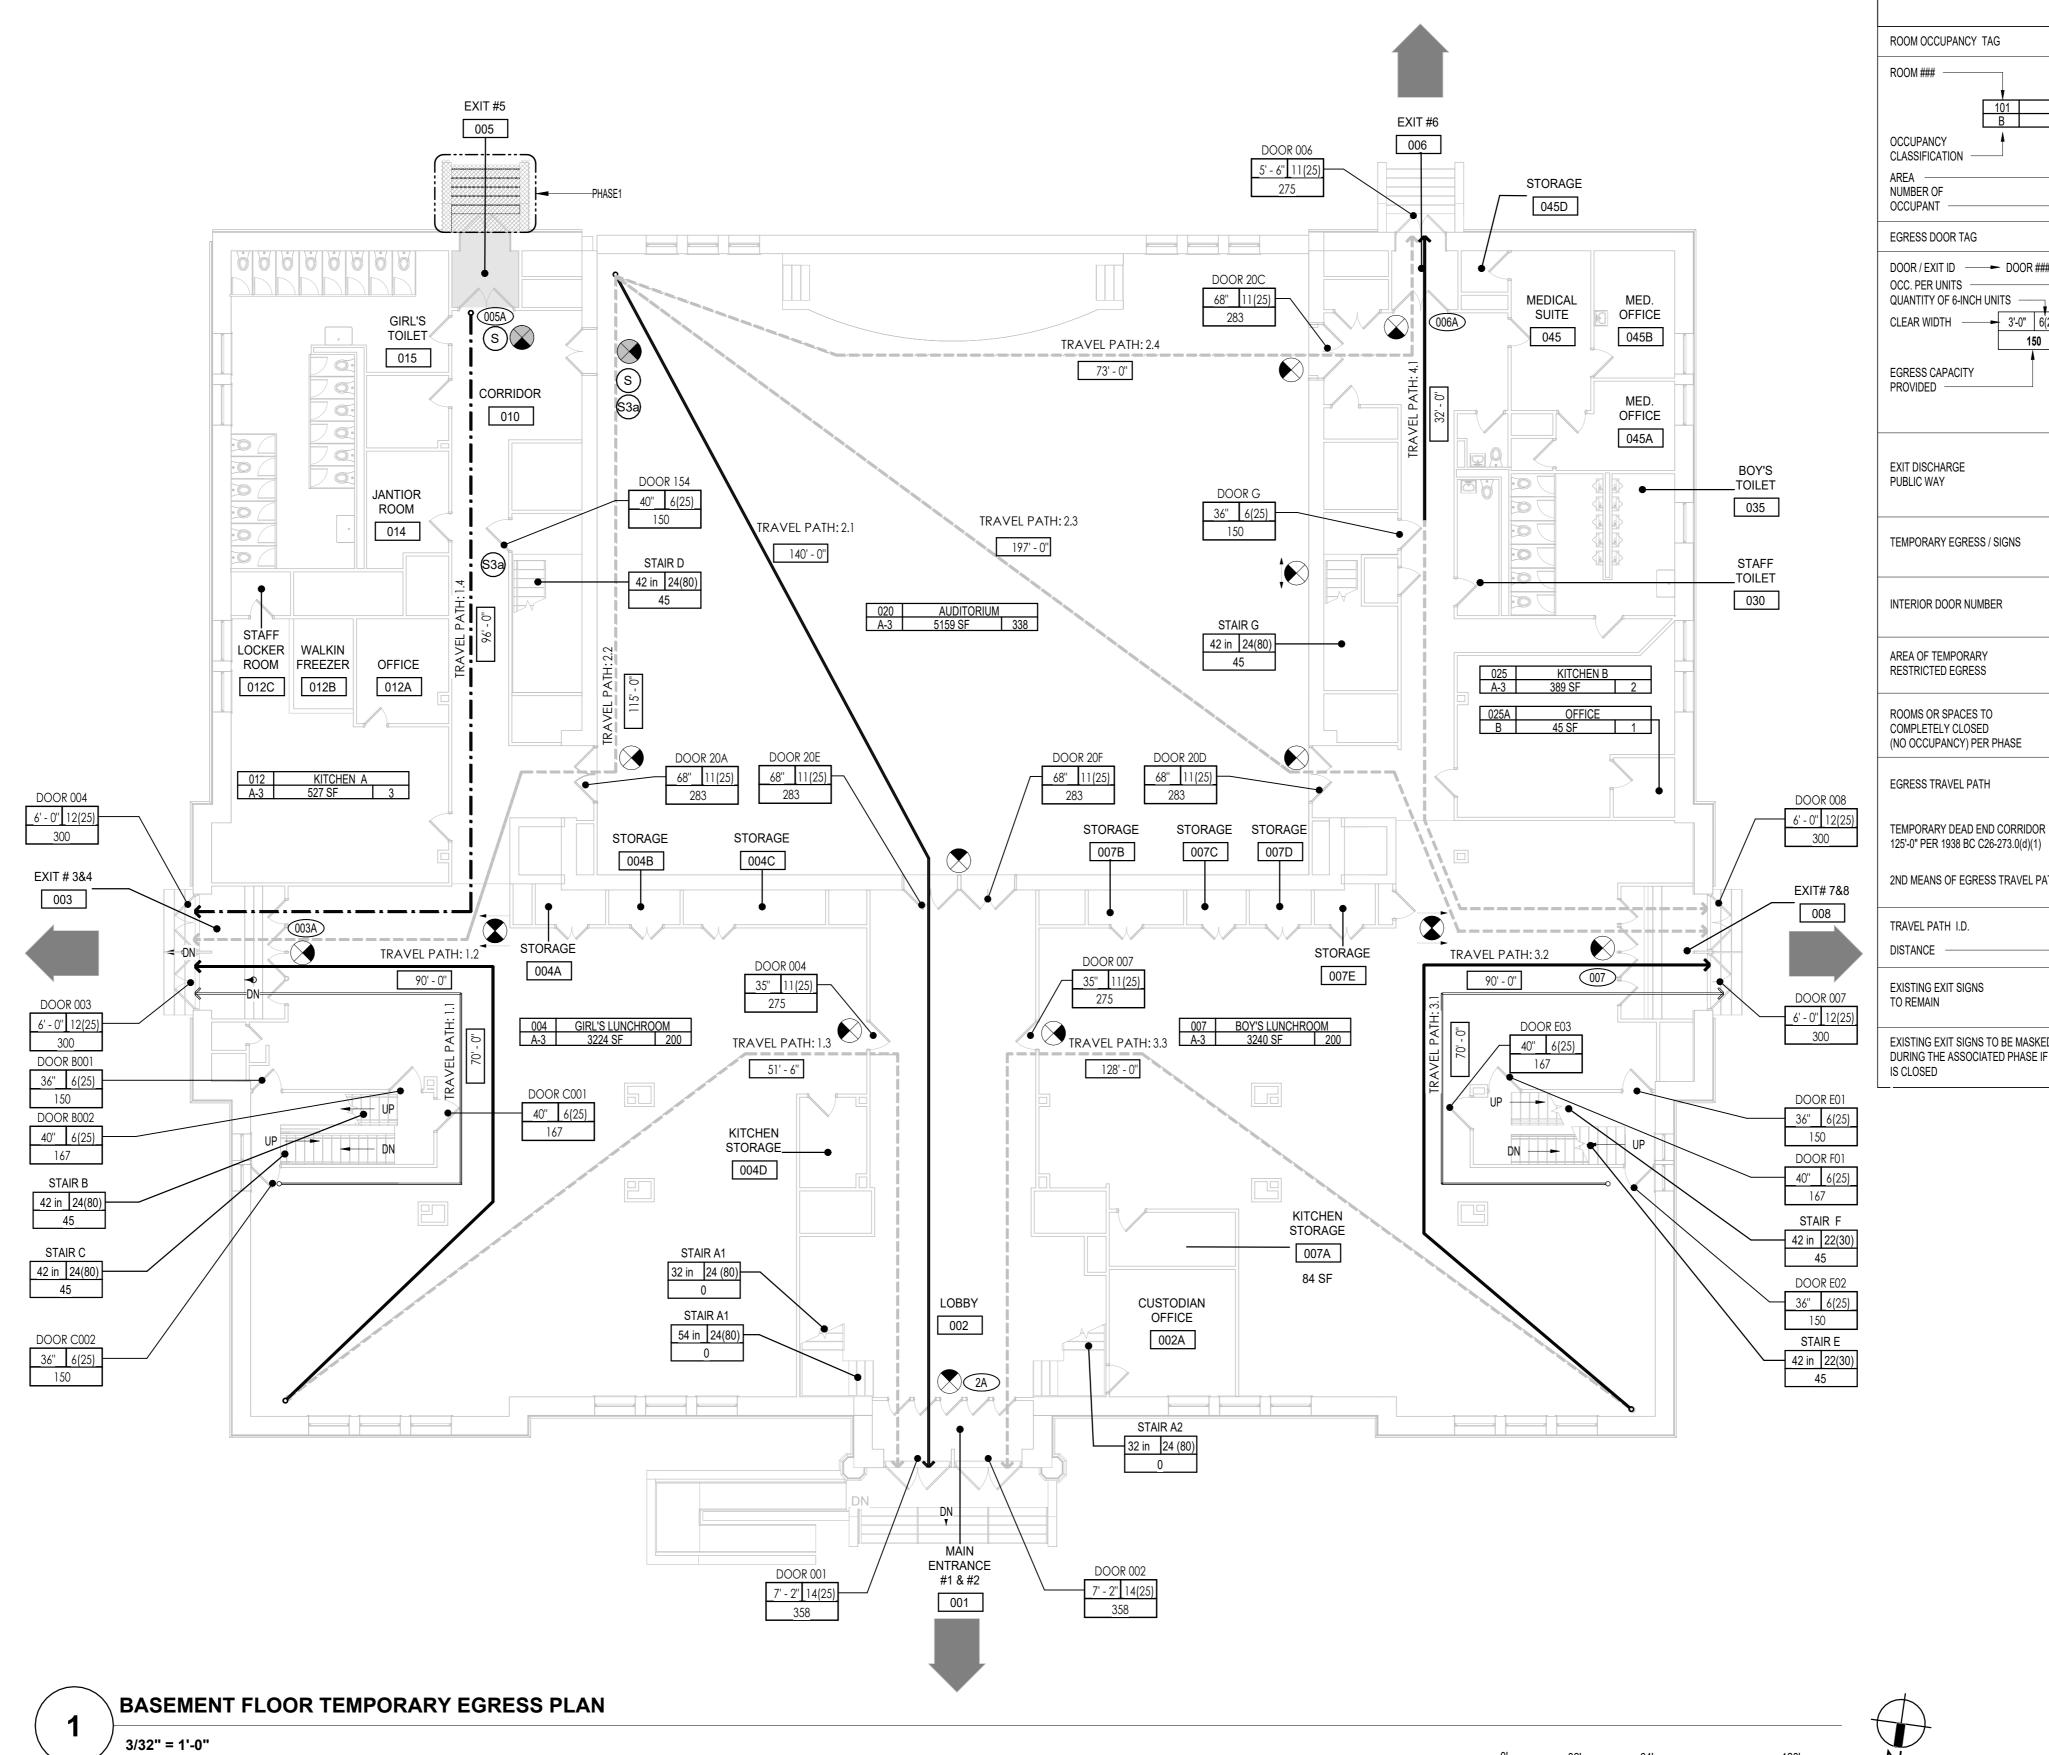

**LEGEND TEMPORARY EGRESS:** 

ROOM OCCUPANCY TAG OCCUPANCY CLASSIFICATION AREA -NUMBER OF OCCUPANT

EGRESS STAIR TAG EGRESS DOOR TAG DOOR / EXIT ID → DOOR ### STAIR ID ► STAIR ### OCC. PER UNITS OCC. PER UNITS QUANTITY OF 6-INCH UNITS — INCHES PER UNITS CLEAR WIDTH — 3'-0" | 6(25) CLEAR WIDTH - 3'-6" 22(30) 150

EGRESS CAPACITY EGRESS CAPACITY PROVIDED -PROVIDED -EXIT DISCHARGE PUBLIC WAY S TEMPORARY EGRESS / SIGNS (111A) INTERIOR DOOR NUMBER

AREA OF TEMPORARY RESTRICTED EGRESS

**●**·-·-→

ROOMS OR SPACES TO COMPLETELY CLOSED (NO OCCUPANCY) PER PHASE EGRESS TRAVEL PATH

125'-0" PER 1938 BC C26-273.0(d)(1) 2ND MEANS OF EGRESS TRAVEL PATH •----TRAVEL PATH I.D. TRAVEL PATH #.# DISTANCE EXISTING EXIT SIGNS 

EXISTING EXIT SIGNS TO BE MASKED DURING THE ASSOCIATED PHASE IF EXIT

President & CEO A. Nina Kubota

Peter McCree

**Board of Trustees** Chancellor David C. Banks, Chairman Lorraine Grillo



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Drawing may be printed at reduced scale

04/14/2023

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Construction Documents

Date Revisions Key Plan: PLAYGROUND I.S. 171K/ P.S. 7 K RIDGEWOOD AVENUE

ASHRAF ELIAS, P.E SCA Design Manager: DAVID SAMMEL, R.A Project Architect/Engineer: DAVID HUNSBERGER, R.A Discipline Lead: Designer: JUAN SANTOS / JUAN POLANCO JUAN SANTOS Drawn by: DAVID SAMMEL, R.A Checked by: Facility Code: Design No or LLW No.: K171 D021557 04/14/2023

Lot#

I.S. 171 - BROOKLYN **EXTERIOR MASONRY** 

528 Ridgewood Ave.

04134

Brooklyn New York 11208

PHASE 1 BASEMENT FLOOR TEMPORARY **EGRESS PLAN** 


DOB # B00836762 - I1

TE102.00

Sheets in GC Work Type Contract Set : 6 OF 43

Sheets in GC Work Type DOB Filing Set: 6 OF 38

NOTE:
PLANS ARE REPRODUCED FROM AN SCA RECORD SET. THE AREA OF WORK HAS BEEN VERIFIED TO MATCH THIS REFERENCE DRAWINGS

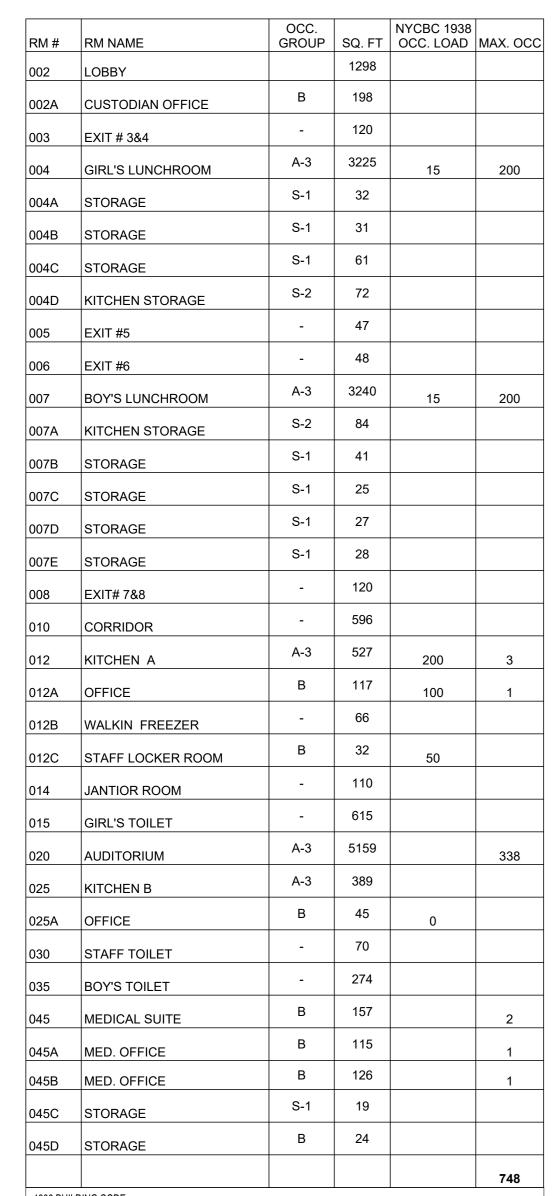

Sub-Article 1. General Egress Requirements (6.1.2.2.2). §C26-273.0 Required Exits.

2. Required Exits from the Ground Floor. - Unless otherwise provided, every ground floor area having direct exit by doorway to a street and having an aggregate area exceeding twenty-five hundred square feet or an occupancy of more than seventy-five persons shall have at least two means of egress. Every point in such area shall be within one hundred fifty feet of a means of egress, but one of such means of egress from stores may be by way of a basement passageway connecting with the main hallway of the structure. In structures used exclusively for school purposes and in which regular supervised fire drills are held, the maximum distance of any point in a ground floor area of egress shall be one hundred eighty feet.


EXIT #	DOOR#	DOOR WIDTH	DOOR CAPACITY
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EXIT # 5	6	66	275
EXIT # 7 & 8	7	72	300
EXIT # 7 & 8	8	72	300
			2192

1938 BUILDING CODE

Sub-Article 4. Required Stairways (6.4.4.1). §C26-292.0 Interior Required Stairs.

2. The aggregate width of required stairs serving as exits from any story shall be sufficient to accommodate at one time the total number of persons occupying or permitted to occupy the story served by such stairs in accordance with the following

(b) Hospitals, asylums, jails, libraries, class rooms and lecture rooms in schools, fire houses, police stations, offices, showrooms, stores, markets, warehouses or storage spaces, garages, laboratories, power stations, billiard rooms, swimming pools, studios, libraries, dwellings other than private dwellings, or multiple dwellings, or any other use not specified in item (a) hereof immediately preceding - 30 persons per unit of stair width. The unit of stair width for such uses or occupancies shall be 22 inches, except that an allowance\* of (15) persons may be made for 12 inches of stair width added to two or more 22-inch units of stair width.

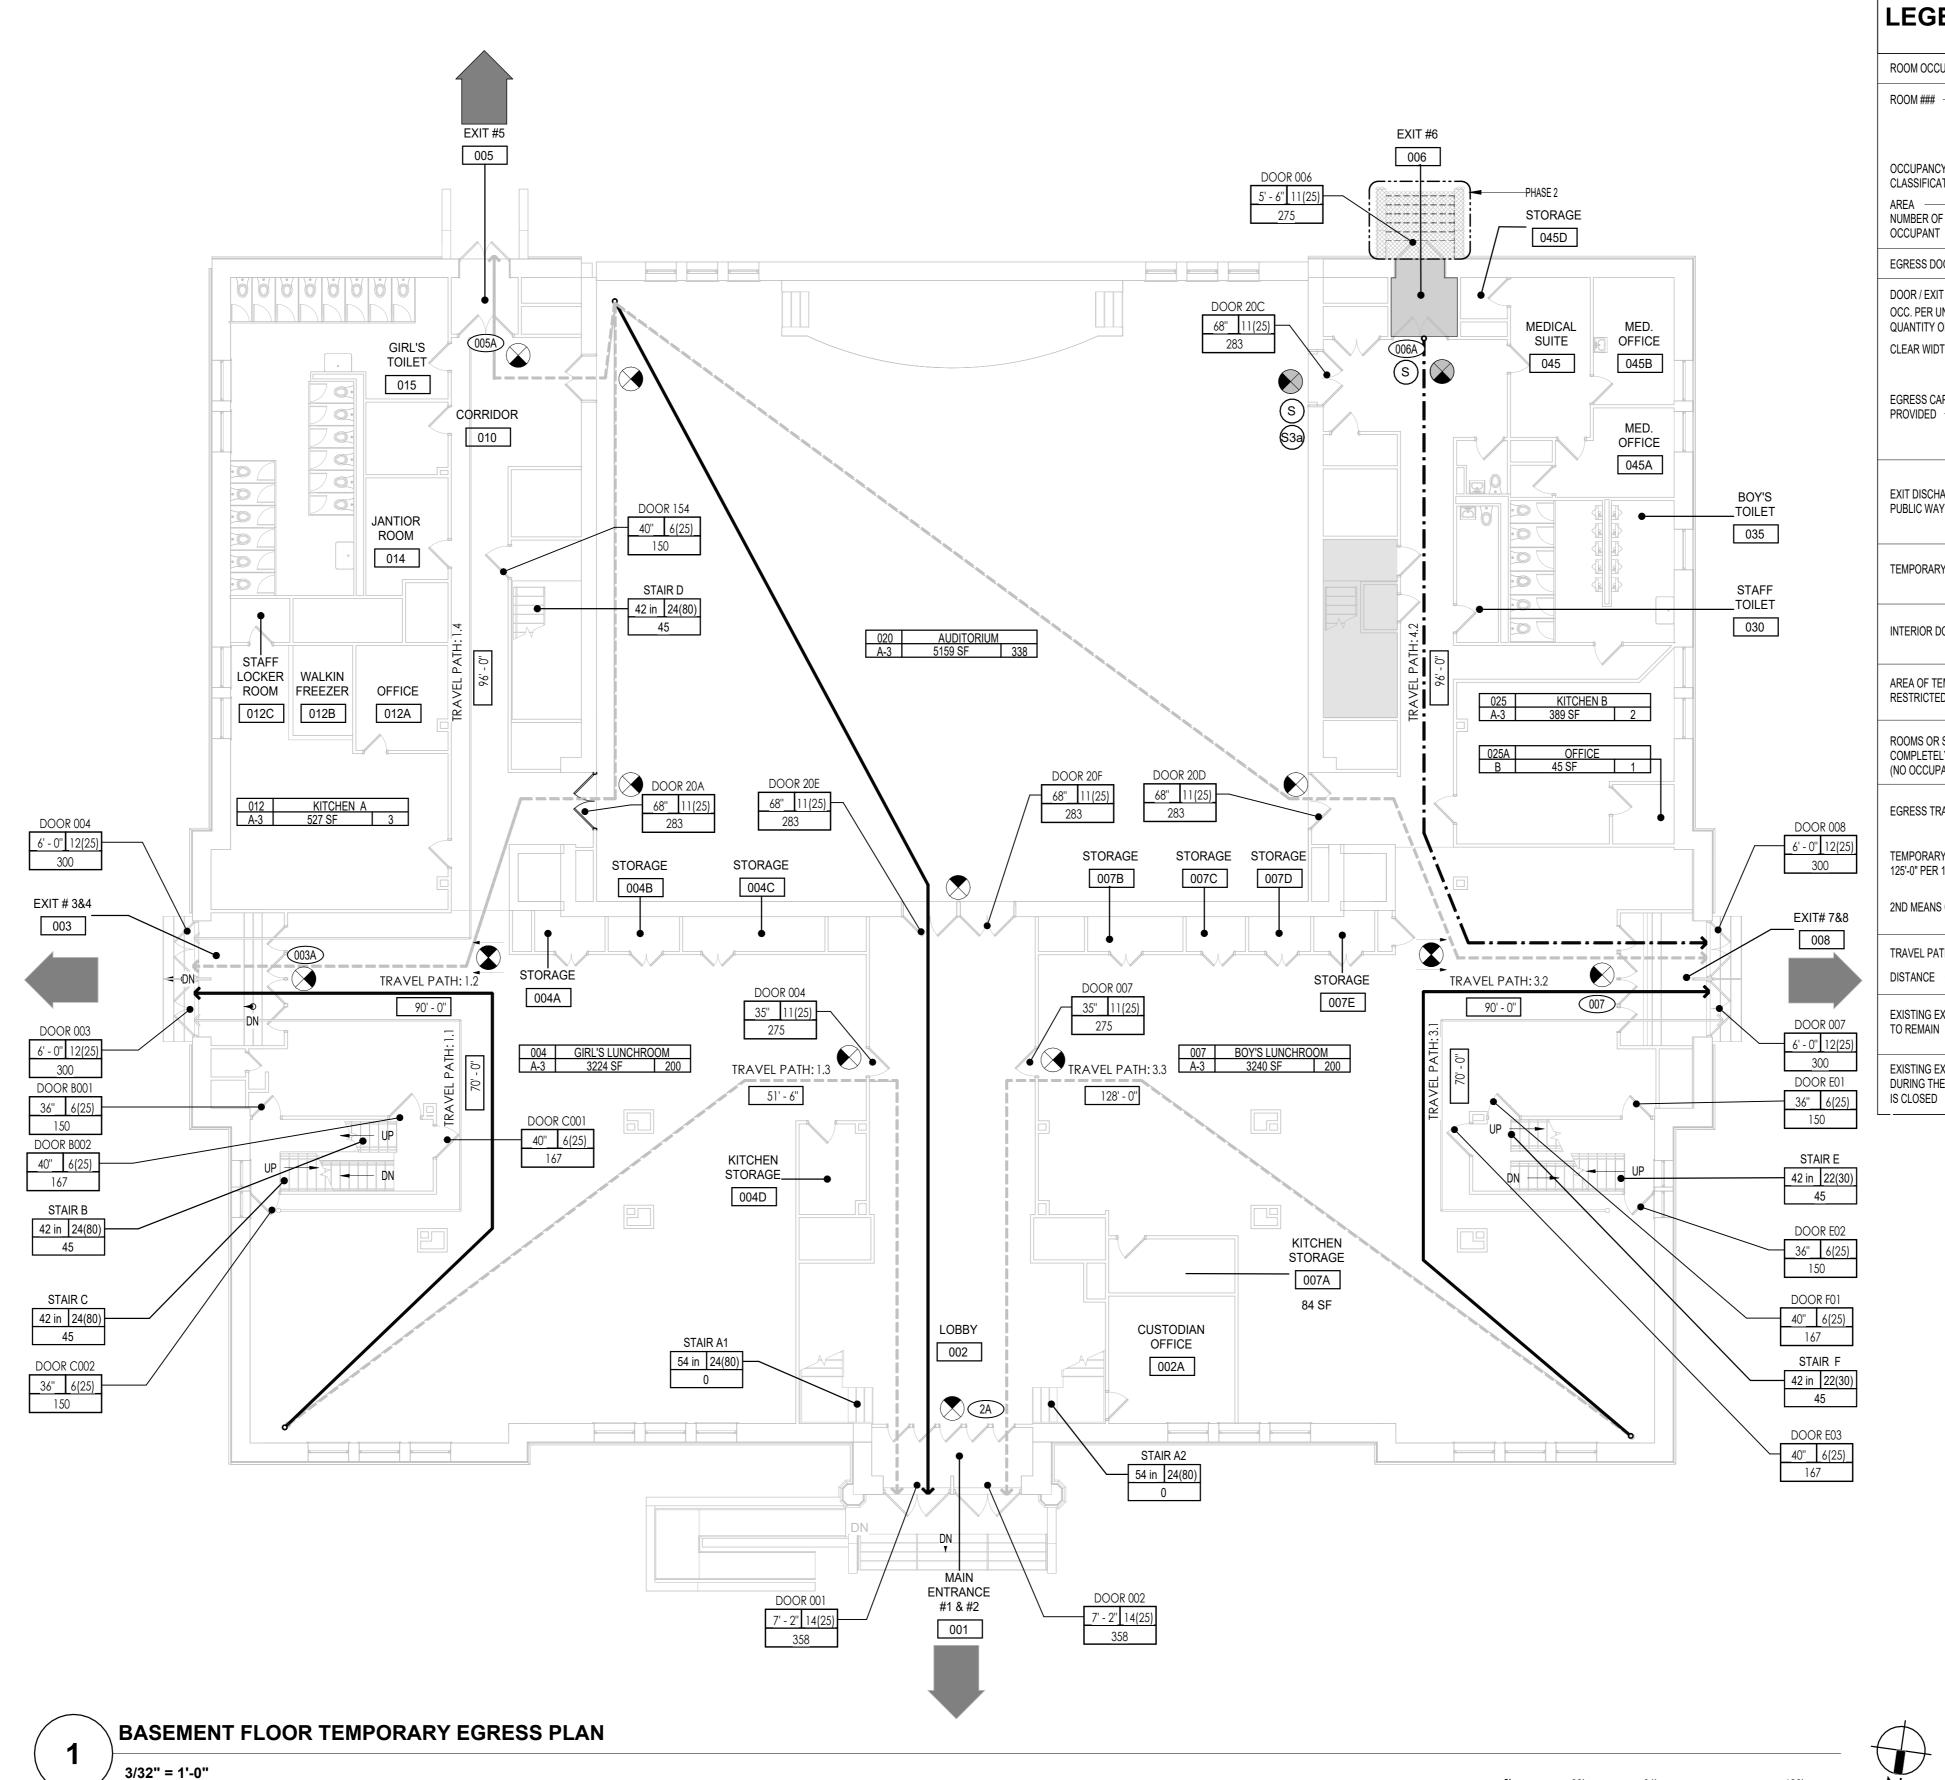

**LEGEND TEMPORARY EGRESS:** 

ROOM OCCUPANCY TAG OCCUPANCY CLASSIFICATION

NUMBER OF OCCUPANT EGRESS STAIR TAG EGRESS DOOR TAG DOOR / EXIT ID → DOOR ### OCC. PER UNITS OCC. PER UNITS QUANTITY OF 6-INCH UNITS — INCHES PER UNITS

STAIR ID ► STAIR ### CLEAR WIDTH 3'-0" 6(25) CLEAR WIDTH - 3'-6" 22(30) 150 EGRESS CAPACITY EGRESS CAPACITY PROVIDED -PROVIDED -

EXIT DISCHARGE PUBLIC WAY S TEMPORARY EGRESS / SIGNS (111A) INTERIOR DOOR NUMBER

AREA OF TEMPORARY RESTRICTED EGRESS

ROOMS OR SPACES TO COMPLETELY CLOSED (NO OCCUPANCY) PER PHASE

EGRESS TRAVEL PATH TEMPORARY DEAD END CORRIDOR •-·-·-125'-0" PER 1938 BC C26-273.0(d)(1) 2ND MEANS OF EGRESS TRAVEL PATH •----TRAVEL PATH I.D. TRAVEL PATH #.#

DISTANCE

EXISTING EXIT SIGNS TO REMAIN EXISTING EXIT SIGNS TO BE MASKED DURING THE ASSOCIATED PHASE IF EXIT

President & CEO A. Nina Kubota

> **Board of Trustees** Chancellor David C. Banks, Chairman Lorraine Grillo Peter McCree



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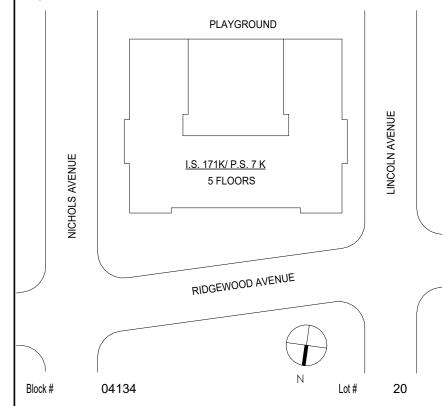
KATONAH, NEW YORK 10536 TEL (914) 276-0777 FAX (914) 276-0779 CPLteam.COM ARCHITECTURE ENGINEERING PLANNING

TEg Taylor Environmental Group **Asbestos Consultants** Taylor Environmental Group, Inc. 130A Jericho Turnpike Floral Park, NY 11001 Phone: (516) 358-2955

Drawing may be printed at reduced scale

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04/14/2023 Construction Documents Date Revisions Key Plan: PLAYGROUND



ASHRAF ELIAS, P.E SCA Design Manager: DAVID SAMMEL, R.A Project Architect/Engineer: DAVID HUNSBERGER, R.A Discipline Lead: Designer: JUAN SANTOS / JUAN POLANCO JUAN SANTOS Drawn by: DAVID SAMMEL, R.A Checked by: Facility Code: Design No or LLW No.: K171 D021557 04/14/2023

> I.S. 171 - BROOKLYN **EXTERIOR MASONRY**

528 Ridgewood Ave. Brooklyn New York 11208

PHASE 2 BASEMENT FLOOR TEMPORARY **EGRESS PLAN** 


DOB # B00836762 - I1

TE103.00

Sheets in GC Work Type Contract Set : 7 OF 43

Sheets in GC Work Type DOB Filing Set: 7 OF 38

NOTE:
PLANS ARE REPRODUCED FROM AN SCA RECORD SET. THE AREA OF WORK HAS BEEN VERIFIED TO MATCH THIS REFERENCE DRAWINGS

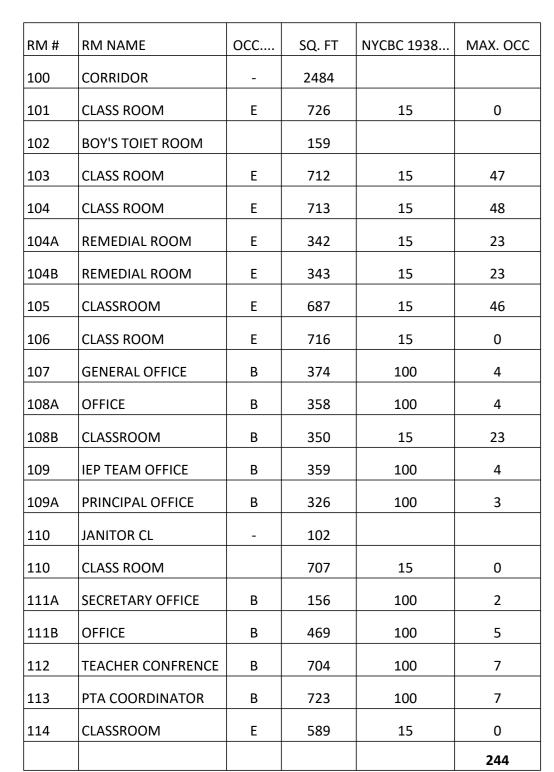

Sub-Article 1. General Egress Requirements

(6.1.2.2.2). §C26-273.0 Required Exits. 2. Required Exits from the Ground Floor. - Unless otherwise provided, every ground floor area having direct exit by doorway to a street and having an aggregate area exceeding twenty-five hundred square feet or an occupancy of more than seventy-five persons shall have at least two means of egress. Every point in such area shall be within one hundred fifty feet of a means of egress, but one of such means of egress from stores may be by way of a basement passageway connecting with the main hallway of the structure. In structures used exclusively for school purposes and in which regular supervised fire drills are held, the maximum distance of any point in a ground floor area of egress shall be one hundred eighty feet.

the maximum dist	ance of any point ir	n a ground floor a	area of egress	shall be one hundred eight	y feet.
STAIR#	DOOR WIDTH	DOOR CAPACITY	STAIR WIDTH	STAIR CAPACITY PER C26-292.0 (2)(a)	NET
STAIR A1			54	0	
STAIR A2			54	0	
STAIR B	36	150	42	45	
STAIR C	36	150	42	45	
STAIR D	36	150	42	45	
STAIR E	36	150	42	45	
STAIR F	36	150	42	45	
STAIR G	26	150	42	45	CLOSED PHASE 2
		750		270	


1938 BUILDING CODE Sub-Article 4. Required Stairways

(6.4.4.1). §C26-292.0 Interior Required Stairs.

2. The aggregate width of required stairs serving as exits from any story shall be sufficient to accommodate at one time the total number of persons occupying or permitted to occupy the story served by such stairs in accordance with the following

TOTAL (AVAILABLE EGRESS TO OCCUPANCY): 270 OCC. > 244 OCC. = OK

(b) Hospitals, asylums, jails, libraries, class rooms and lecture rooms in schools, fire houses, police stations, offices, showrooms, stores, markets, warehouses or storage spaces, garages, laboratories, power stations, billiard rooms, swimming pools, studios, libraries, dwellings other than private dwellings, or multiple dwellings, or any other use not specified in item (a) hereof immediately preceding - 30 persons per unit of stair width. The unit of stair width for such uses or occupancies shall be 22 inches, except that an allowance\* of (15) persons may be made for 12 inches of stair width added to two or more 22-inch units of stair width.

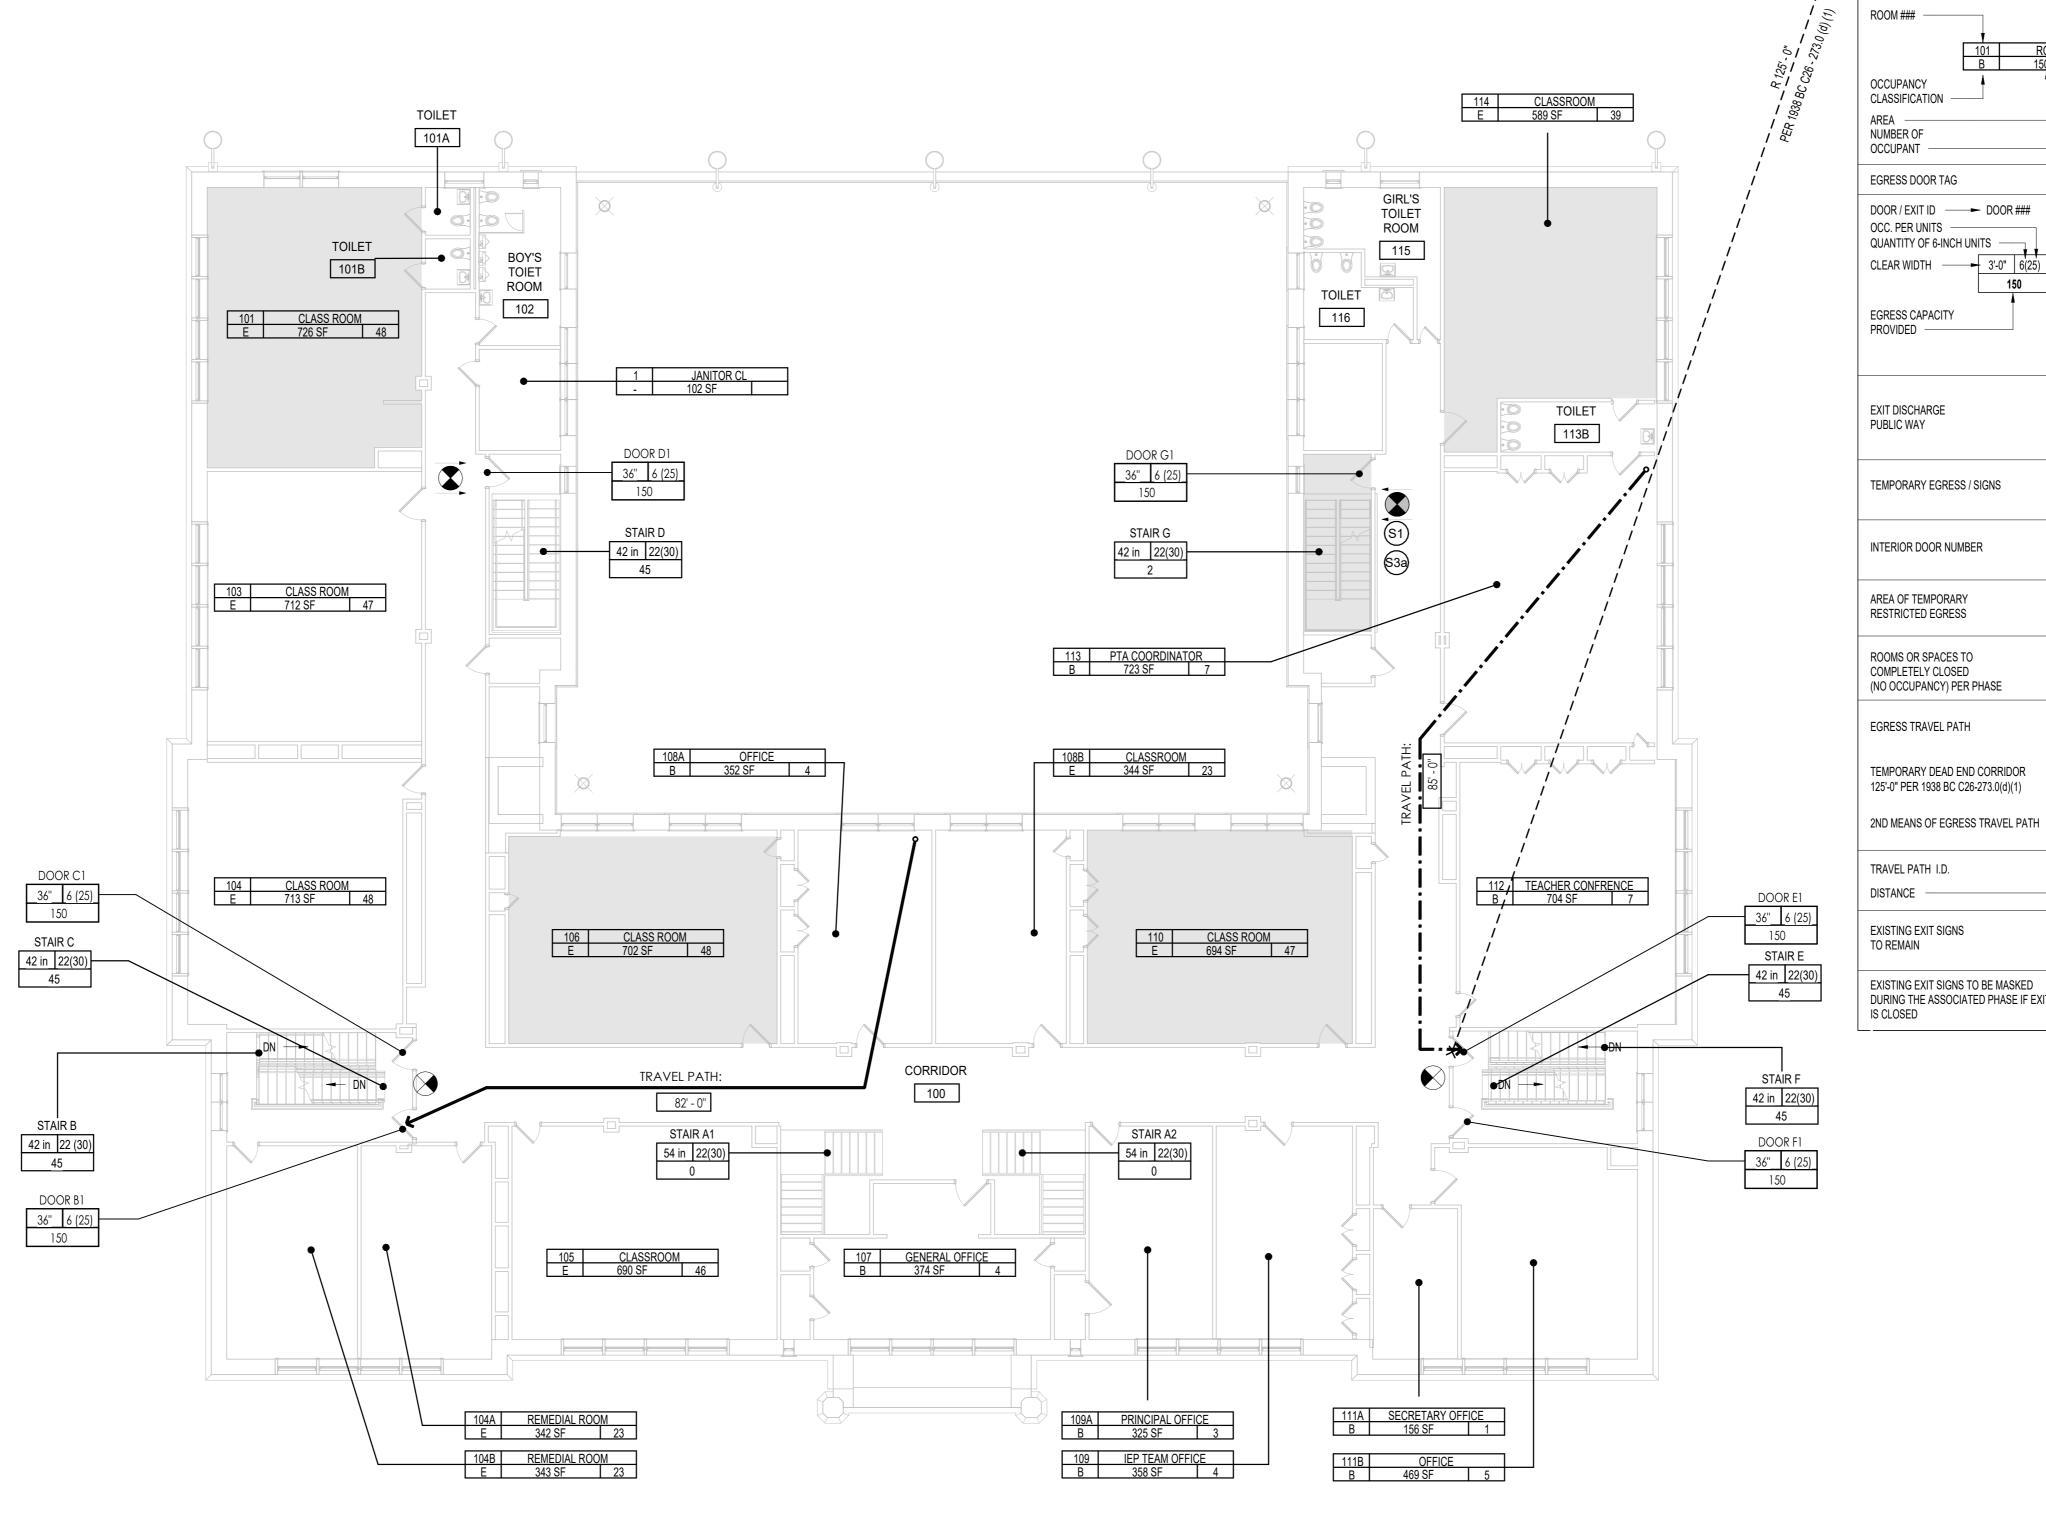

FIRST FLOOR TEMPORARY EGRESS PLAN 3/32" = 1'-0"

**LEGEND TEMPORARY EGRESS:** 

ROOM OCCUPANCY TAG ROOM NAME OCCUPANCY CLASSIFICATION AREA -NUMBER OF OCCUPANT

EGRESS DOOR TAG EGRESS STAIR TAG DOOR / EXIT ID → DOOR ### OCC. PER UNITS -OCC. PER UNITS QUANTITY OF 6-INCH UNITS — INCHES PER UNITS 3'-0" 6(25) CLEAR WIDTH -CLEAR WIDTH - 3'-6" 22(30) 150 EGRESS CAPACITY EGRESS CAPACITY PROVIDED -PROVIDED -

EXIT DISCHARGE PUBLIC WAY (S) TEMPORARY EGRESS / SIGNS (111A) INTERIOR DOOR NUMBER

AREA OF TEMPORARY RESTRICTED EGRESS ROOMS OR SPACES TO

•-·-·-

•----

EGRESS TRAVEL PATH TEMPORARY DEAD END CORRIDOR 125'-0" PER 1938 BC C26-273.0(d)(1)

TRAVEL PATH I.D. TRAVEL PATH #.# DISTANCE DISTANCE EXISTING EXIT SIGNS TO REMAIN

EXISTING EXIT SIGNS TO BE MASKED DURING THE ASSOCIATED PHASE IF EXIT IS CLOSED

President & CEO A. Nina Kubota

Peter McCree

Board of Trustees Chancellor David C. Banks, Chairman Lorraine Grillo



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2875 ROUTE 35, SUITE 7S-1

KATONAH, NEW YORK 10536


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Eg Taylor Environmental Group **Asbestos Consultants** Taylor Environmental Group, Inc. 130A Jericho Turnpike Floral Park, NY 11001 Phone: (516) 358-2955

Drawing may be printed at reduced scale

IT IS A VIOLATION OF THE STATE EDUCATION LAW SECTION 7209 (2) FOR ANY PERSON TO ALTER AN ITEM IN ANY WAY UNLESS SUCH PERSON IS ACTING UNDER THE DIRECTION OF A LICENSED PROFESSIONAL ENGINEER, AND THE ENGINEER STAMPS SUCH CHANGES

04/14/2023 Construction Documents Date Revisions

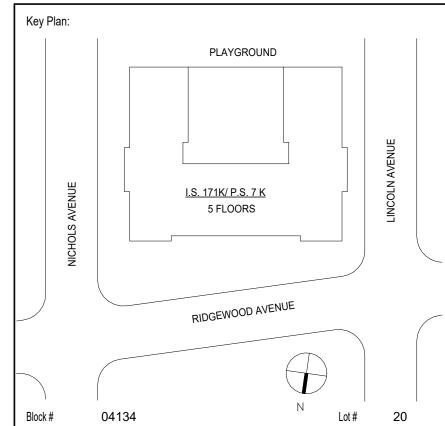

ASHRAF ELIAS, P.E SCA Design Manager: DAVID SAMMEL, R.A Project Architect/Engineer: DAVID HUNSBERGER, R.A Discipline Lead: JUAN SANTOS / JUAN POLANCO Designer: JUAN SANTOS Drawn by: DAVID SAMMEL, R.A Checked by: Facility Code: Design No or LLW No.: K171 D021557 04/14/2023

> I.S. 171 - BROOKLYN **EXTERIOR MASONRY**

528 Ridgewood Ave. Brooklyn New York 11208

PHASE 2 FIRST FLOOR TEMPORARY EGRESS PLAN


DOB # B00836762 - I1

TE104.00

Sheets in GC Work Type Contract Set : 8 OF 43

Sheets in GC Work Type DOB Filing Set: 8 OF 38

NOTE:
PLANS ARE REPRODUCED FROM AN SCA RECORD SET. THE AREA OF WORK HAS BEEN VERIFIED TO MATCH THIS REFERENCE DRAWINGS

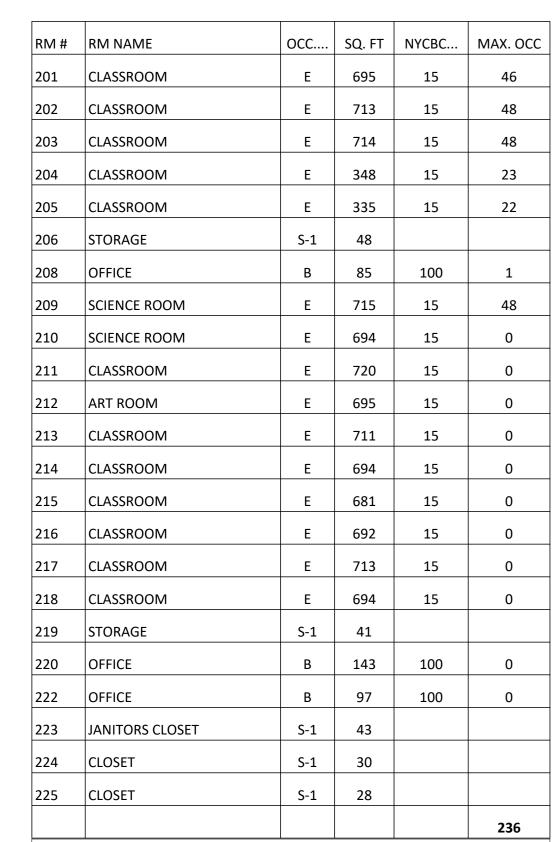

Sub-Article 1. General Egress Requirements (6.1.2.2.2). §C26-273.0 Required Exits.

2. Required Exits from the Ground Floor. - Unless otherwise provided, every ground floor area having direct exit by doorway to a street and having an aggregate area exceeding twenty-five hundred square feet or an occupancy of more than seventy-five persons shall have at least two means of egress. Every point in such area shall be within one hundred fifty feet of a means of egress, but one of such means of egress from stores may be by way of a basement passageway connecting with the main hallway of the structure. In structures used exclusively for school purposes and in which regular supervised fire drills are held, the maximum distance of any point in a ground floor area of egress shall be one hundred eighty feet.


STAIR#	DOOR WIDTH	DOOR CAPACITY	STAIR WIDTH	STAIR CAPACITY PER C26-292.0 (2)(a)	NET
STAIR B	36	150	42	45	
STAIR C	36	150	42	45	
STAIR D	36	150	42	45	
STAIR E	36	150	42	45	
STAIR F	36	150	42	45	
STAIR G	36	150	42	45	CLOSED DURING PHASE 2
		750		270	
TO	TAL (AVA	ILABLE EGF	RESS TO C	OCCUPANCY): 270	OCC. > 236 OCC. = OK

1938 BUILDING CODE Sub-Article 4. Required Stairways

(6.4.4.1). §C26-292.0 Interior Required Stairs.

2. The aggregate width of required stairs serving as exits from any story shall be sufficient to accommodate at one time the total number of persons occupying or permitted to occupy the story served by such stairs in accordance with the following limitations:

(b) Hospitals, asylums, jails, libraries, class rooms and lecture rooms in schools, fire houses, police stations, offices, showrooms, stores, markets, warehouses or storage spaces, garages, laboratories, power stations, billiard rooms, swimming pools, studios, libraries, dwellings other than private dwellings, or multiple dwellings, or any other use not specified in item (a) hereof immediately preceding - 30 persons per unit of stair width. The unit of stair width for such uses or occupancies shall be 22 inches, except that an allowance\* of (15) persons may be made for 12 inches of stair width added to two or more 22-inch units of stair width.

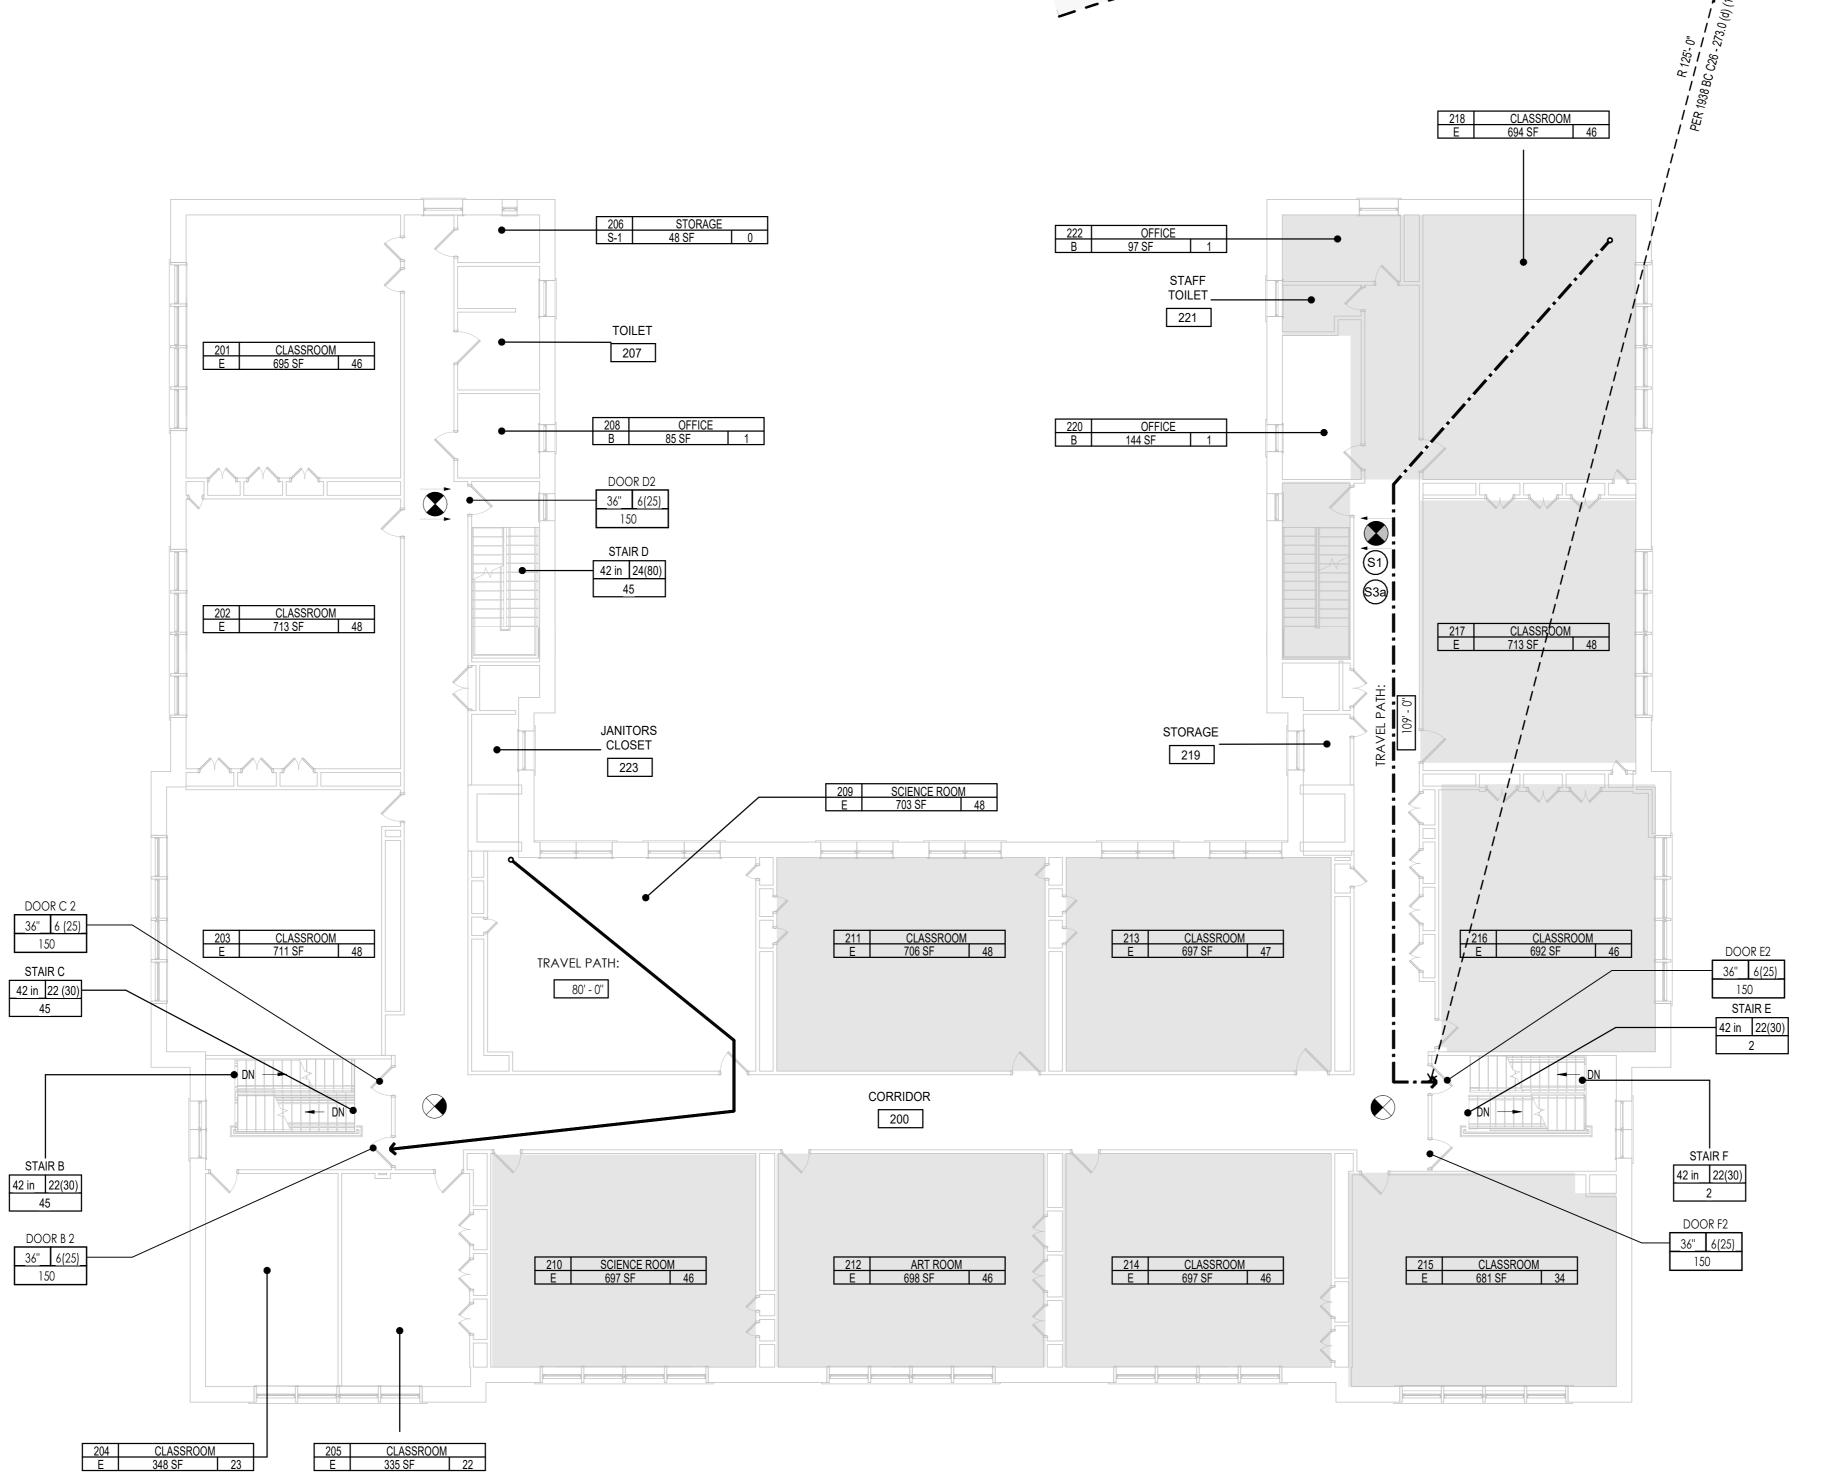

CLASSIFICATION -AREA -NUMBER OF OCCUPANT EGRESS STAIR TAG EGRESS DOOR TAG DOOR / EXIT ID → DOOR ### STAIR ID ► STAIR ### OCC. PER UNITS -OCC. PER UNITS QUANTITY OF 6-INCH UNITS -INCHES PER UNITS CLEAR WIDTH \_\_\_\_\_\_\_\_3'-6" | 22(30) CLEAR WIDTH 3'-0" 6(25) 150 EGRESS CAPACITY EGRESS CAPACITY PROVIDED -PROVIDED -EXIT DISCHARGE PUBLIC WAY S TEMPORARY EGRESS / SIGNS (111A) INTERIOR DOOR NUMBER AREA OF TEMPORARY RESTRICTED EGRESS ROOMS OR SPACES TO COMPLETELY CLOSED (NO OCCUPANCY) PER PHASE EGRESS TRAVEL PATH TEMPORARY DEAD END CORRIDOR •----125'-0" PER 1938 BC C26-273.0(d)(1) 2ND MEANS OF EGRESS TRAVEL PATH •----> TRAVEL PATH I.D. TRAVEL PATH #.# DISTANCE -DISTANCE EXISTING EXIT SIGNS TO REMAIN

EXISTING EXIT SIGNS TO BE MASKED DURING THE ASSOCIATED PHASE IF EXIT

IS CLOSED

**LEGEND TEMPORARY EGRESS:** 

ROOM OCCUPANCY TAG

ROOM ### -

OCCUPANCY

President & CEO A. Nina Kubota

Peter McCree

Board of Trustees
Chancellor David C. Banks, Chairman
Lorraine Grillo



Architecture & Engineering

María A. Gómez, P.E. LEED AP BD+C, Acting Vice President Senior Director In-House Design Studio Design Consultant Management Studio Aileen del Prado, P.E. LEED AP BD+C, Senior Director

Consultants:

2875 ROUTE 35, SUITE 7S-1
KATONAH, NEW YORK 10536
TEL (914) 276-0777
FAX (914) 276-0779
CPLteam.COM
ARCHITECTURE ENGINEERING PLANNING

TES Taylor Environmental Group
Asbestos Consultants
Taylor Environmental Group, Inc.
130A Jericho Turnpike
Floral Park, NY 11001
Phone: (516) 358-2955


NOTE: Drawing may be printed at reduced scale

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1 04/14/2023 Construction Documents
No. Date Revisions

Key Plan:

PLAYGROUND

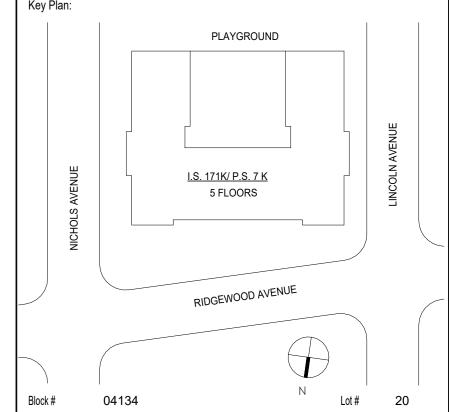

SCA Design Manager:	AS	HRAF ELIAS, P.E	
Project Architect/Engineer:	DA\	/ID SAMMEL, R.A	
Discipline Lead:	DAVID HI	JNSBERGER, R.A	
Bloopine Lead.	D/ (VID TIC	NOBEROER, IX.7	
Designer:	JUAN SANTOS / JUAN POLANCO		
JUAN SANTOS / JUAN		JUAN PULANCU	
Drawn by:		JUAN SANTOS	
Diawii by.		30AN 3AN 103	
Checked by:	DVI	/ID SAMMEL, R.A	
Checked by.	DAV	AD SAIVIIVIEL, N.A	
Design No and LWNs .	Facility Cada	Data	
Design No or LLW No.:	Facility Code:	Date:	
D021557	K171	04/14/2023	
D02 1001		0 1/ 1 1/2020	

I.S. 171 - BROOKLYN EXTERIOR MASONRY

Address: 528 Ridgewood Ave.

528 Ridgewood Ave. Brooklyn New York 11208

PHASE 2 SECOND FLOOR TEMPORARY
EGRESS PLAN

DOB # B00836762 - I1

TE105.00

Sheets in GC Work Type Contract Set : 9 OF 43


Sheets in GC Work Type DOB Filing Set:

9 OF 38

SECOND FLOOR TEMPORARY EGRESS PLAN

3/32" = 1'-0"

0' 32' 64'

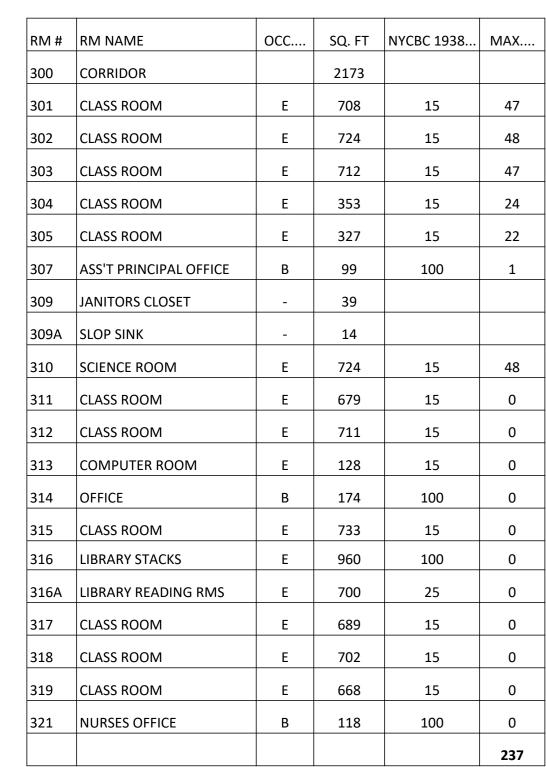

Sub-Article 1. General Egress Requirements

(6.1.2.2.2). §C26-273.0 Řequired Exits. 2. Required Exits from the Ground Floor. - Unless otherwise provided, every ground floor area having direct exit by doorway to a street and having an aggregate area exceeding twenty-five hundred square feet or an occupancy of more than seventy-five persons shall have at least two means of egress. Every point in such area shall be within one hundred fifty feet of a means of egress, but one of such means of egress from stores may be by way of a basement passageway connecting with the main hallway of the structure. In structures used exclusively for school purposes and in which regular supervised fire drills are held,


STAIR E 36 150 42 45  STAIR F 36 150 42 45	the maximum distance of any point in a ground floor area of egress shall be one hundred eighty feet.					
STAIR C       36       150       42       45         STAIR D       36       150       42       45         STAIR E       36       150       42       45         STAIR F       36       150       42       45         STAIR G       36       150       42       45       CLOSED DURING PHASE 2         750       270	STAIR#		l		PER C26-292.0	NET
STAIR D 36 150 42 45  STAIR E 36 150 42 45  STAIR F 36 150 42 45  STAIR G 36 150 42 45  CLOSED DURING PHASE 2	STAIR B	36	150	42	45	
STAIR E 36 150 42 45  STAIR F 36 150 42 45  STAIR G 36 150 42 45 CLOSED DURING PHASE 2	STAIR C	36	150	42	45	
STAIR E 36 150 42 45  STAIR F 36 150 42 45  STAIR G 36 150 42 45 CLOSED DURING PHASE 2						
STAIR F 36 150 42 45  STAIR G 36 150 42 45 CLOSED DURING PHASE 2  750 270	STAIR D	36	150	42	45	
STAIR F 36 150 42 45  STAIR G 36 150 42 45 CLOSED DURING PHASE 2  750 270						
STAIR G 36 150 42 45 CLOSED DURING PHASE 2	STAIR E	36	150	42	45	
750 270	STAIR F	36	150	42	45	
750 270						
	STAIR G	36	150	42	45	CLOSED DURING PHASE 2
TOTAL (AVAILABLE EGRESS TO OCCUPANCY): 270 OCC. > 236 OCC. = OK			750		270	
	TO	TAL (AVA	ILABLE EGF	RESS TO C	CCUPANCY): 270	OCC. > 236 OCC. = OK


1938 BUILDING CODE


Sub-Article 4. Required Stairways (6.4.4.1). §C26-292.0 Interior Required Stairs.

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(b) Hospitals, asylums, jails, libraries, class rooms and lecture rooms in schools, fire houses, police stations, offices, showrooms, stores, markets, warehouses or storage spaces, garages, laboratories, power stations, billiard rooms, swimming pools, studios, libraries, dwellings other than private dwellings, or multiple dwellings, or any other use not specified in item (a) hereof immediately preceding - 30 persons per unit of stair width. The unit of stair width for such uses or occupancies shall be 22 inches, except that an allowance\* of (15) persons may be made for 12 inches of stair width added to two or more 22-inch units of stair width.



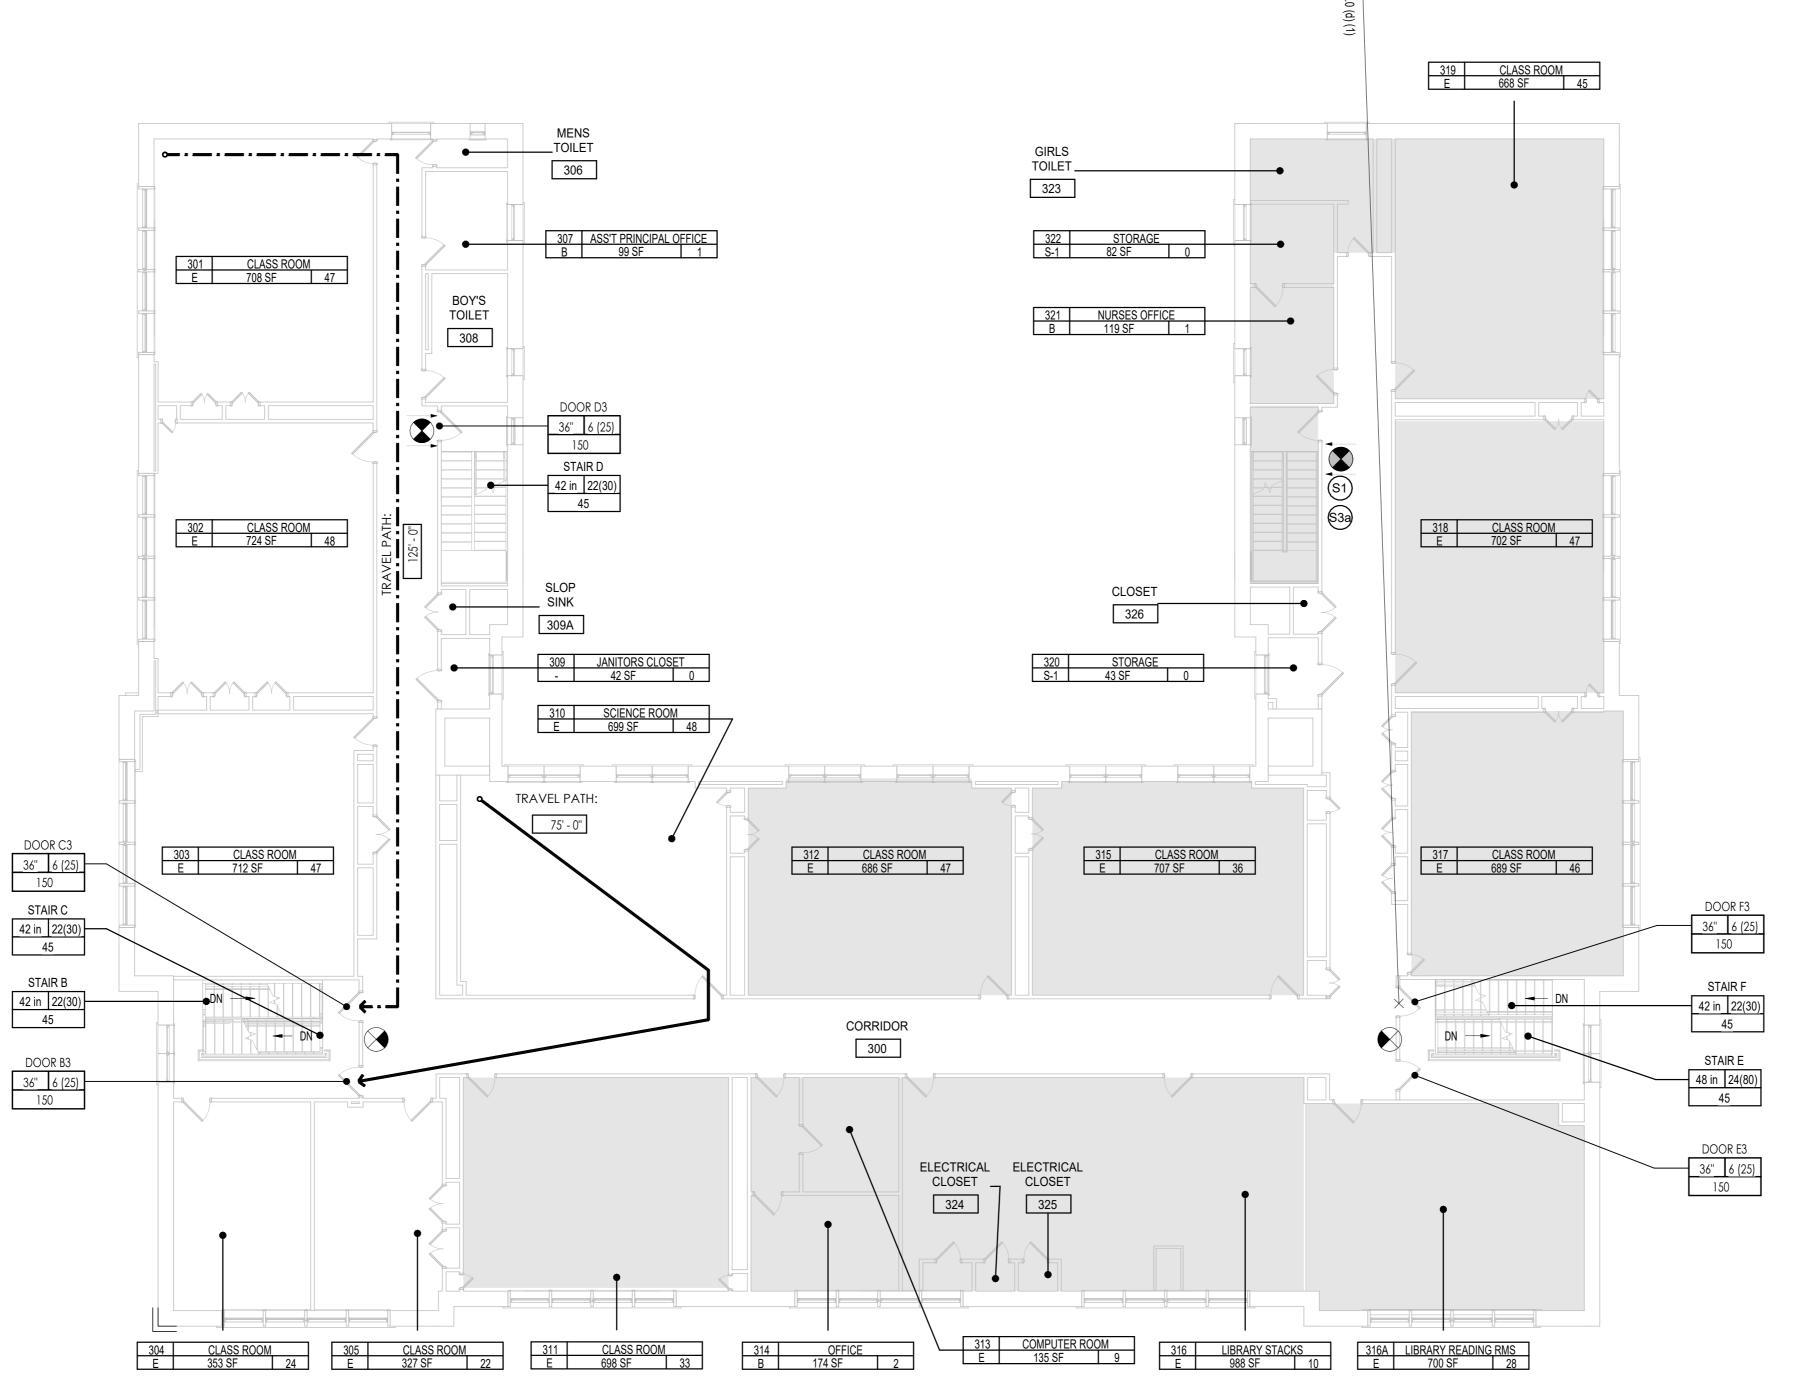

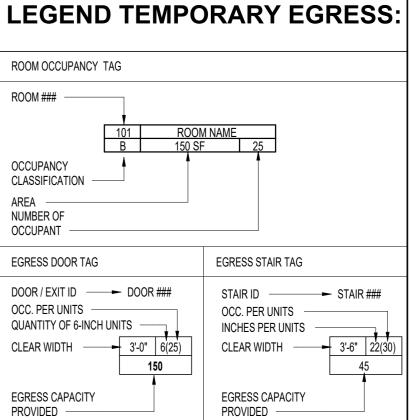

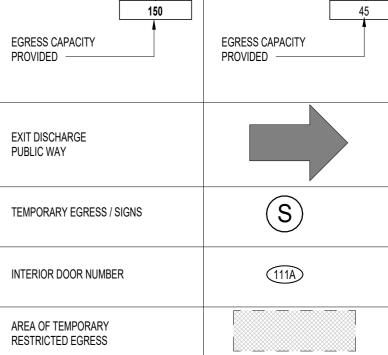	,
TEMPORARY DEAD END CORRIDOR 125'-0" PER 1938 BC C26-273.0(d)(1)	•-·-·-
2ND MEANS OF EGRESS TRAVEL PATH	•>

EXISTING EXIT SIGNS TO BE MASKED

IS CLOSED

EGRESS TRAVEL PATH

TRAVEL PATH I.D. TRAVEL PATH #.# DISTANCE DISTANCE EXISTING EXIT SIGNS TO REMAIN

DURING THE ASSOCIATED PHASE IF EXIT

President & CEO A. Nina Kubota

Peter McCree

**Board of Trustees** Chancellor David C. Banks, Chairman Lorraine Grillo



Architecture & Engineering

María A. Gómez, P.E. LEED AP BD+C, Acting Vice President Senior Director In-House Design Studio Design Consultant Management Studio Aileen del Prado, P.E. LEED AP BD+C, Senior Director


2875 ROUTE 35, SUITE 7S-1 KATONAH, NEW YORK 10536 TEL (914) 276-0777 FAX (914) 276-0779 CPLteam.COM ARCHITECTURE ENGINEERING PLANNING

TEg Taylor Environmental Group **Asbestos Consultants** Taylor Environmental Group, Inc. 130A Jericho Turnpike Floral Park, NY 11001 Phone: (516) 358-2955

Drawing may be printed at reduced scale

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04/14/2023 Construction Documents Date Revisions

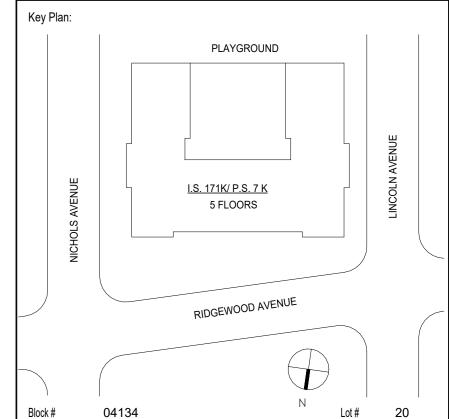

SCA Design Manager:	AS	SHRAF ELIAS, P.E
Project Architect/Engineer:	DA	VID SAMMEL, R.A
Discipline Lead:	DAVID HU	JNSBERGER, R.A
Designer:	JUAN SANTOS /	JUAN POLANCO
Drawn by:		JUAN SANTOS
Checked by:	DA	VID SAMMEL, R.A
Design No or LLW No.: <b>D021557</b>	Facility Code: K171	Date: 04/14/2023

I.S. 171 - BROOKLYN **EXTERIOR MASONRY** 

528 Ridgewood Ave.

Brooklyn New York 11208

PHASE 2 THIRD FLOOR TEMPORARY EGRESS PLAN

DOB # B00836762 - I1


TE106.00

Sheets in GC Work Type Contract Set : 10 OF 43

Sheets in GC Work Type DOB Filing Set: 10 OF 38

THIRD FLOOR TEMPORARY EGRESS PLAN 3/32" = 1'-0"

NOTE:
PLANS ARE REPRODUCED FROM AN SCA RECORD SET. THE AREA OF WORK HAS BEEN VERIFIED TO MATCH THIS REFERENCE DRAWINGS

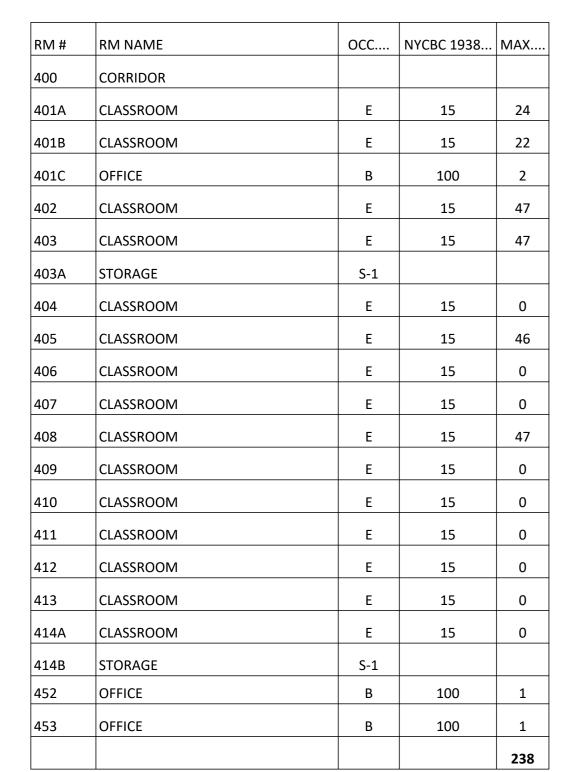

Sub-Article 1. General Egress Requirements (6.1.2.2.2). §C26-273.0 Required Exits.

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		,, ,		•	• ,
STAIR#	DOOR WIDTH	DOOR CAPACITY	STAIR WIDTH	STAIR CAPACITY PER C26-292.0 (2)(a)	NET
STAIR B	36	150	42	45	
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STAIR D	36	150	42	45	
STAIR E	36	150	42	45	
STAIR F	36	150	42	45	
STAIR G	36	150	42	45	CLOSED DURING PHASE 2
		750		270	


TOTAL (AVAILABLE EGRESS TO OCCUPANCY): 270 OCC. > 238 OCC. = OK


1938 BUILDING CODE

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**LEGEND TEMPORARY EGRESS:** 

President & CEO A. Nina Kubota

Peter McCree

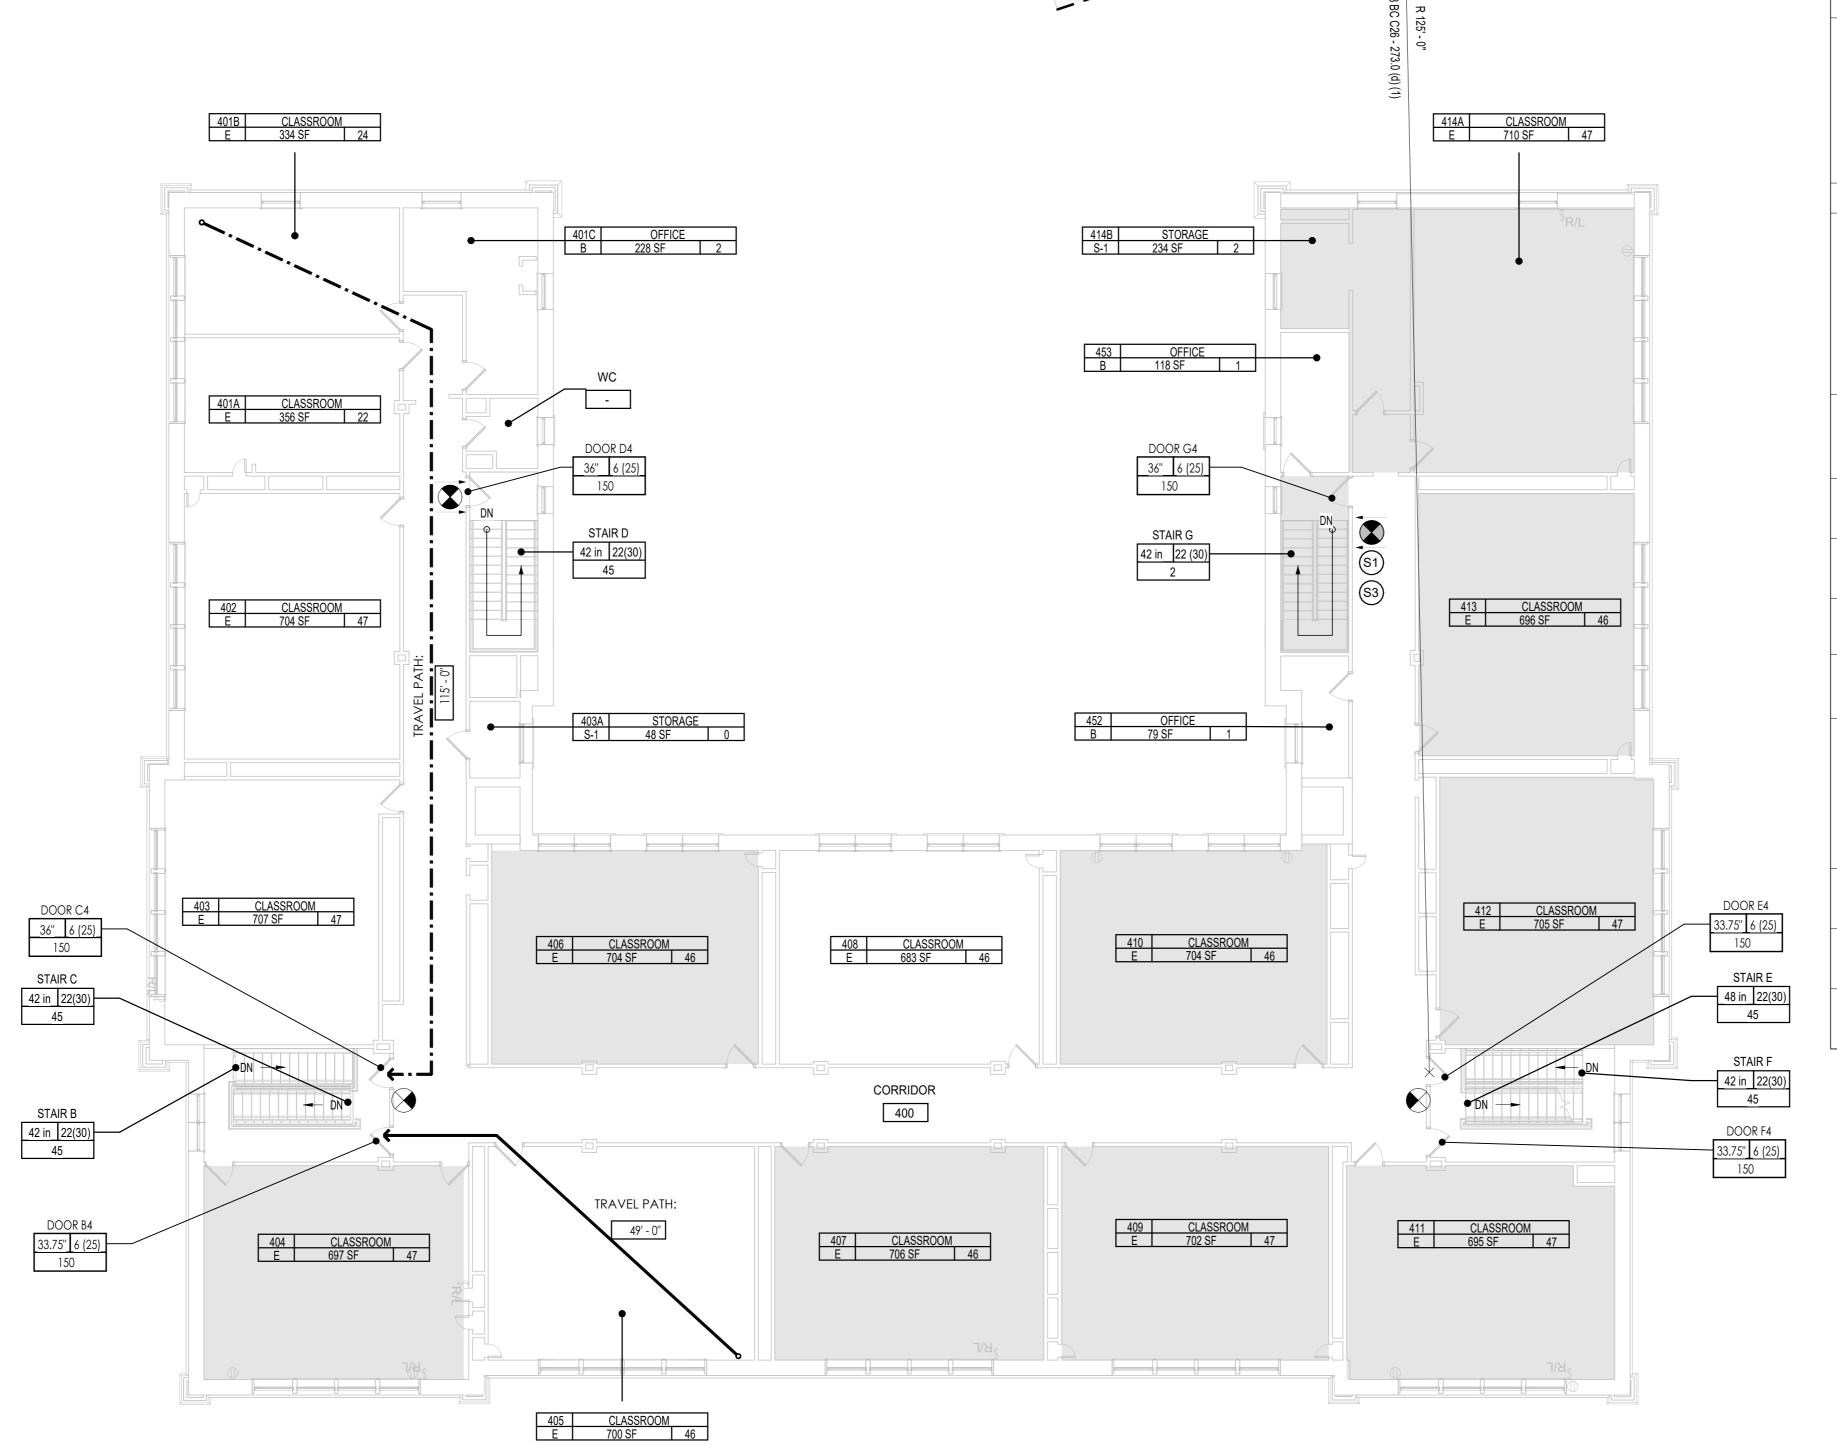**Board of Trustees** Chancellor David C. Banks, Chairman Lorraine Grillo

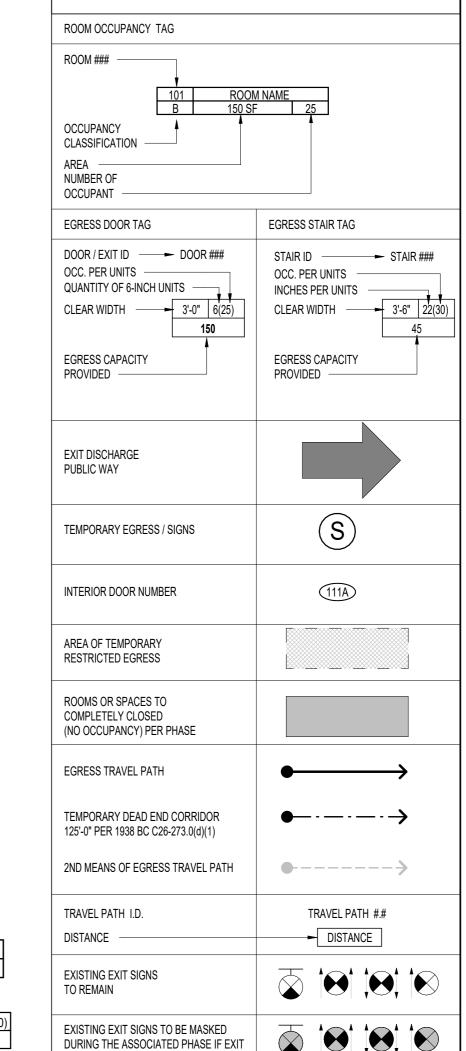

Architecture & Engineering

María A. Gómez, P.E. LEED AP BD+C, Acting Vice President Senior Director In-House Design Studio Design Consultant Management Studio Aileen del Prado, P.E. LEED AP BD+C, Senior Director

KATONAH, NEW YORK 10536 TEL (914) 276-0777 FAX (914) 276-0779 CPLteam.COM ARCHITECTURE ENGINEERING PLANNING


2875 ROUTE 35, SUITE 7S-1

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04/14/2023 Construction Documents Date Revisions



ASHRAF ELIAS, P.E SCA Design Manager: DAVID SAMMEL, R.A Project Architect/Engineer: DAVID HUNSBERGER, R.A Discipline Lead: JUAN SANTOS / JUAN POLANCO Designer: JUAN SANTOS Drawn by: DAVID SAMMEL, R.A Checked by: Facility Code: Design No or LLW No.: K171 D021557 04/14/2023

> I.S. 171 - BROOKLYN **EXTERIOR MASONRY**

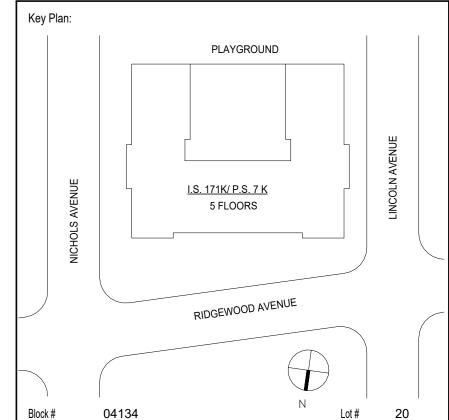528 Ridgewood Ave.

Brooklyn New York 11208

PHASE 2 FORTH FLOOR TEMPORARY

EGRESS PLAN

DOB # B00836762 - I1

TE107.00

Sheets in GC Work Type Contract Set : 11 OF 43

Sheets in GC Work Type DOB Filing Set:

11 OF 38

NOTE:
PLANS ARE REPRODUCED FROM AN SCA RECORD SET. THE AREA OF WORK HAS BEEN VERIFIED TO MATCH THIS REFERENCE DRAWINGS

3/32" = 1'-0"

**FOURTH FLOOR TEMPORARY EGRESS PLAN** 

# GENERAL NOTES

- 1. ALL ASBESTOS REMOVAL ACTIVITIES SHALL BE PERFORMED IN ACCORDANCE WITH ALL FEDERAL, STATE, LOCAL LAWS AND REGULATIONS.
- 2. ALL WORK TO SUPPORT ASBESTOS REMOVAL ACTIVITIES, INCLUDING BUT NOT LIMITED TO MAINTENANCE OF UTILITIES, TEMPORARY FACILITIES AND BARRICADES AND TRANSPORTATION OF ASBESTOS WASTE AND CONSTRUCTION DEBRIS, SHALL CONFORM TO ALL FEDERAL, STATE AND LOCAL LAWS AND REGULATIONS.
- 3. DRAWINGS ARE DIAGRAMMATIC ONLY AND ARE MEANT TO CONVEY THE GENERAL REQUIREMENTS FOR IDENTIFYING THE WORK AREA(S). THE CONTRACTOR WILL BE RESPONSIBLE FOR EXAMINING THE PREMISES BEFORE SUBMITTING A PROPOSAL FOR THE WORK AND TO HAVE VERIFIED ALL EXISTING CONDITIONS UNDER WHICH HE/HER WILL BE OBLIGED TO OPERATE OR THAT WILL IN ANY WAY AFFECT THE WORK UNDER THIS CONTRACT. NO ALLOWANCES WILL BE MADE FOR ANY ERRORS OR OMISSIONS BY THE CONTRACTOR.
- 4. THE CONTRACTOR SHALL CONSTRUCT ALL TEMPORARY BARRIER WALLS, PLATFORMS, ETC., USING FIRE RETARDANT LUMBER. METAL STUDS MAY BE USED IN PLACE OF WOODEN 2" BY 4" STUDS FOR BARRIER WALLS.
- 5. ALL POLYETHYLENE SHEETING SHALL BE A MINIMUM 6-MIL FIRE RETARDANT TYPE.
- 6. THE CONTRACTOR SHALL PROVIDE ELECTRICITY AND DOMESTIC WATER FOR CONSTRUCTION PURPOSES. THE CONTRACTOR SHALL BE RESPONSIBLE FOR, AT NO ADDITIONAL COST, VERIFYING THE LOCATION(S) OF, AND ADAPTATION TO, THESE EXISTING SERVICES TO MEET THE REQUIREMENTS OF THE CONTRACT DOCUMENTS AND THE APPROVAL OF THE OWNER. ELECTRIC SHALL MEET NFPA 70. NEC AND THE NATIONAL ELECTRICAL SAFETY CODE REQUIREMENTS AND BE CONDUCTED BY A LICENSE ELECTRICIAN WHO POSSESSES A VALID NYS + NYC ASBESTOS HANDLERS LICENSE.
- 7. ALL TEMPORARY POWER AND LIGHT CIRCUITS SHALL BE PROTECTED WITH GROUND FAULT INTERRUPTION. THE TEMPORARY POWER SYSTEMS SHALL BE DESIGNED AND PROVIDED BY A LICENSED ELECTRICIAN WHO POSSESSES A VALID NYS + NYC ASBESTOS HANDLERS LICENSE AND IT SHALL BE SUPPLIED FROM THE MAIN SWITCHBOARD (EXISTING BREAKERS WHICH HAVE BEEN TURNED "OFF").
- 8. THE CONTRACTOR SHALL BE SOLELY RESPONSIBLE FOR PROVIDING AND MAINTAINING ALL REMOVAL AREAS IN A SAFE ELECTRICAL CONDITION FOR THE WORKERS ENGAGED IN REMOVAL ACTIVITIES.
- 9. THE CONTRACTOR SHALL SUPPLY ALL MATERIALS, EQUIPMENT AND LABOR TO FULLY SHUTDOWN, SEAL AND PROTECT THE BUILDING'S HVAC SYSTEMS FROM CONTAMINATION, PRIOR TO THE REMOVAL OF ASBESTOS CONTAINING MATERIALS IN EACH WORK AREA (SUPPLY, RETURN AND EXHAUST) SHALL BE SHUTDOWN AND LOCKED-OUT AND THE RELATED DUCTWORK BLOCKED AND SEALED AIR AND WATER TIGHT.
- 10. THE CONTRACTOR SHALL BE RESPONSIBLE FOR REPAIRS TO THE BUILDING STRUCTURE AND CONTENTS (FIXED AND MOVABLE) THAT ARE A RESULT OF THE CONTRACTORS ACTIVITIES FOR THE DURATION OF THIS CONTRACT. THIS WORK SHALL BE PERFORMED AT NO ADDITIONAL COST TO THE OWNER AND BE SUBJECT TO THE OWNER'S APPROVAL.

- 11. THE CONTRACTOR SHALL SUPPLY RESPIRATORS, COVERALLS, GLOVES SAFETY GLASSES AND HARD HATS FOR AUTHORIZED VISITORS.
- 12. THE CONTRACTOR SHALL SUPPLY SHOP DRAWINGS OR AN ILLUSTRATED WORK PLAN SHOWING THE LOCATION OF THE MOBILE HEPA UNITS THROUGHOUT THE WORK AREAS, WITH THE NUMBER OF UNITS EXHAUSTING FROM SAID WORK AREAS.
- 13. DURING THE ABATEMENT WORK. ALL FIRE EXITS MUST BE ACCESSIBLE FOR CONTRACTOR PERSONNEL.
- 14. THE FINAL SEQUENCE AND CONFIGURATION OF THE WORK AREAS FOR THE PROJECT SHALL BE APPROVED BY THE OWNER'S REPRESENTATIVE.
- 15. THE CONTRACTOR SHALL BE RESPONSIBLE FOR PROTECTING ALL WORK AREAS DURING ABATEMENT AGAINST ANY DAMAGE, BREAKAGE, COLLAPSE, DISTORTION AND MISALIGNMENT ACCORDING TO APPLICABLE CODES AND GOOD PRACTICE.
- 16. ALL DEBRIS GENERATED BY THE ABATEMENT WORK SHALL BE DEEMED TO BE WASTE CONTAINING ASBESTOS. DISPOSAL SHALL BE IN ACCORDANCE WITH THE PROVISION OF LOCAL LAW 70/85 AND THE REGULATION PROMULGATED THERETO BY THE DEPARTMENT OF SANITATION FOR WASTE CONTAINING ASBESTOS.
- 17. SEE SECTION 02081 FOR QUANTITIES.
- 18. DECONTAMINATION UNITS SHALL BE UTILIZED IN ACCORDANCE WITH ALL APPLICABLE AND RELEVANT CODES, RULES, AND REGULATIONS. LOCATION OF DECONTAMINATION UNITS SHALL BE APPROVED BY THE AUTHORITY.
- 19. PROVISIONS AS DEFINED ON DRAWING T002.00 MAY IMPACT AREAS NOT OTHERWISE SPECIFIED IN THESE DRAWINGS.
- 20. ANY NON-SUSPECT COMPONENTS/MATERIALS IN CONTACT WITH ASSUMED ACM/ACM SHALL BE DISPOSED OF AS ACM-CONTAMINATED WASTE, AT NO ADDITIONAL COST TO THE AUTHORITY. THIS SHALL ALSO INCLUDE, BUT NOT BE LIMITED TO, BRICK, MORTAR, WINDOW FRAMES, SASHES, DOOR FRAMES, ETC. IN LIEU OF DISPOSING THESE MATERIALS, THE CONTRACTOR MAY OPT TO DECONTAMINATE THESE COMPONENTS & DISPOSE OF THEM AS REGULAR C&D WASTE (IF NOT POROUS).

President & CEO A. Nina Kubota

Peter McCree

**Board of Trustees** Chancellor David C. Banks, Chairman



Architecture & Engineering

María A. Gómez, P.E. LEED AP BD+C, Acting Vice President Senior Director In-House Design Studio Design Consultant Management Studio

Aileen del Prado, P.E. LEED AP BD+C, Senior Director


KATONAH, NEW YORK 10536 TEL (914) 276-0777 FAX (914) 276-0779 CPLteam.COM ARCHITECTURE ENGINEERING PLANNING

Eg Taylor Environmental Group Taylor Environmental Group, Inc. 130A Jericho Turnpike Floral Park, NY 11001 Phone: (516) 358-2955

Drawing may be printed at reduced scale

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04/14/2023 Construction Documents

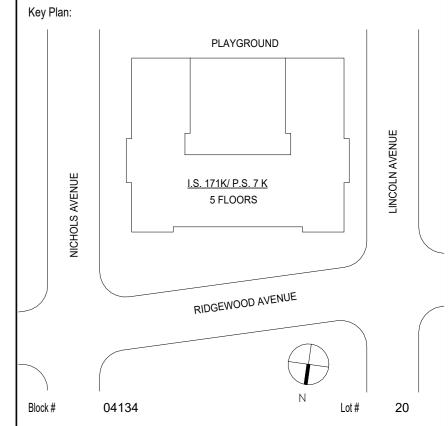

SCA Design Manager:	AS	SHRAF ELIAS, P.E	
Project Architect/Engineer:	DA	VID SAMMEL, R.A	
Discipline Lead:	DAVID HU	JNSBERGER, R.A	
Designer:	GEORGE TAYLOR AH-88-07652		
Drawn by:	STEVEN LEVI	TON AH-16-09055	
Checked by:	GEORGE TAY	LOR AH-88-07652	
Design No or LLW No.: D021557	Facility Code:	Date: 04/14/2023	

I.S. 171 - BROOKLYN **EXTERIOR MASONRY** 

528 Ridgewood Ave.

Brooklyn New York 11208


ASBESTOS ABATEMENT GENERAL NOTES


DOB # B00836762 - I1

H101.00


Sheets in GC Work Type Contract Set 38 OF 43

Sheets in GC Work Type DOB Filing Set: - OF 38

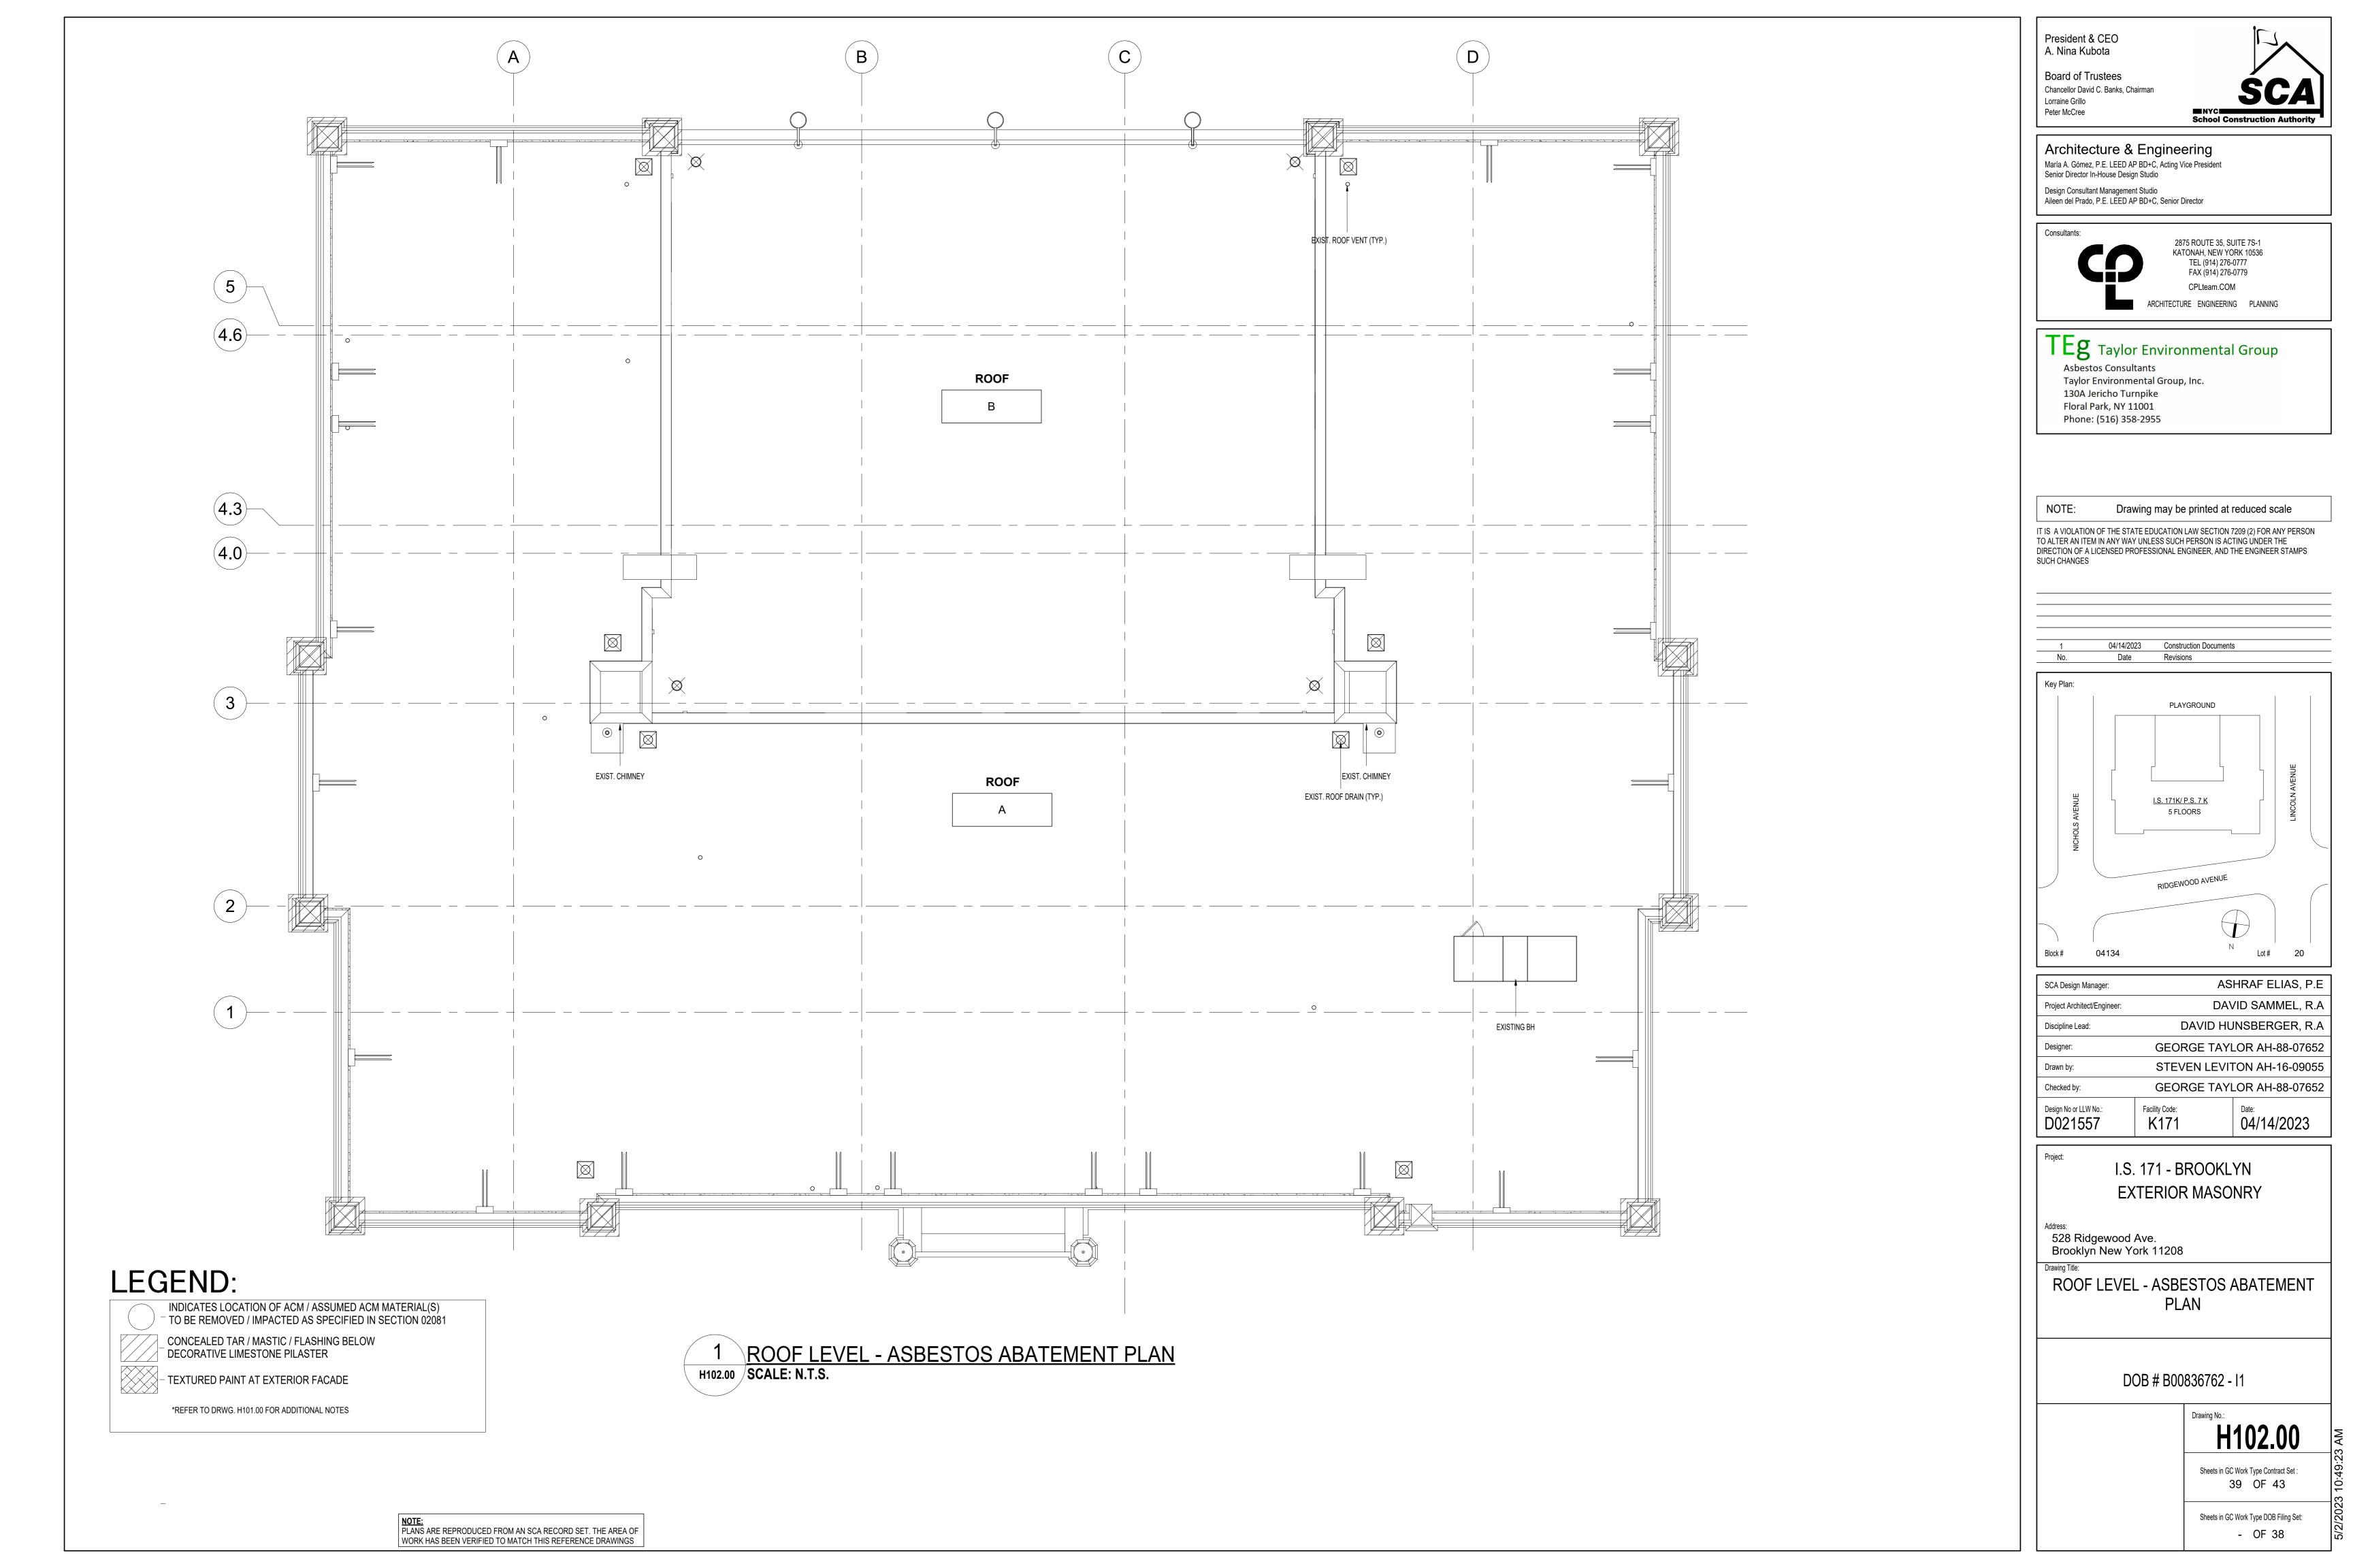


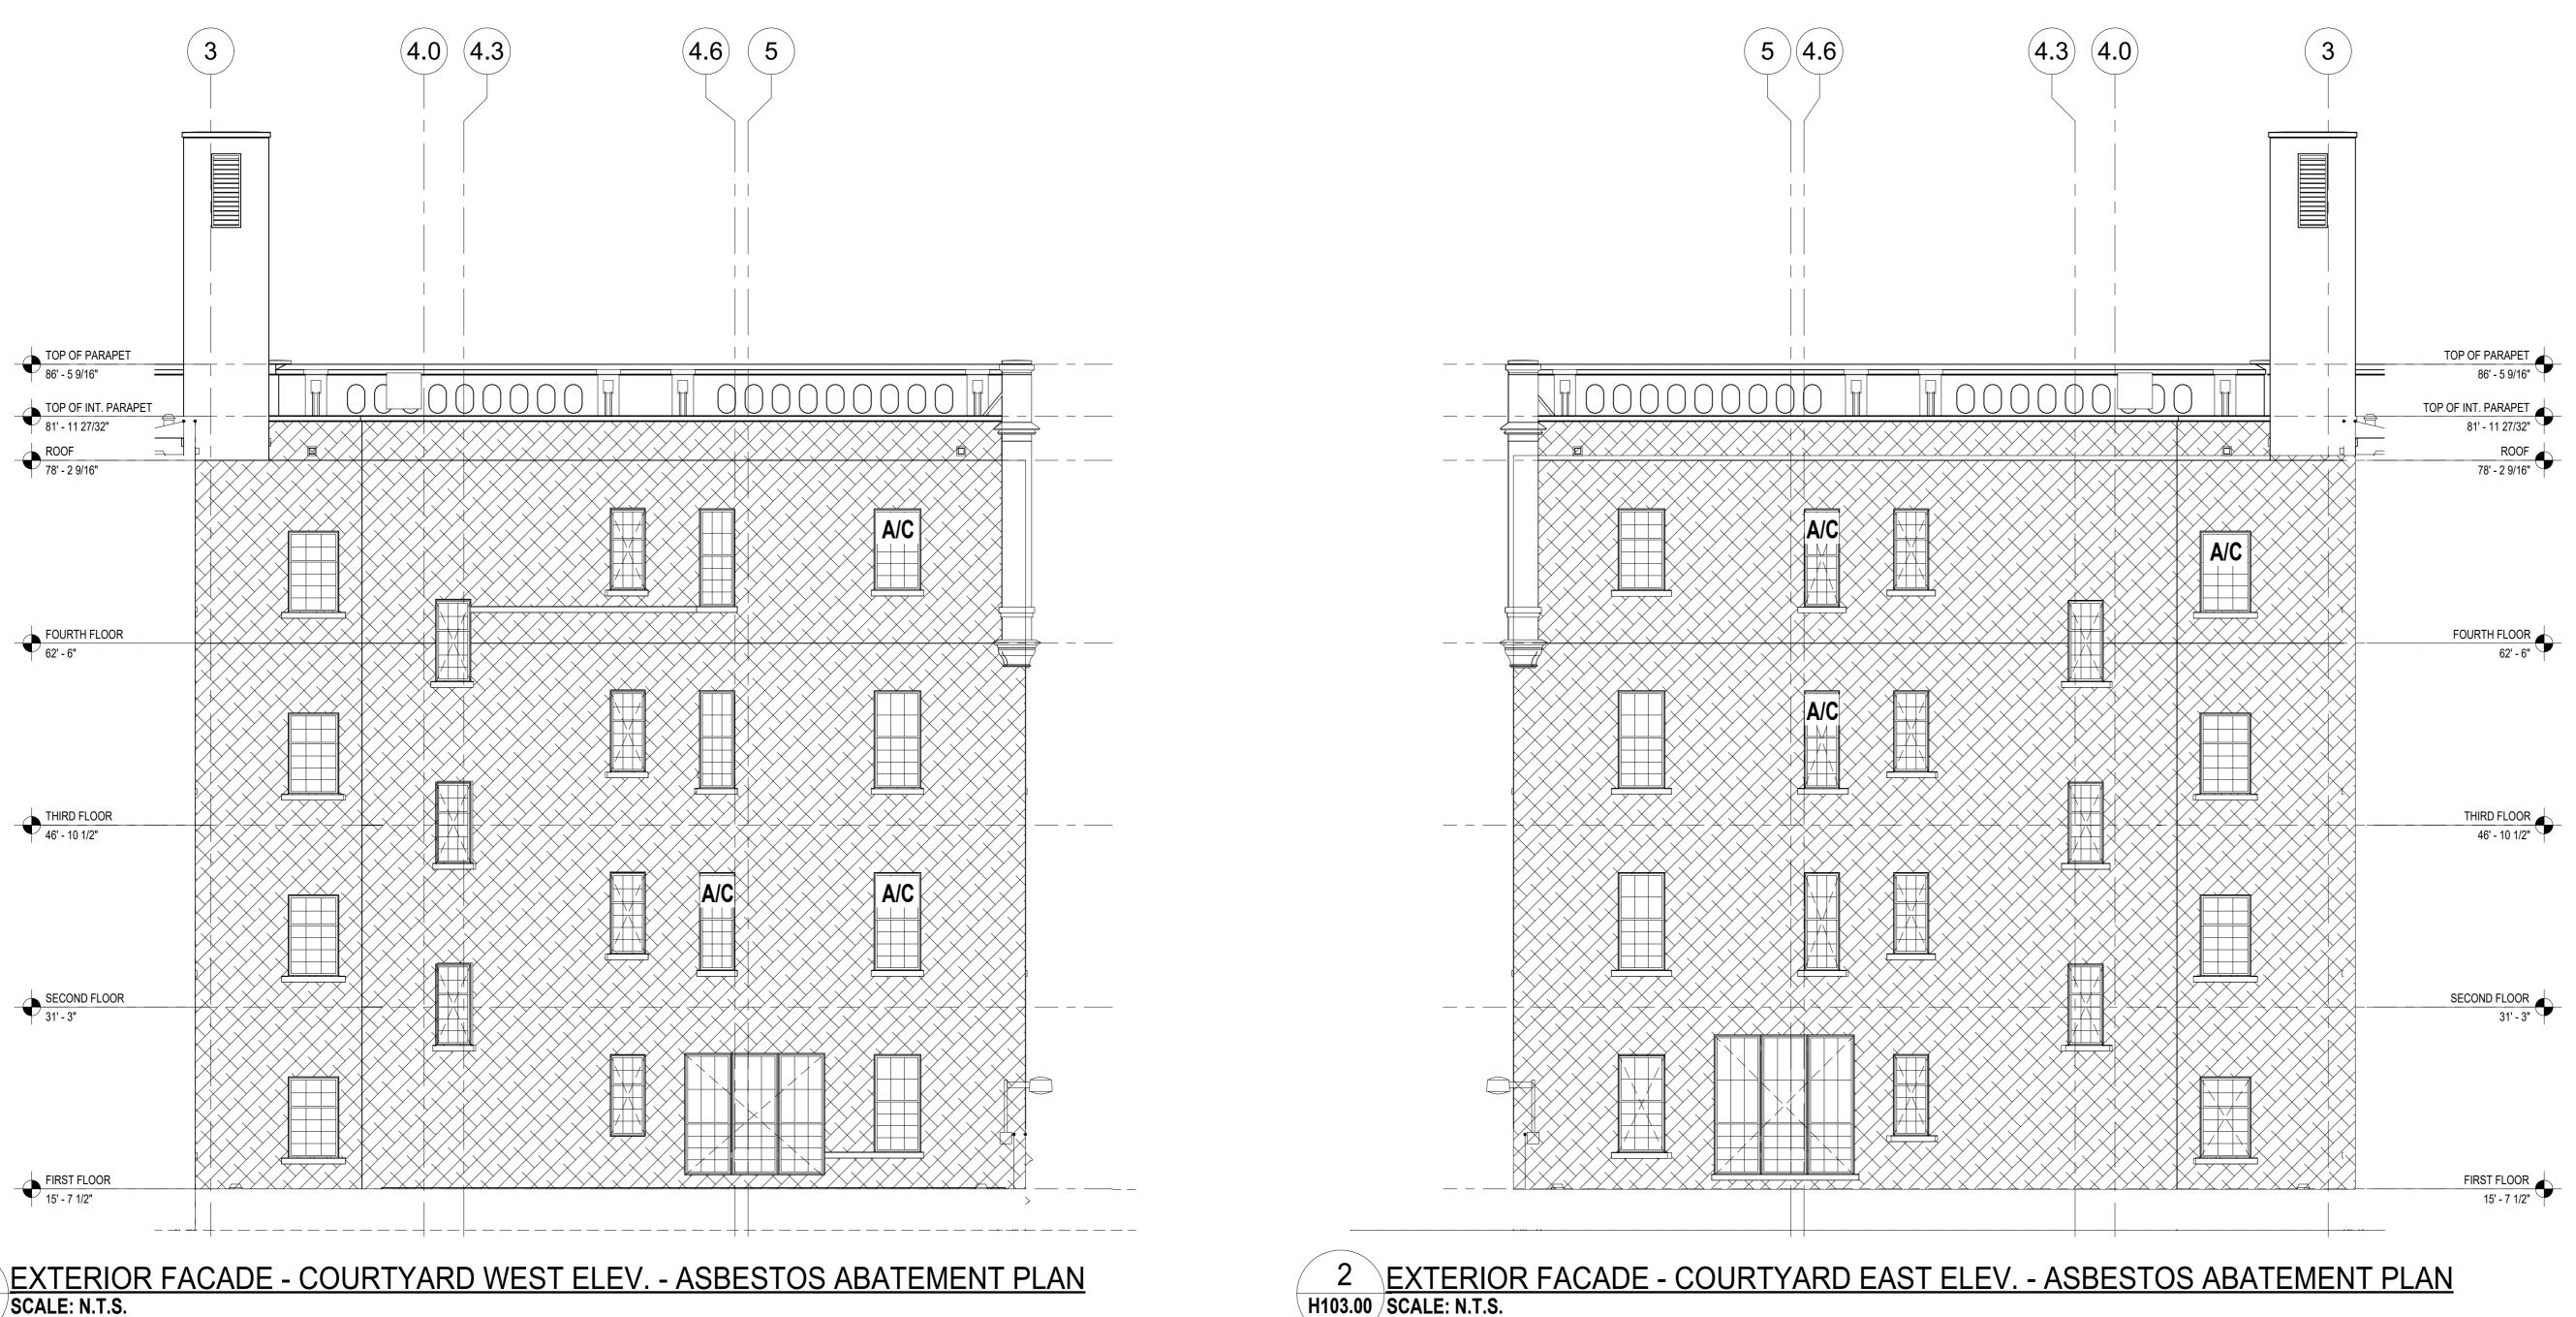

H103.00 SCALE: N.T.S.

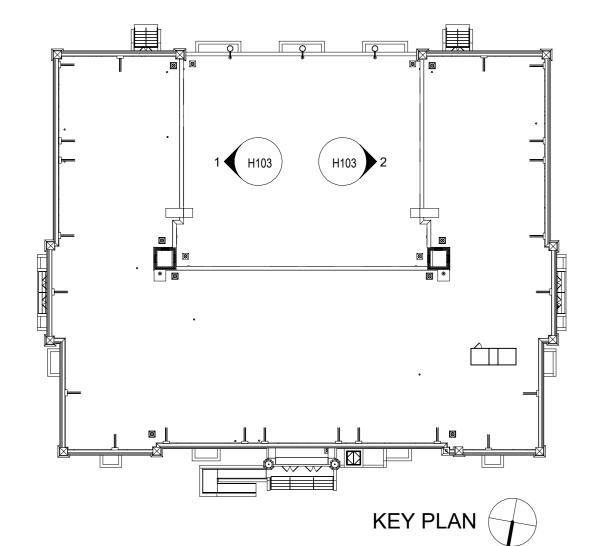

# LEGEND:

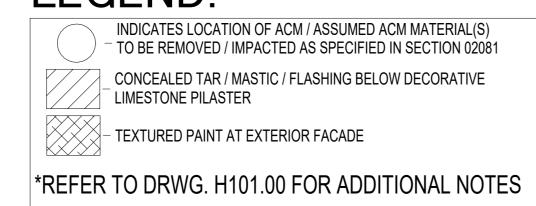

NOTE:
PLANS ARE REPRODUCED FROM AN SCA RECORD SET. THE AREA OF WORK HAS BEEN VERIFIED TO MATCH THIS REFERENCE DRAWINGS

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Peter McCree

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2875 ROUTE 35, SUITE 7S-1 KATONAH, NEW YORK 10536

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Drawing may be printed at reduced scale

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04/14/2023 Construction Documents Date Revisions Key Plan: PLAYGROUND I.S. 171K/ P.S. 7 K

	SCA Design Manager:	AS	HRAF ELIAS, P.E
	Project Architect/Engineer:	DA\	/ID SAMMEL, R.A
	Discipline Lead:	DAVID HU	INSBERGER, R.A
	Designer:	GEORGE TAYI	_OR AH-88-07652
	Drawn by:	STEVEN LEVI	ΓΟΝ AH-16-09055
	Checked by:	GEORGE TAY	_OR AH-88-07652
	Design No or LLW No.: D021557	Facility Code:	Date: 04/14/2023

I.S. 171 - BROOKLYN **EXTERIOR MASONRY** 


528 Ridgewood Ave. Brooklyn New York 11208

EXTERIOR FACADE EAST AND WEST COURTYARD ELEVATIONS - ASBESTOS ABATEMENT PLAN


H103.00

Sheets in GC Work Type Contract Set : 40 OF 43


Sheets in GC Work Type DOB Filing Set: - OF 38

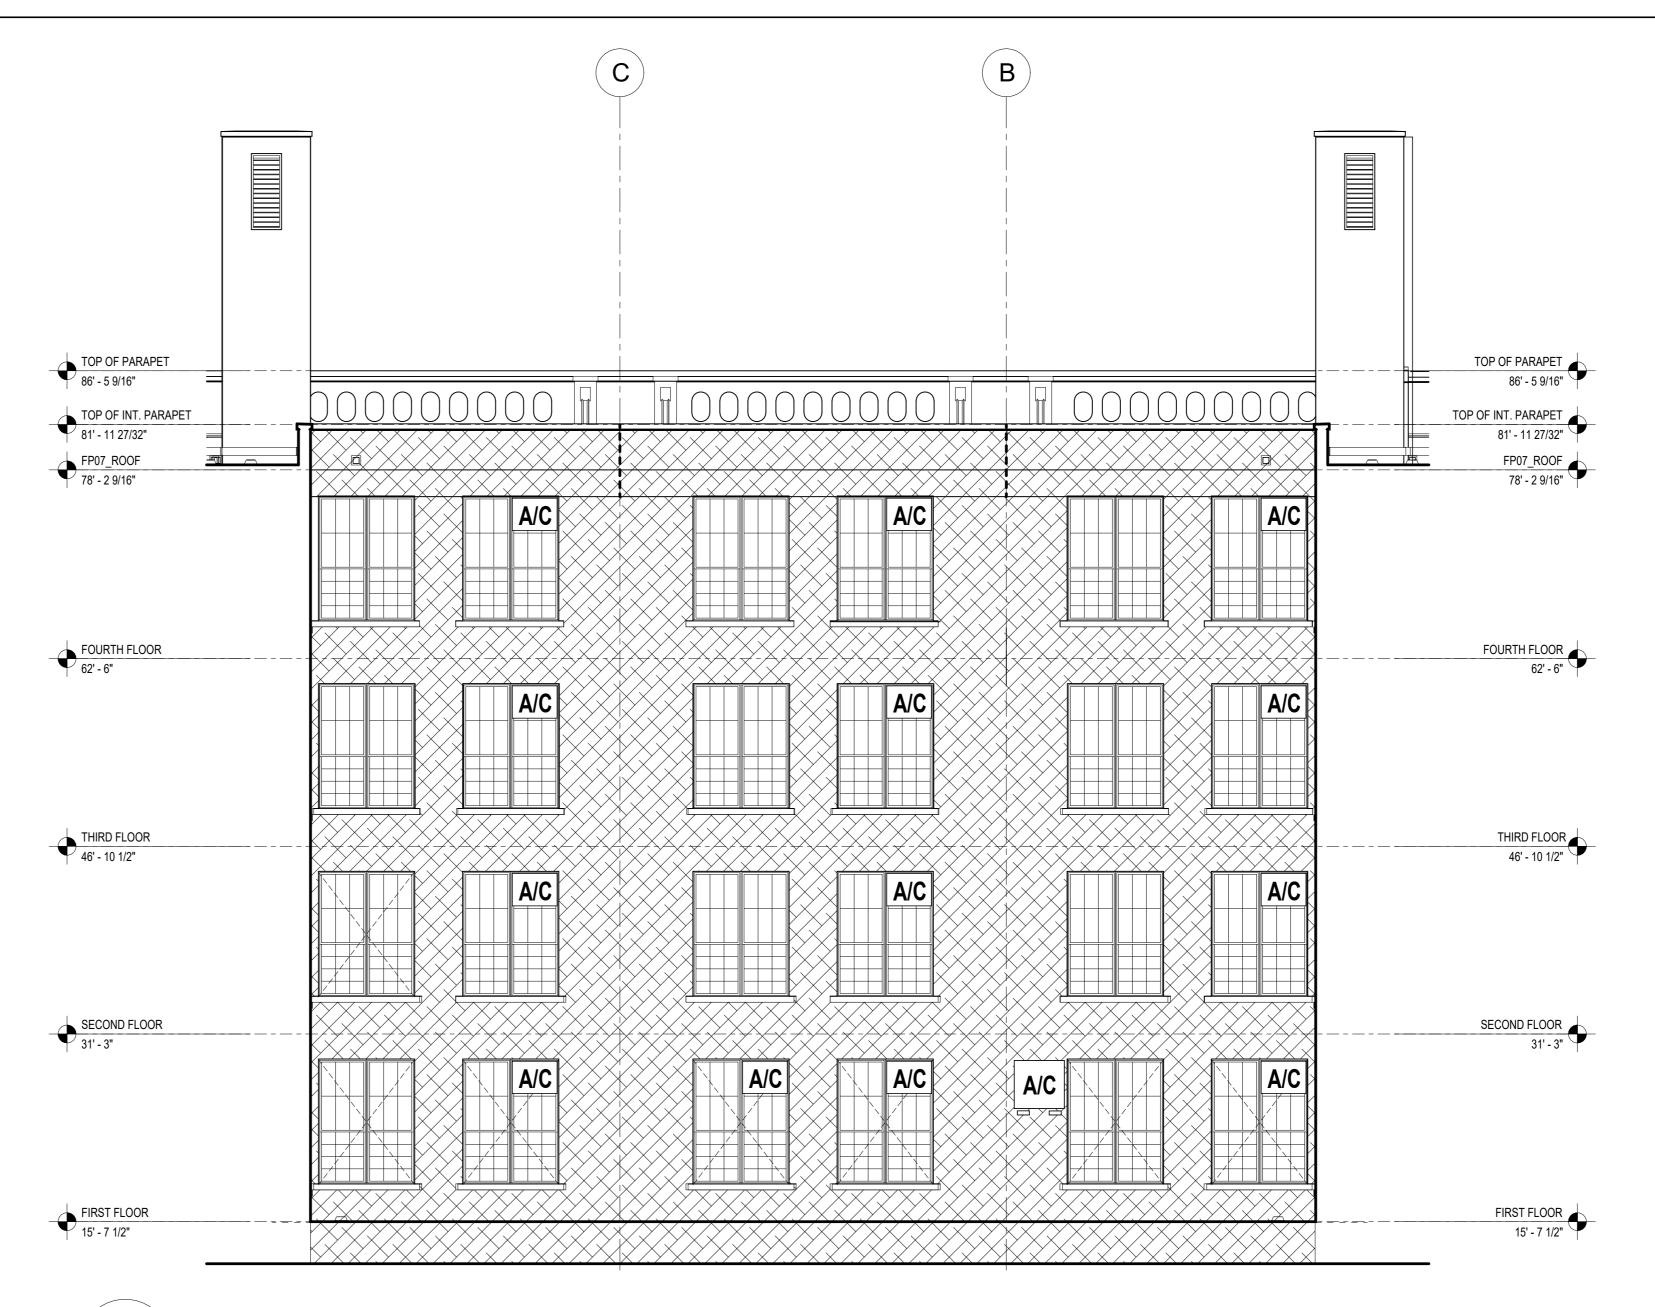

EXTERIOR FACADE - COURTYARD SOUTH ELEV. - ASBESTOS ABATEMENT PLAN H104.00 SCALE: N.T.S.

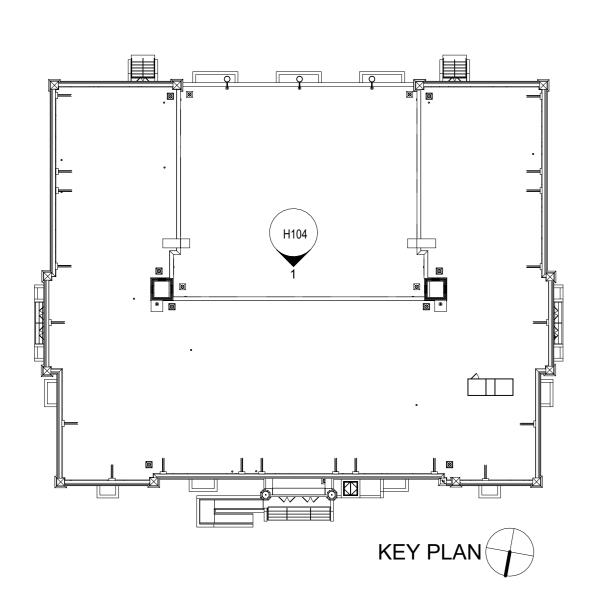

# LEGEND:

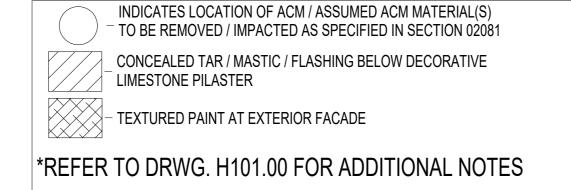

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Aileen del Prado, P.E. LEED AP BD+C, Senior Director




2875 ROUTE 35, SUITE 7S-1 KATONAH, NEW YORK 10536 TEL (914) 276-0777 FAX (914) 276-0779 CPLteam.COM ARCHITECTURE ENGINEERING PLANNING

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04/14/2023 Construction Documents Date Revisions



SCA Design Manager:	AS	HRAF ELIAS, P.E	
Project Architect/Engineer:	DAV	/ID SAMMEL, R.A	
Discipline Lead:	DAVID HU	JNSBERGER, R.A	
Designer:	GEORGE TAYLOR AH-88-07652		
Drawn by:	STEVEN LEVITON AH-16-0		
Checked by:	GEORGE TAY	LOR AH-88-07652	
Design No or LLW No.:	Facility Code:	Date:	
D021557	K171	04/14/2023	

I.S. 171 - BROOKLYN **EXTERIOR MASONRY** 

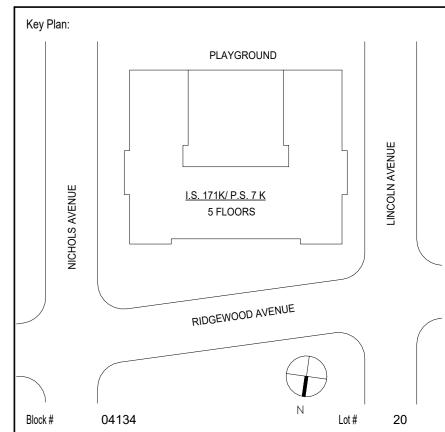528 Ridgewood Ave. Brooklyn New York 11208


EXTERIOR FACADE SOUTH COURTYARD **ELEVATION - ASBESTOS ABATEMENT** PLAN

DOB # B00836762 - I1

H104.00

Sheets in GC Work Type Contract Set : 41 OF 43

Sheets in GC Work Type DOB Filing Set: - OF 38

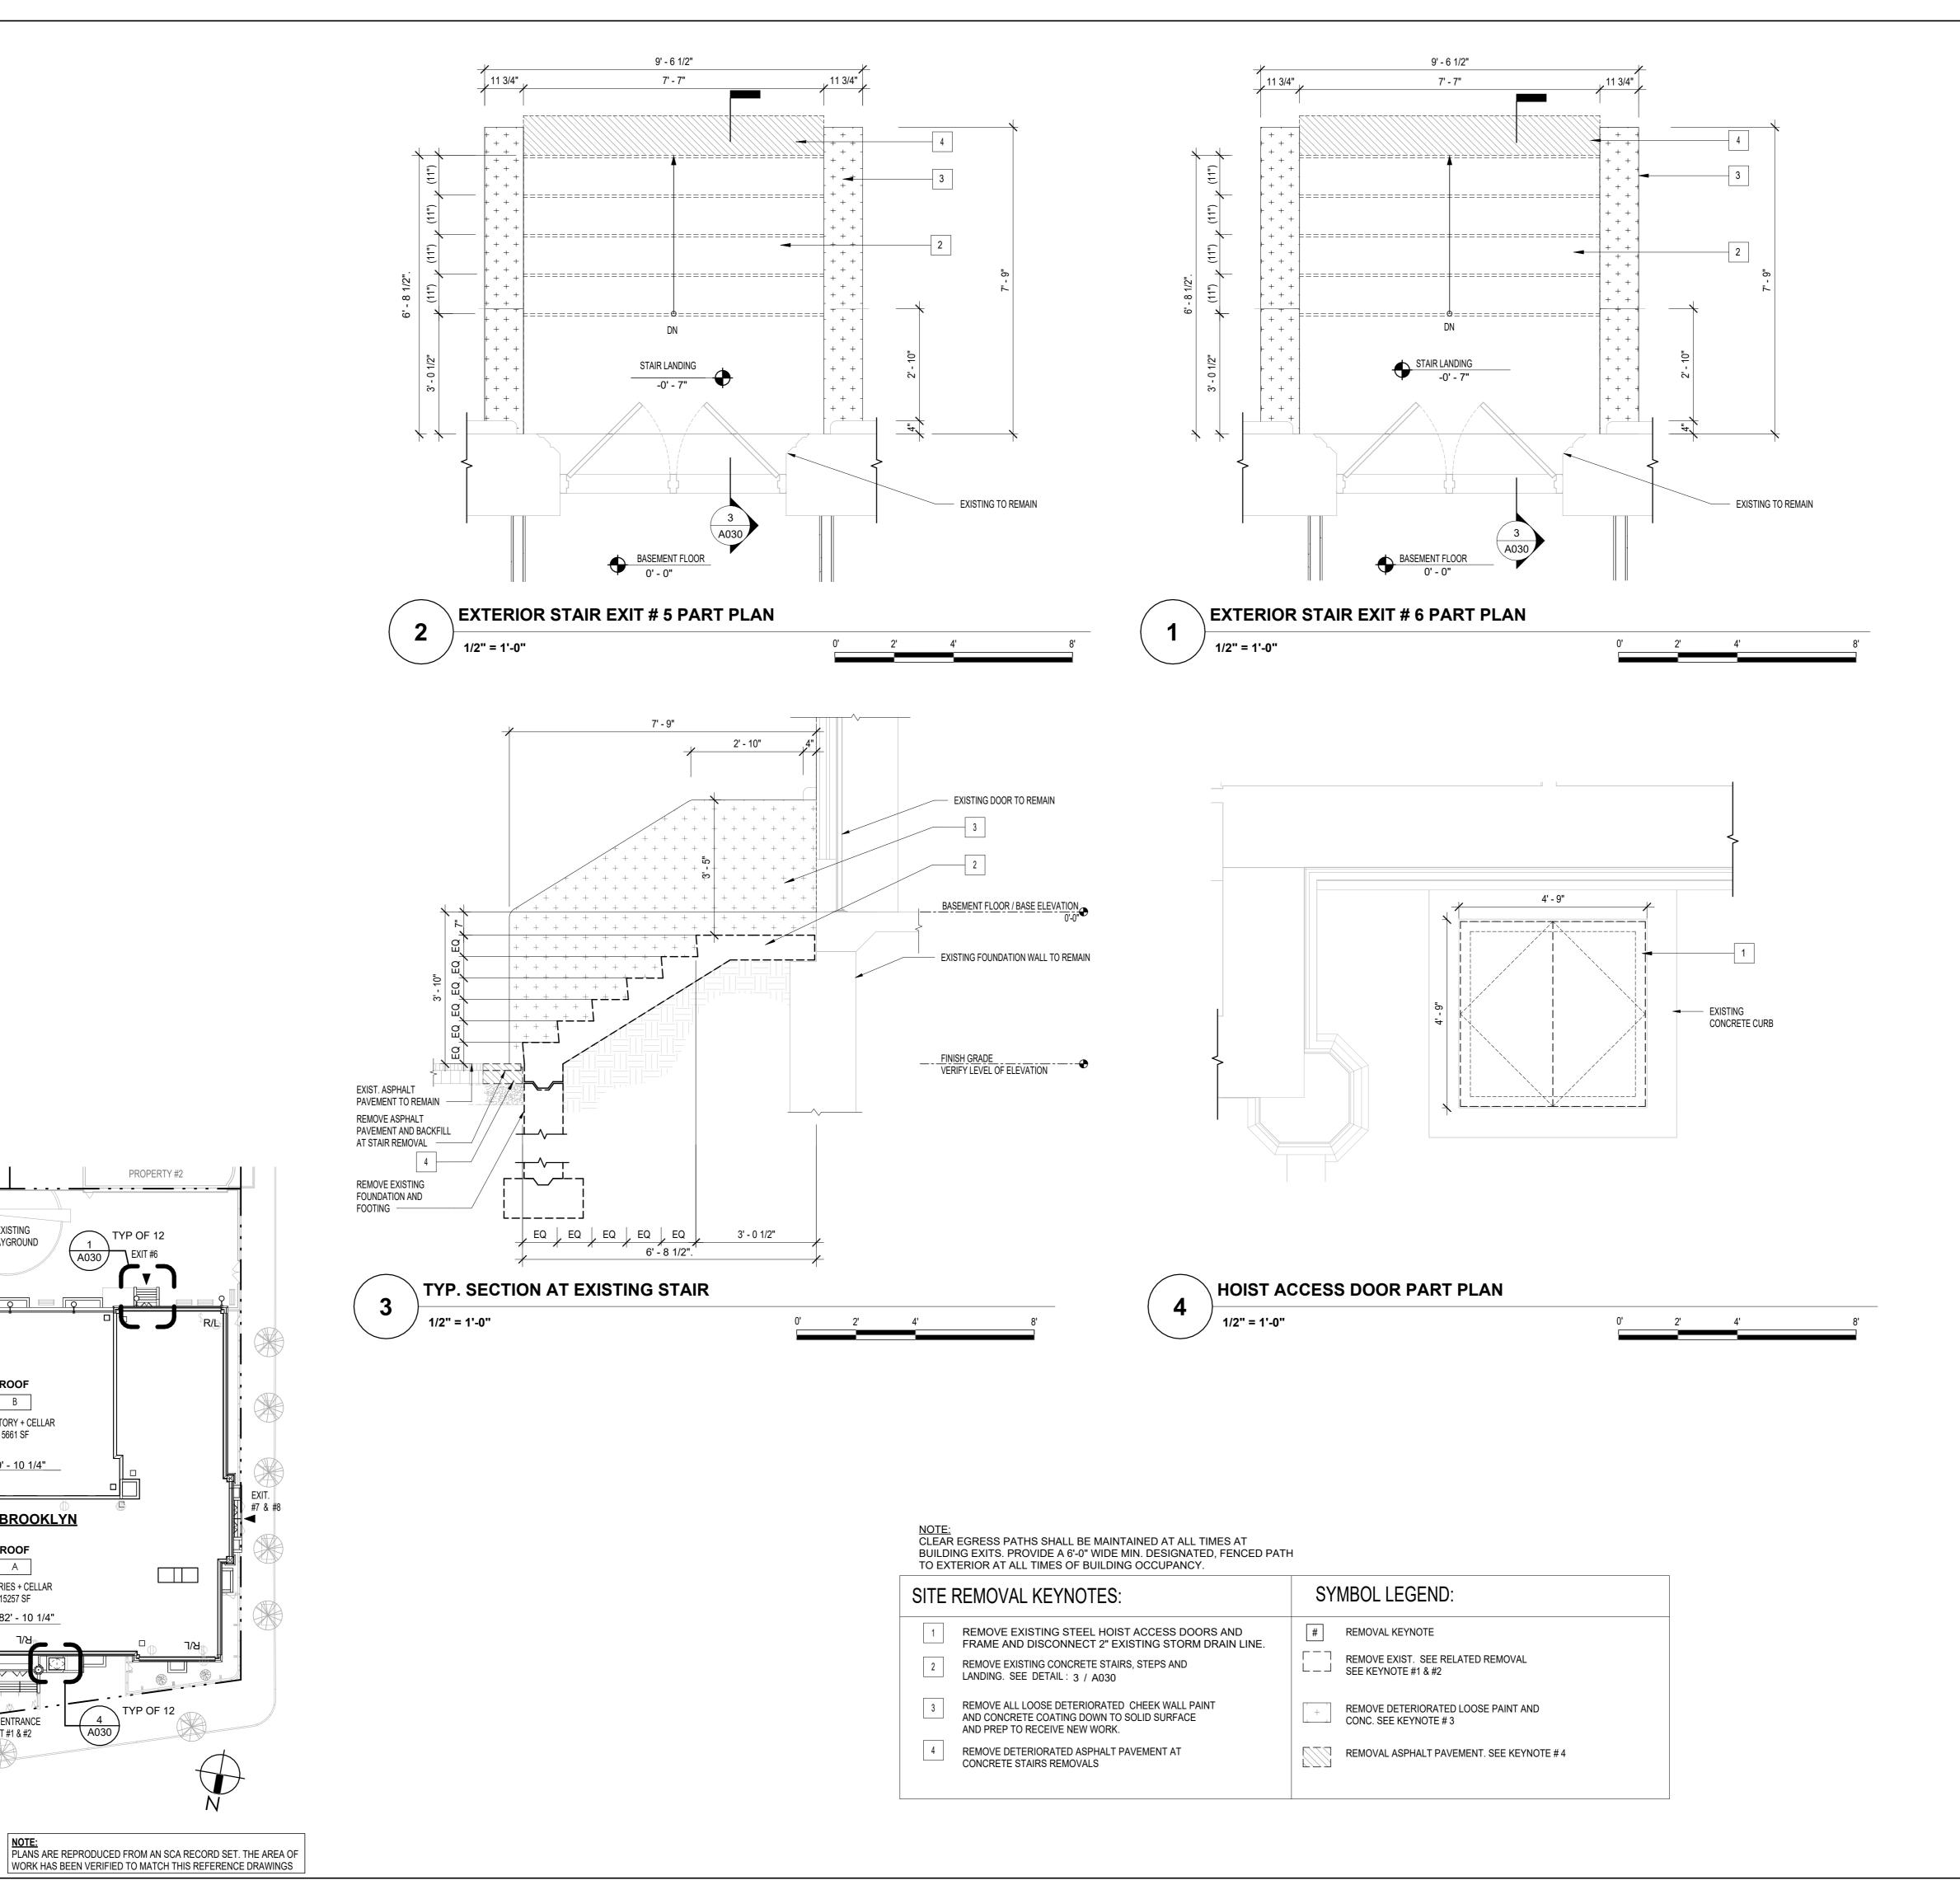

PROPERTY #1

**KEY PLAN:** 

PROPERTY #2

PLAYGROUND

ROOF В

ONE STORY + CELLAR 5661 SF

19' - 10 1/4"

I.S. 171 BROOKLYN

5 STORIES + CELLAR

15257 SF

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Phone: (516) 358-2955

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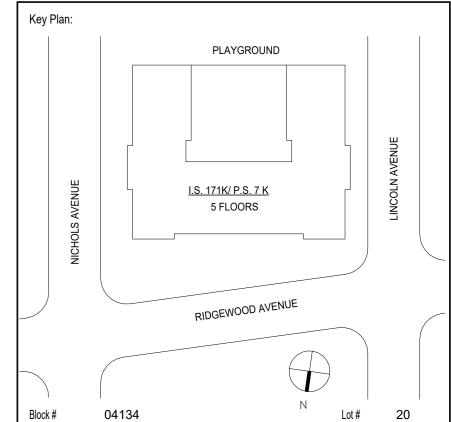
2875 ROUTE 35, SUITE 7S-1

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04/14/2023 Construction Documents Date Revisions



SCA Design Manager:	AS	HRAF ELIAS, P.E
Project Architect/Engineer:	DA\	/ID SAMMEL, R.A
Discipline Lead:	DAVID HU	INSBERGER, R.A
Designer:	JUAN SANTOS /	JUAN POLANCO
Drawn by:	ANA LIDIA LARA	/ JUAN SANTOS
Checked by:	DA\	/ID SAMMEL, R.A
Design No or LLW No.: D021557	Facility Code: K171	Date: 04/14/2023

I.S. 171 - BROOKLYN **EXTERIOR MASONRY** 

528 Ridgewood Ave. Brooklyn New York 11208


SELECTIVE REMOVAL – SITE PLANS

DOB # B00836762 - I1

A030.00

Sheets in GC Work Type Contract Set : 12 OF 43

Sheets in GC Work Type DOB Filing Set: 12 OF 38

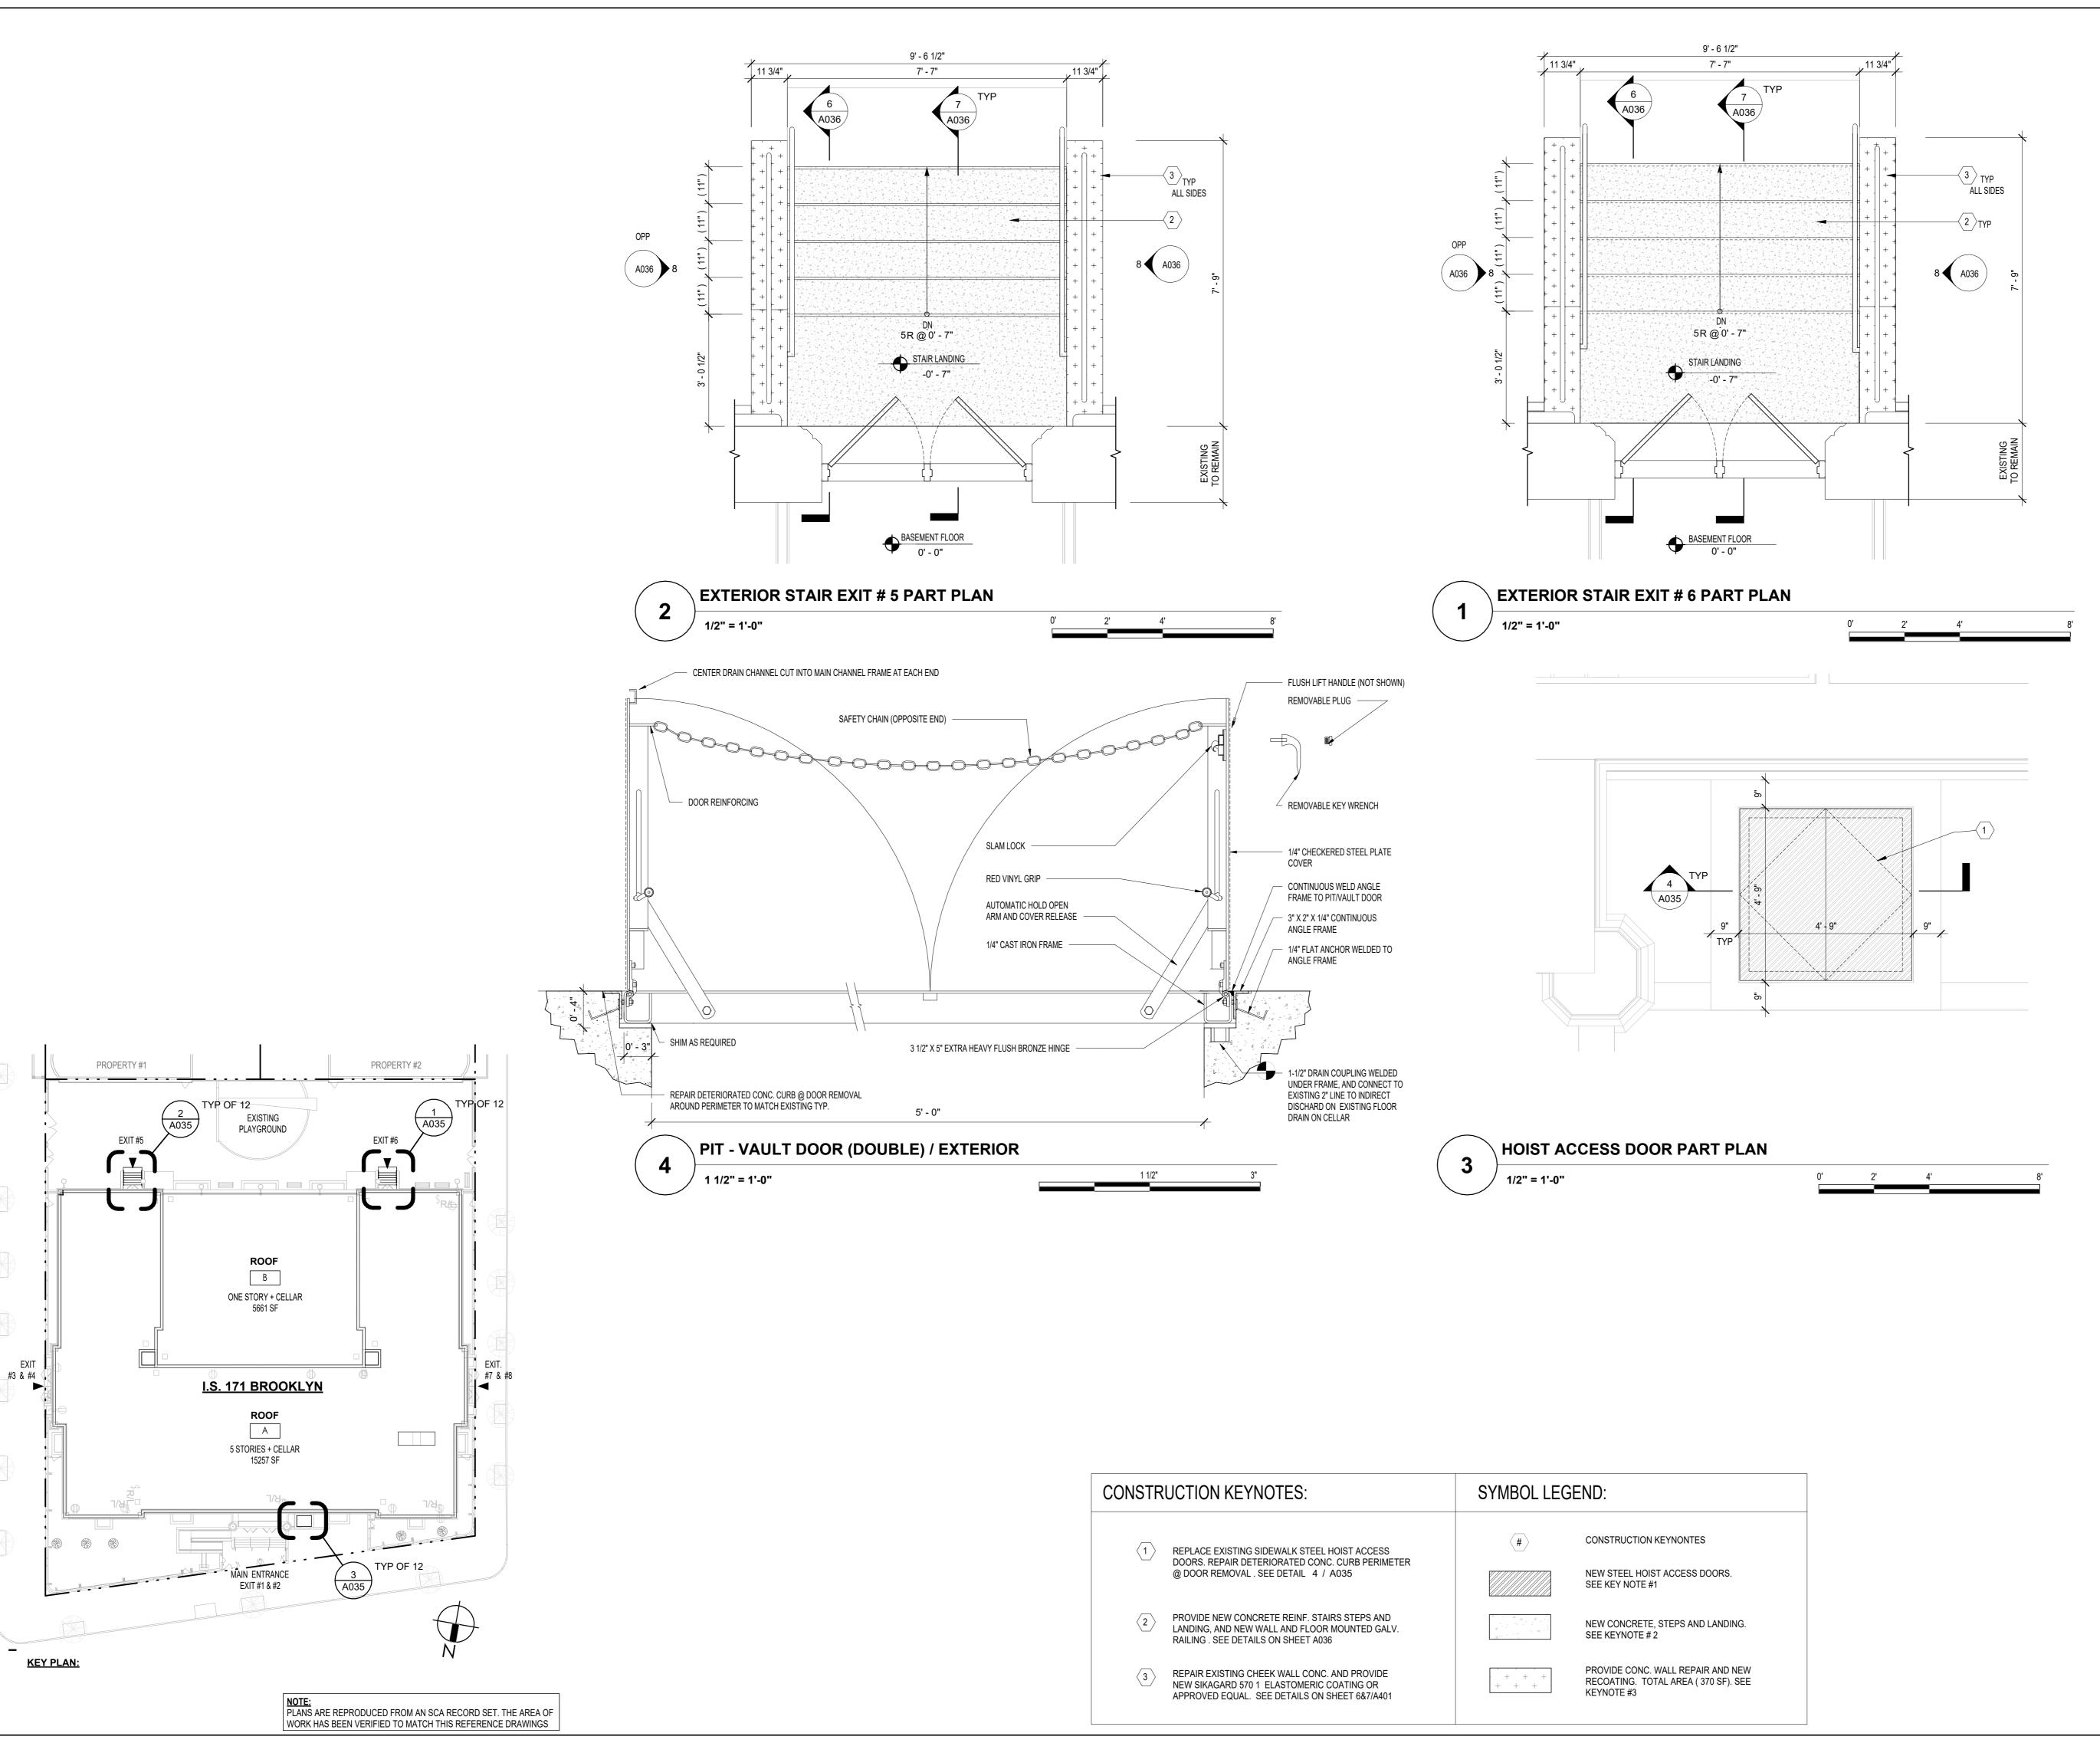

Peter McCree

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04/14/2023 Construction Documents Date Revisions Key Plan: PLAYGROUND I.S. 171K/ P.S. 7 K 5 FLOORS

RIDGEWOOD AVENUE

Block # 04134		Lot #	20
SCA Design Manager:	AS	HRAF ELI <i>A</i>	AS, P.E
Project Architect/Engineer:	DAVID SAMMEL, R.A		
Discipline Lead:	DAVID HUNSBERGER, R.A		
Designer:	JUAN SANTOS / JUAN POLANCO		
Drawn by:	ANA LIDIA LARA / JUAN SANTOS		
Checked by:	DA\	/ID SAMME	EL, R.A
Design No or LLW No.: D021557	Facility Code: K171	Date: 04/14/2	023

I.S. 171 - BROOKLYN **EXTERIOR MASONRY** 

528 Ridgewood Ave. Brooklyn New York 11208


NEW WORK - SITE PLAN

DOB # B00836762 - I1

A035.00

Sheets in GC Work Type Contract Set : 13 OF 43

Sheets in GC Work Type DOB Filing Set: 13 OF 38

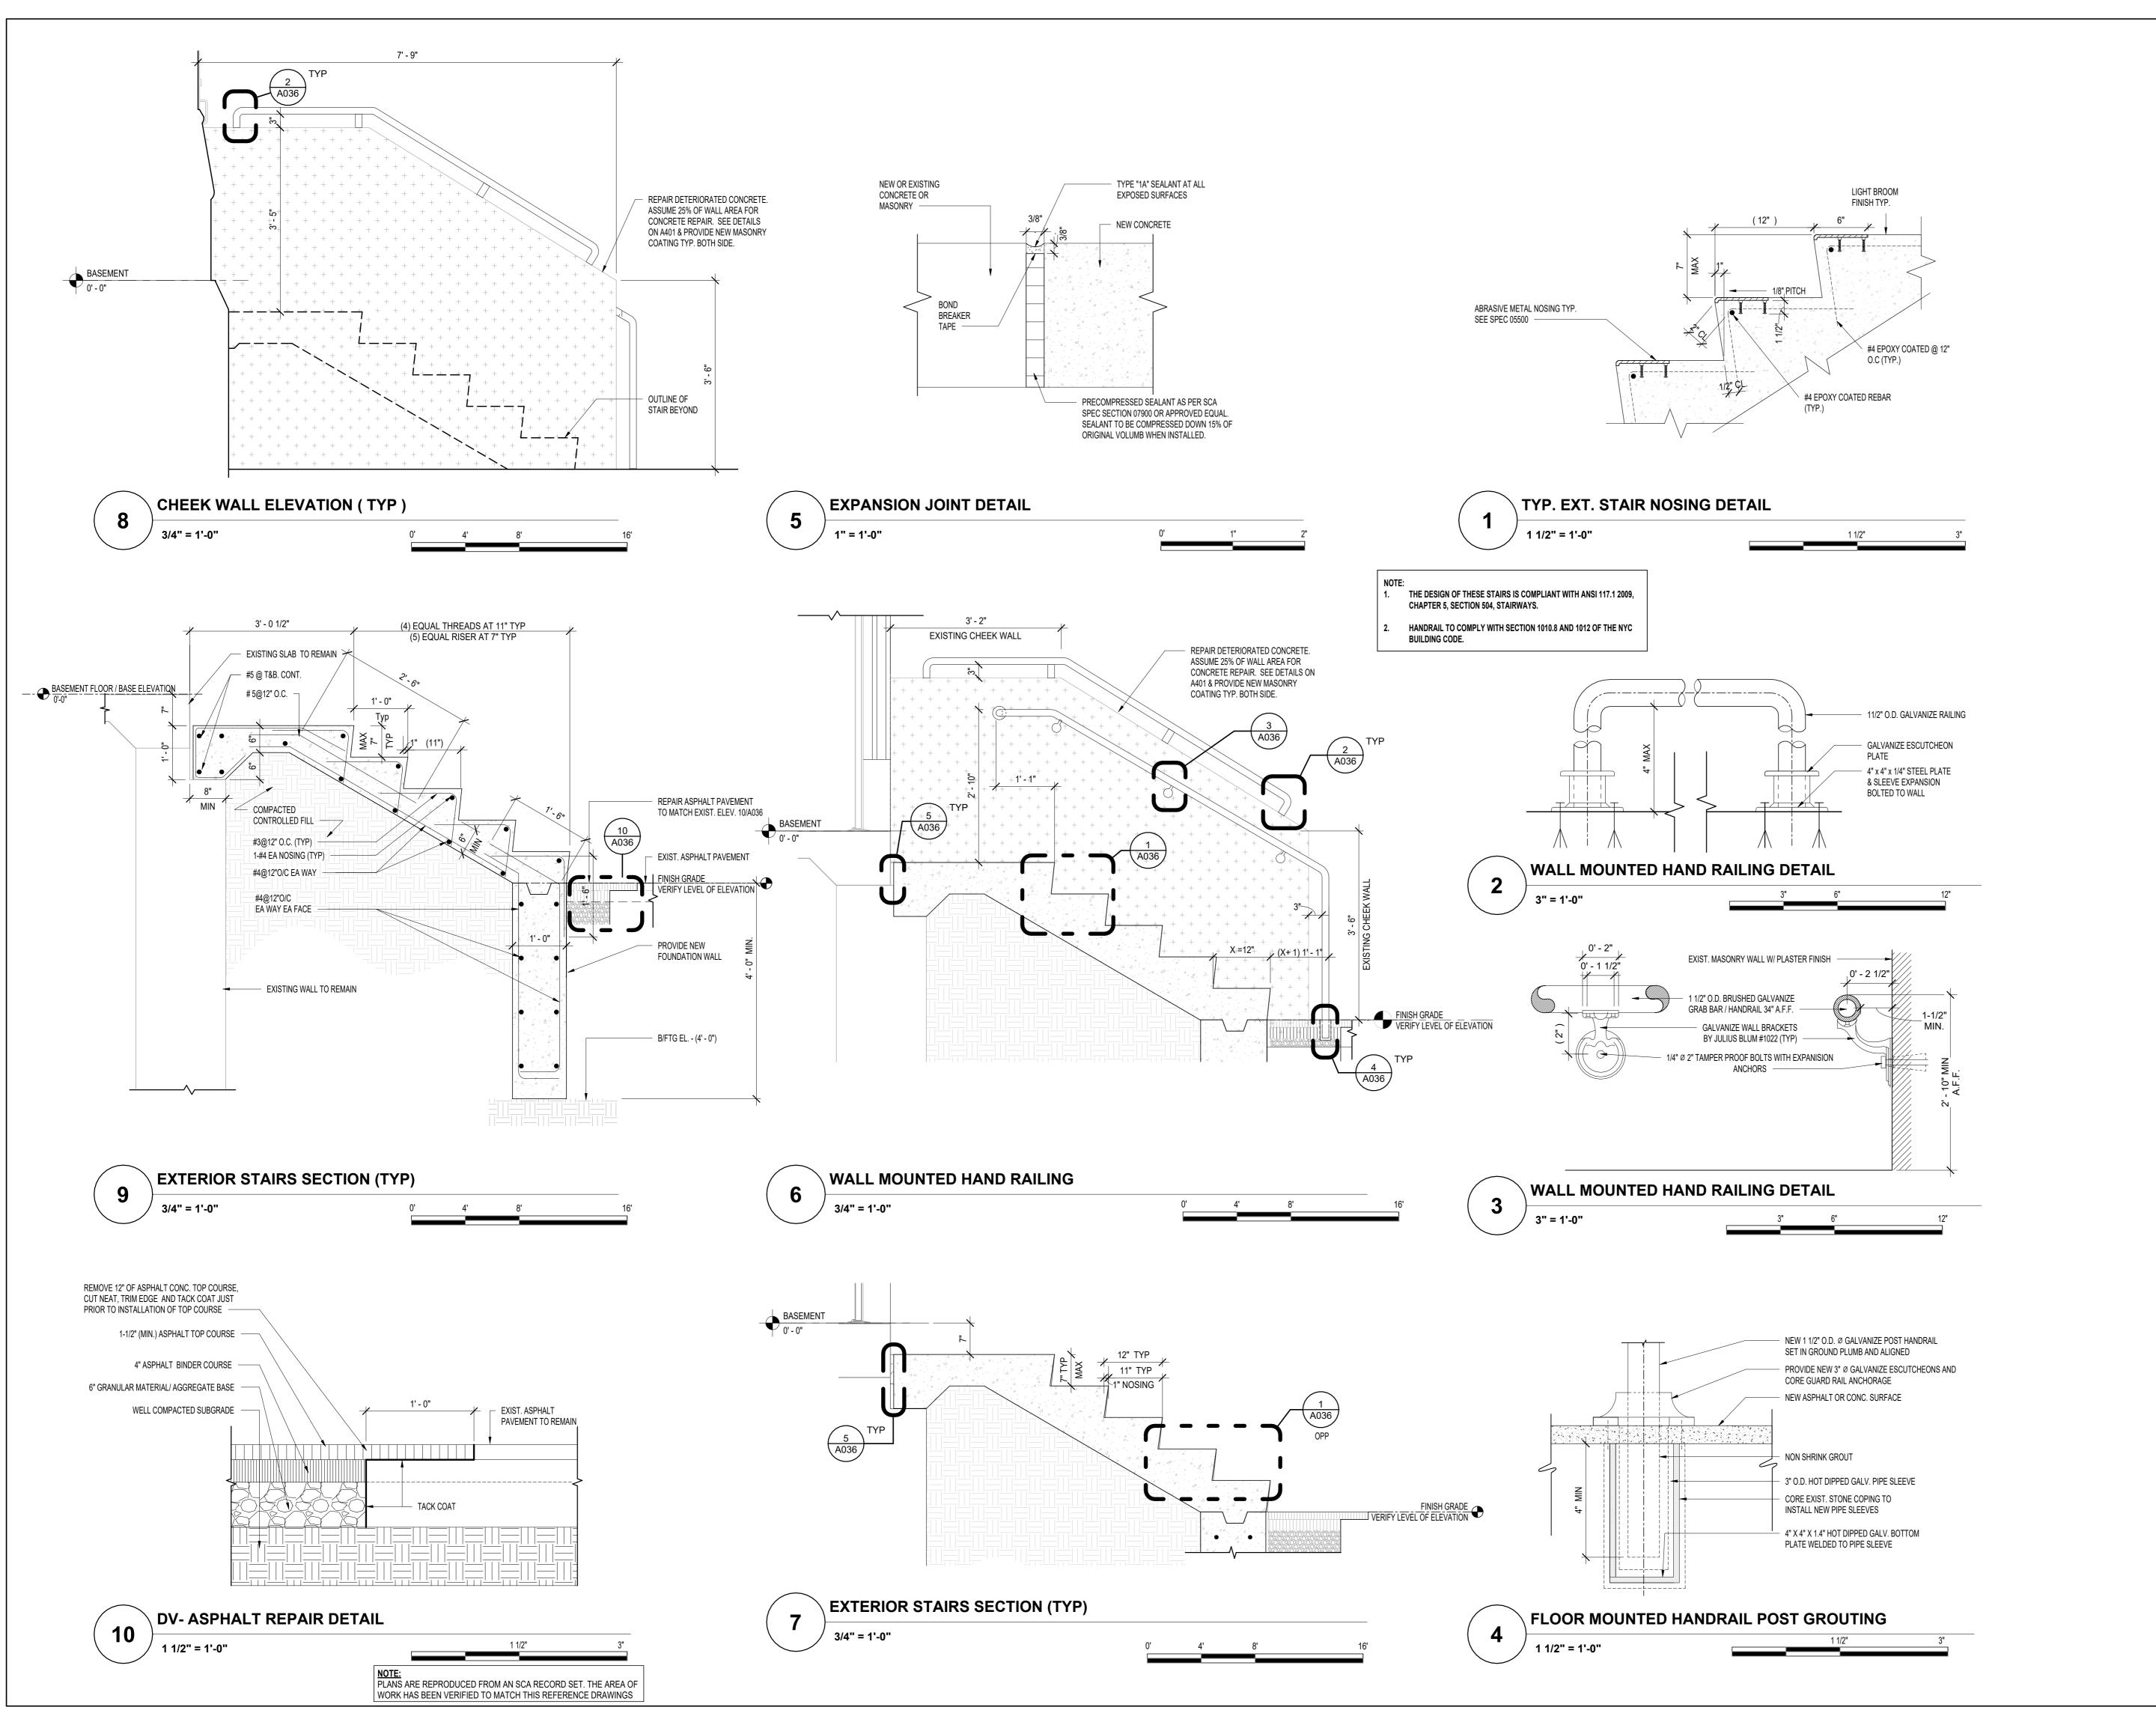

> Lorraine Grillo Peter McCree

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04/14/2023 Construction Documents Date Revisions Key Plan: PLAYGROUND I.S. 171K/ P.S. 7 K RIDGEWOOD AVENUE

ASHRAF ELIAS, P.E SCA Design Manager: DAVID SAMMEL, R.A Project Architect/Engineer: DAVID HUNSBERGER, R.A Discipline Lead: JUAN SANTOS / JUAN POLANCO Designer: JUAN SANTOS / ANA PINHEIRO DAVID SAMMEL, R.A Checked by: Facility Code: Design No or LLW No.: K171 D021557 04/14/2023

> I.S. 171 - BROOKLYN **EXTERIOR MASONRY**

528 Ridgewood Ave. Brooklyn New York 11208

Drawing Title:

Block #

SITE DETAILS


DOB # B00836762 - I1

A036.00

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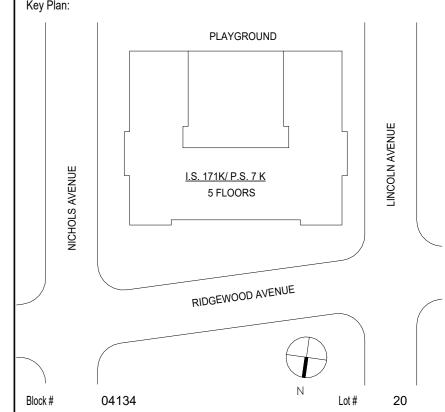
Lot#

Sheets in GC Work Type DOB Filing Set: 14 OF 38




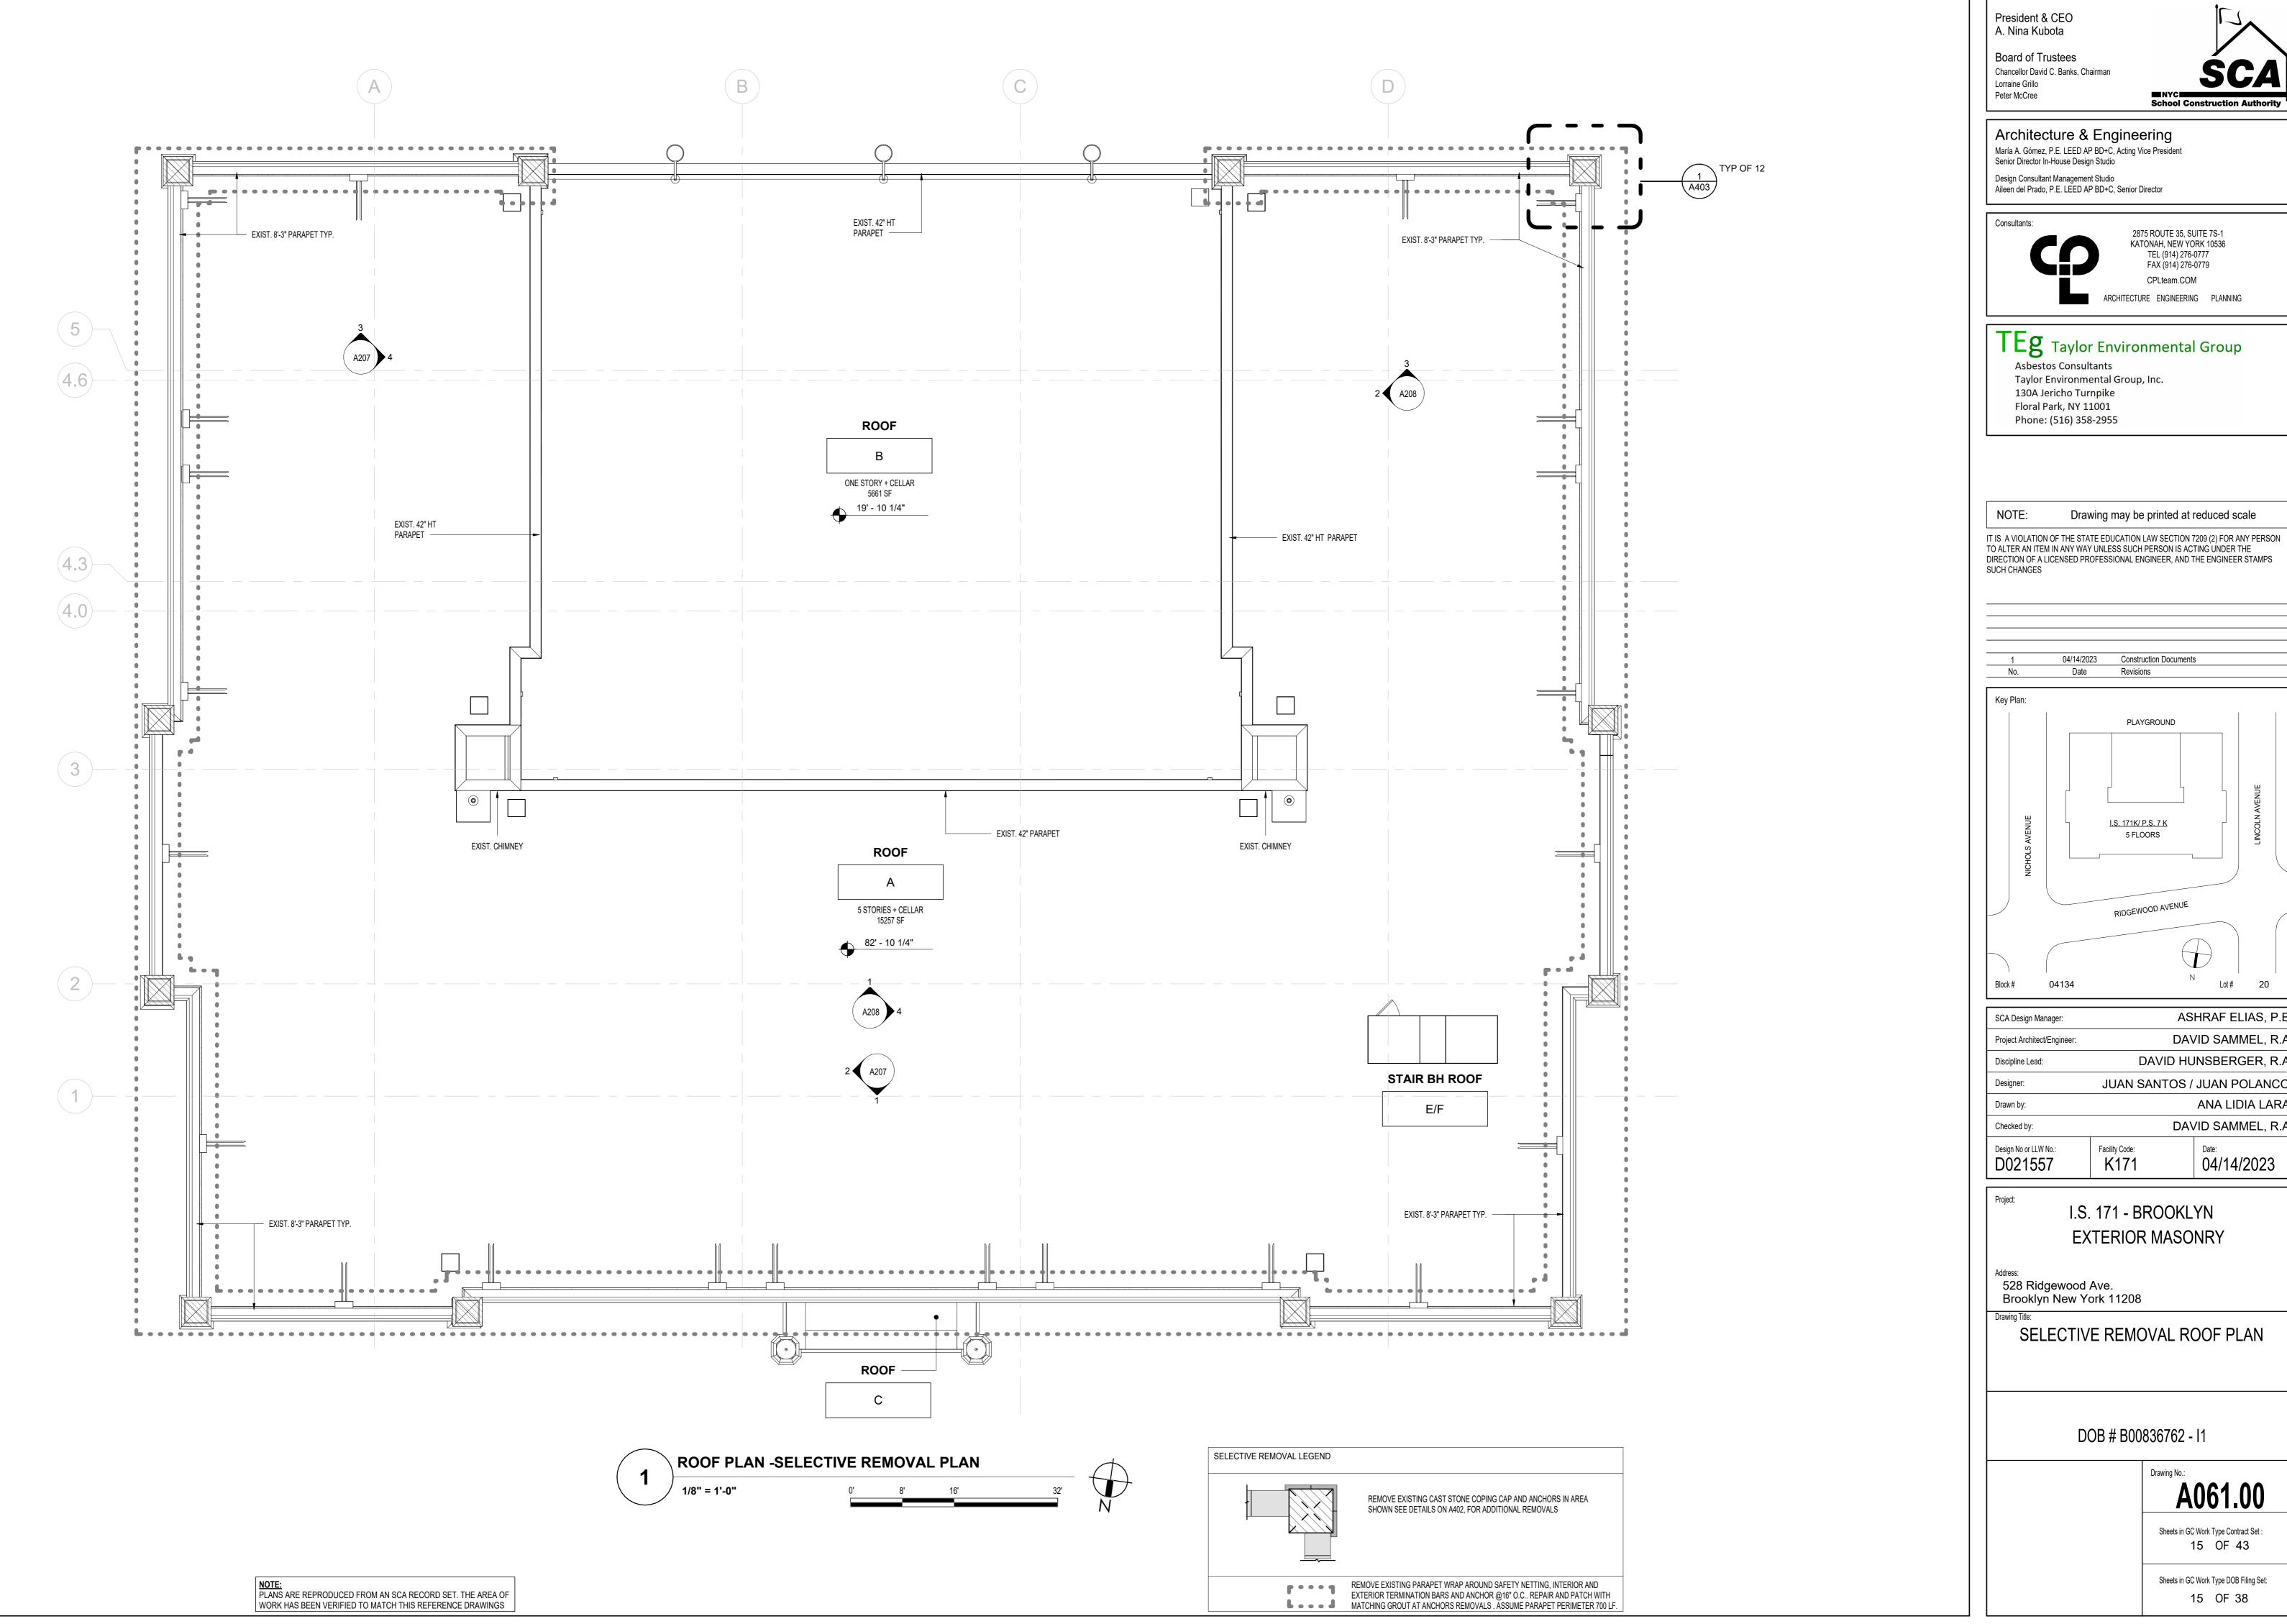



DIRECTION OF A LICENSED PROFESSIONAL ENGINEER, AND THE ENGINEER STAMPS



ASHRAF ELIAS, P.E DAVID SAMMEL, R.A DAVID HUNSBERGER, R.A JUAN SANTOS / JUAN POLANCO ANA LIDIA LARA DAVID SAMMEL, R.A

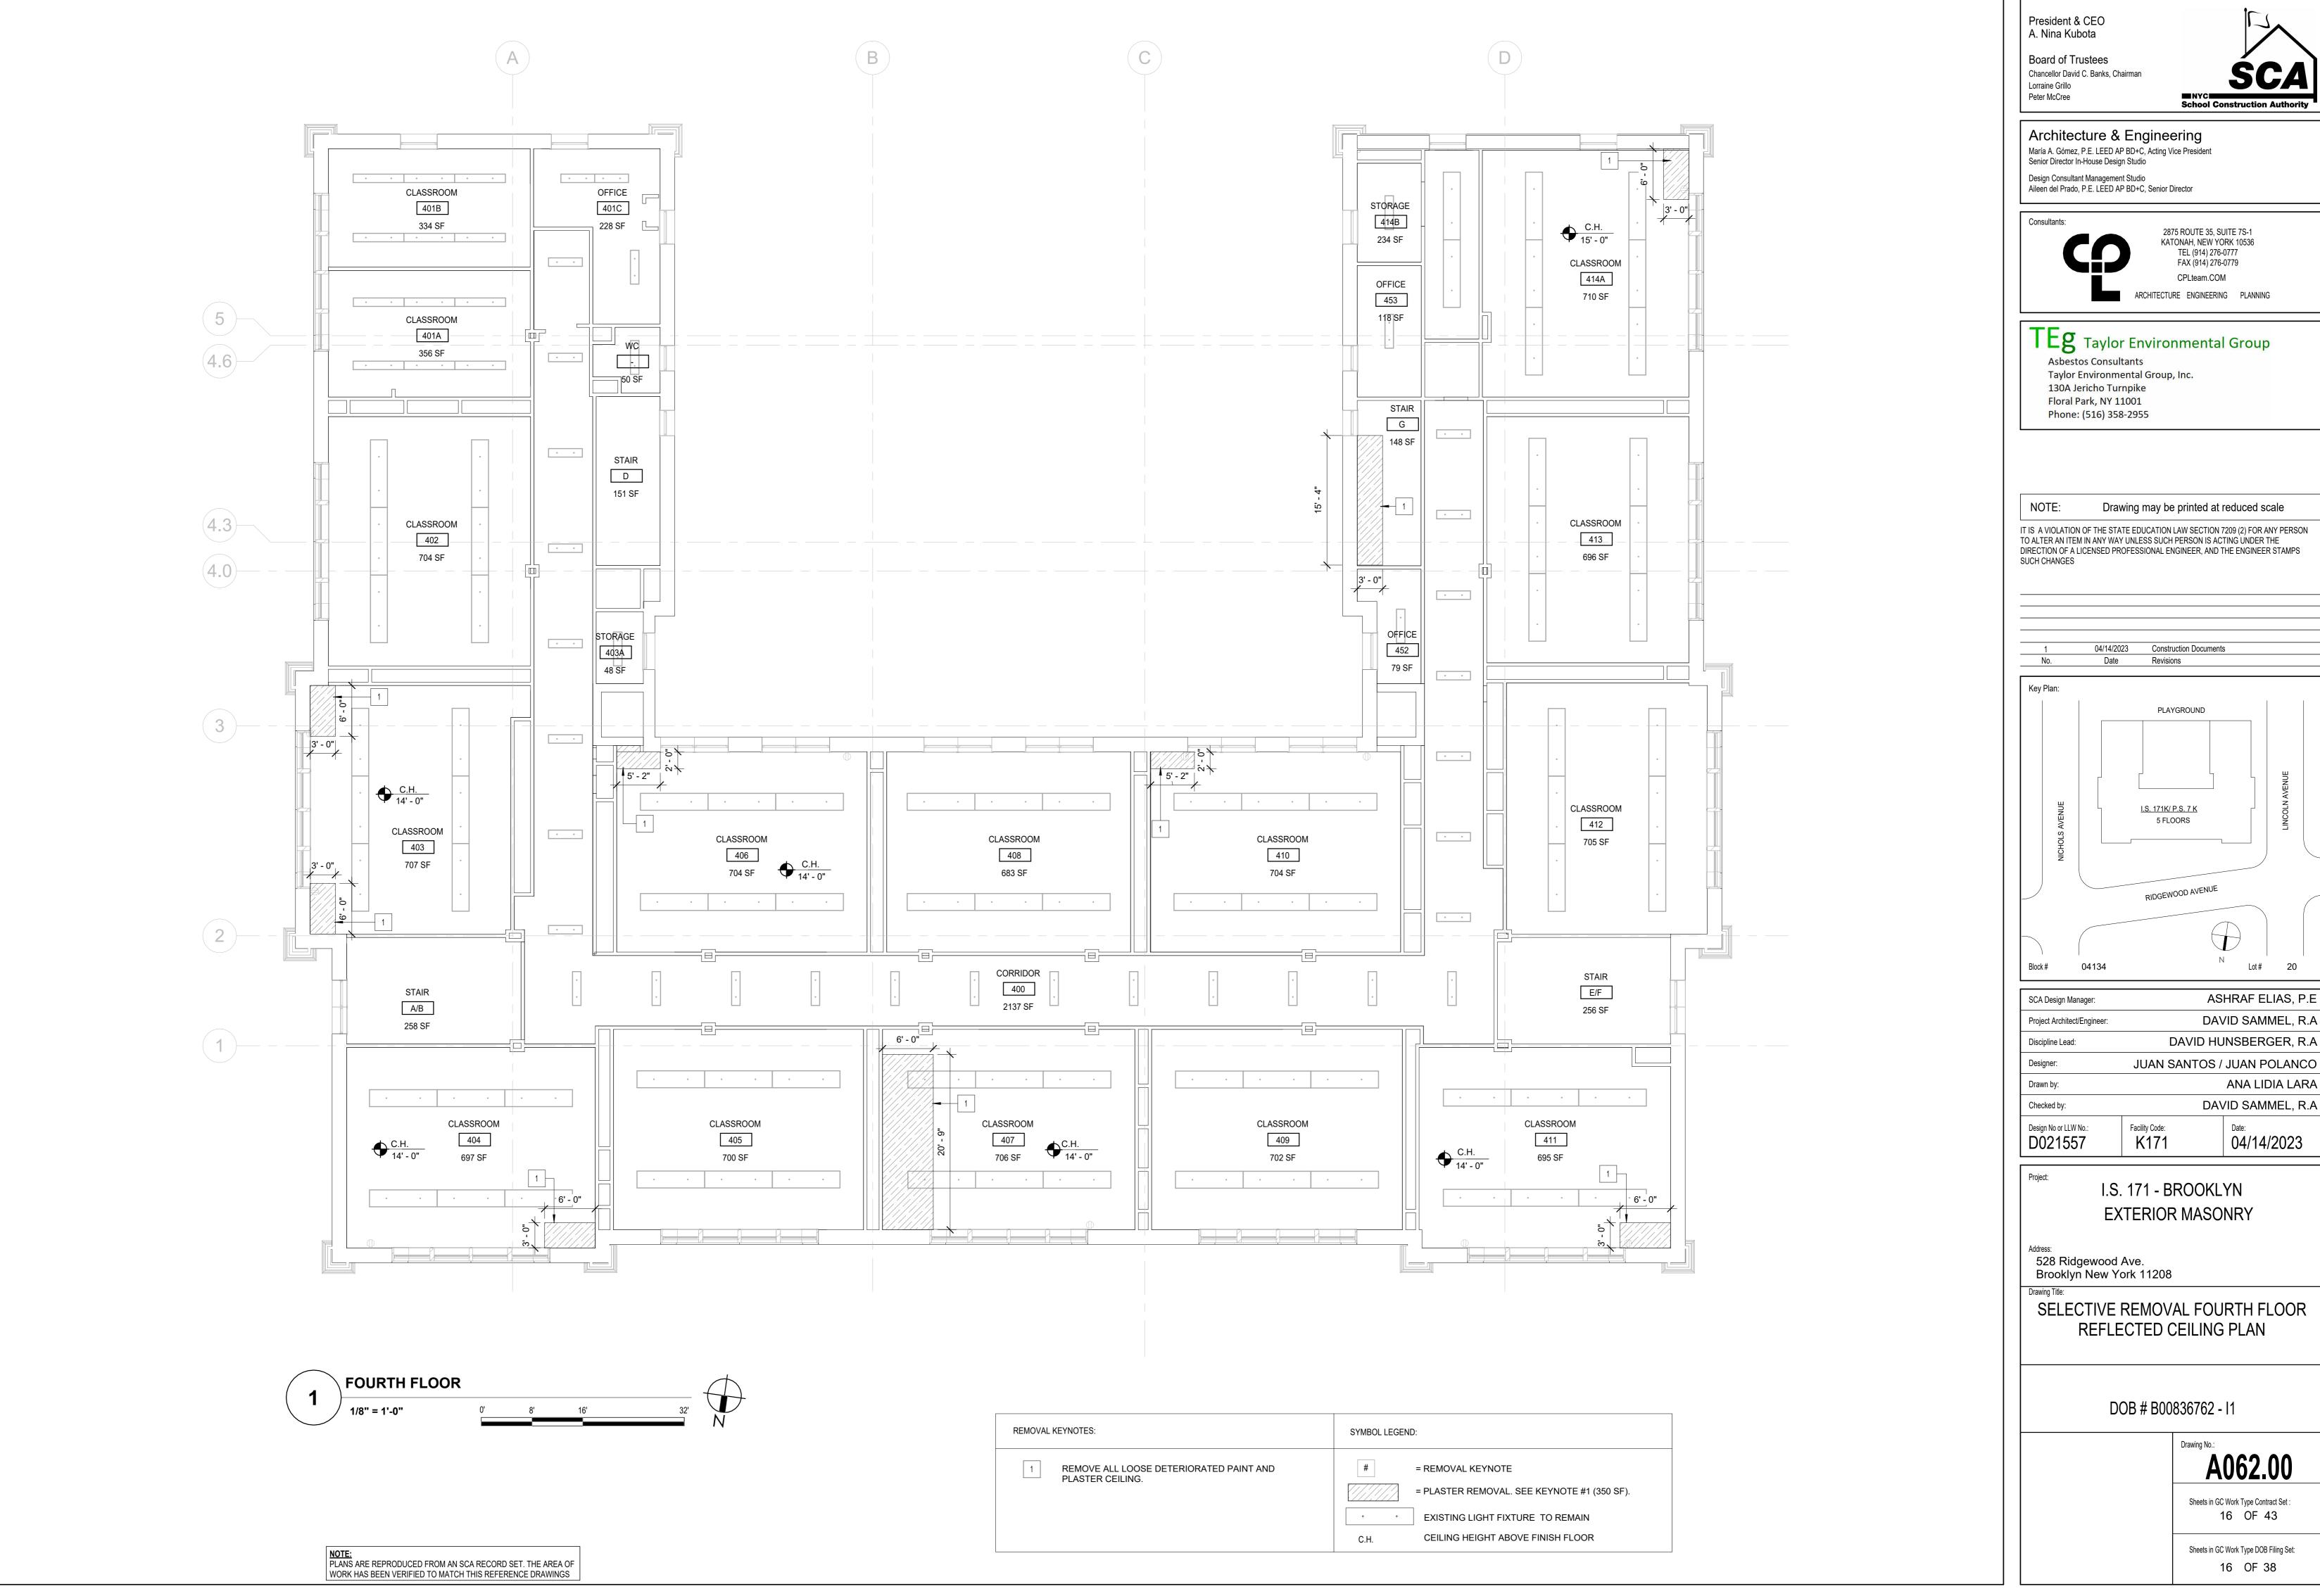

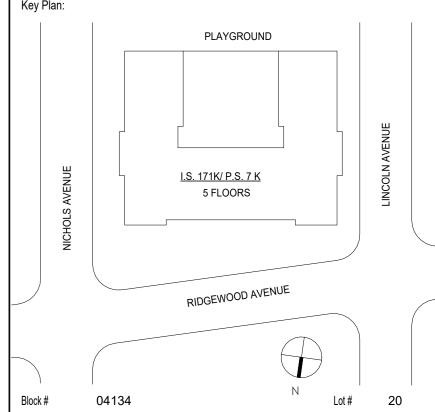

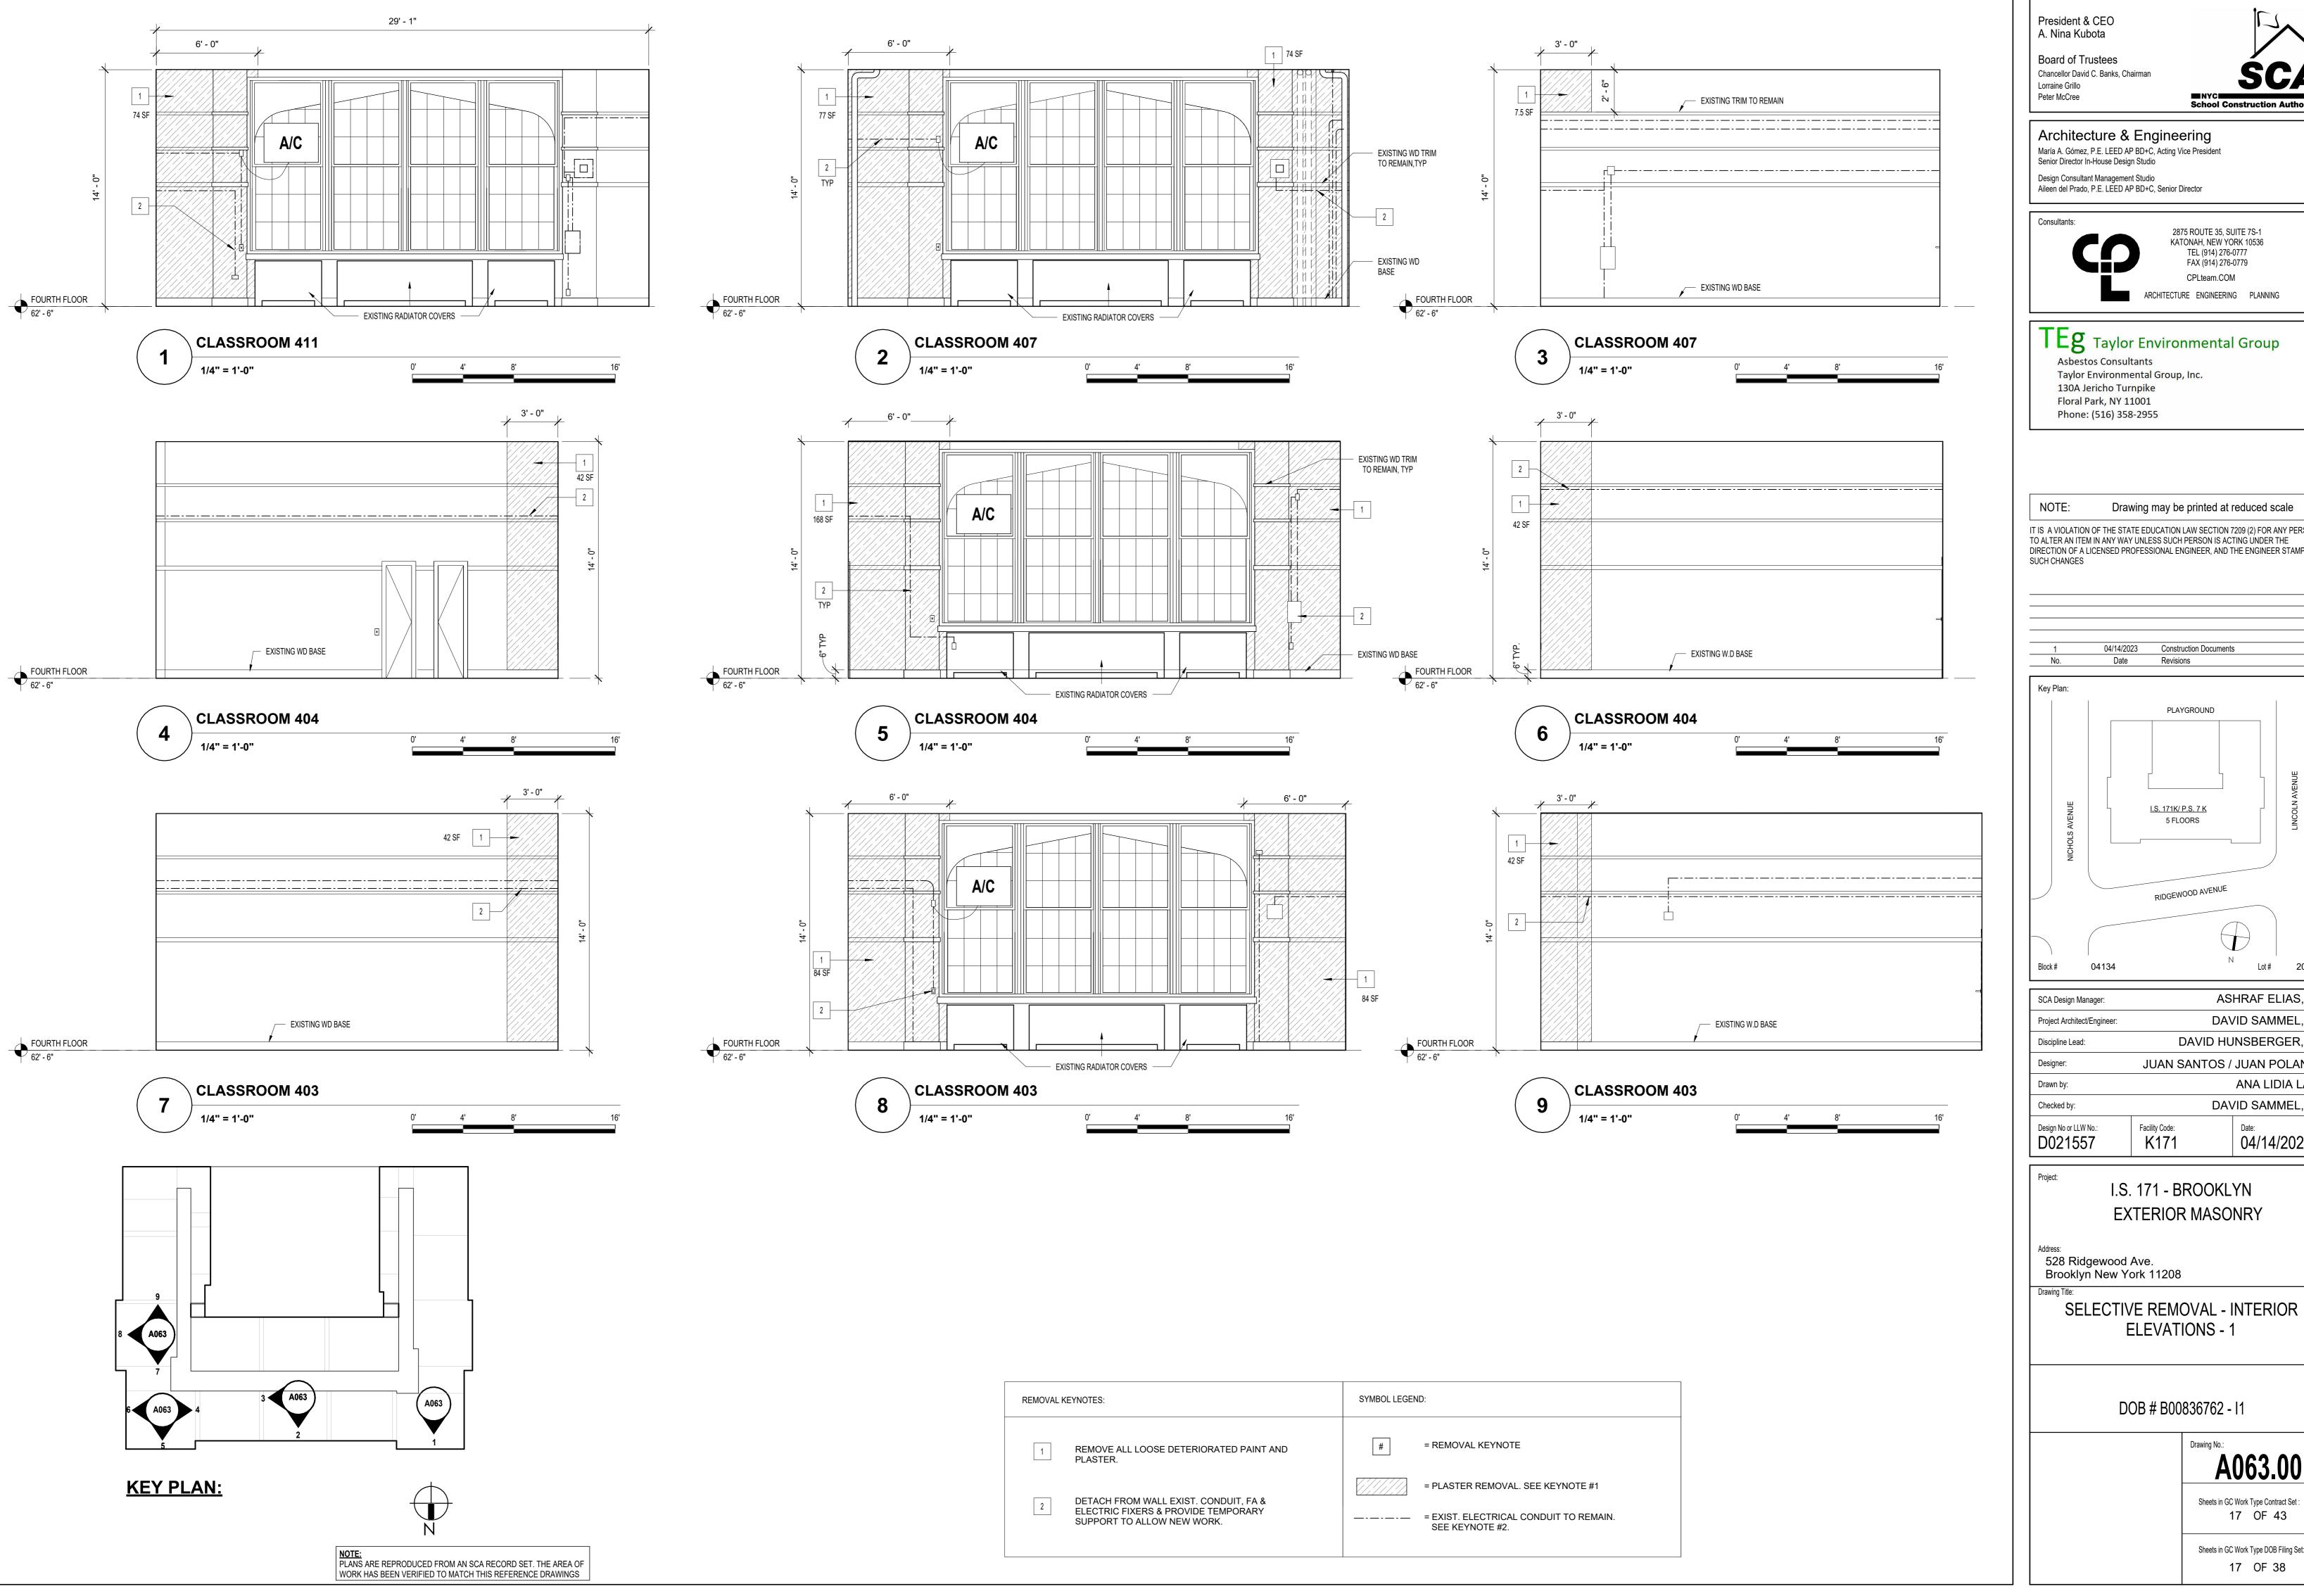




2875 ROUTE 35, SUITE 7S-1 KATONAH, NEW YORK 10536 TEL (914) 276-0777 FAX (914) 276-0779 CPLteam.COM ARCHITECTURE ENGINEERING PLANNING

TEg Taylor Environmental Group Taylor Environmental Group, Inc.

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04/14/2023 Construction Documents Revisions



ASHRAF ELIAS, P.E DAVID SAMMEL, R.A DAVID HUNSBERGER, R.A JUAN SANTOS / JUAN POLANCO ANA LIDIA LARA DAVID SAMMEL, R.A 04/14/2023

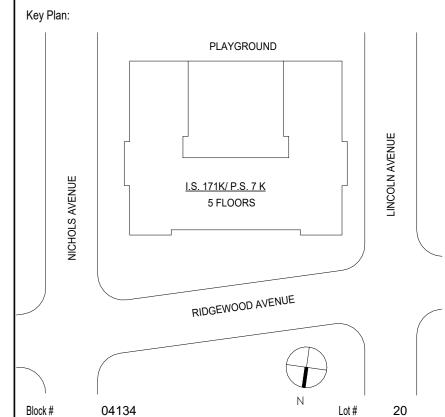I.S. 171 - BROOKLYN

**ELEVATIONS - 1** 


DOB # B00836762 - I1

A063.00

Sheets in GC Work Type Contract Set : 17 OF 43

Sheets in GC Work Type DOB Filing Set:

17 OF 38

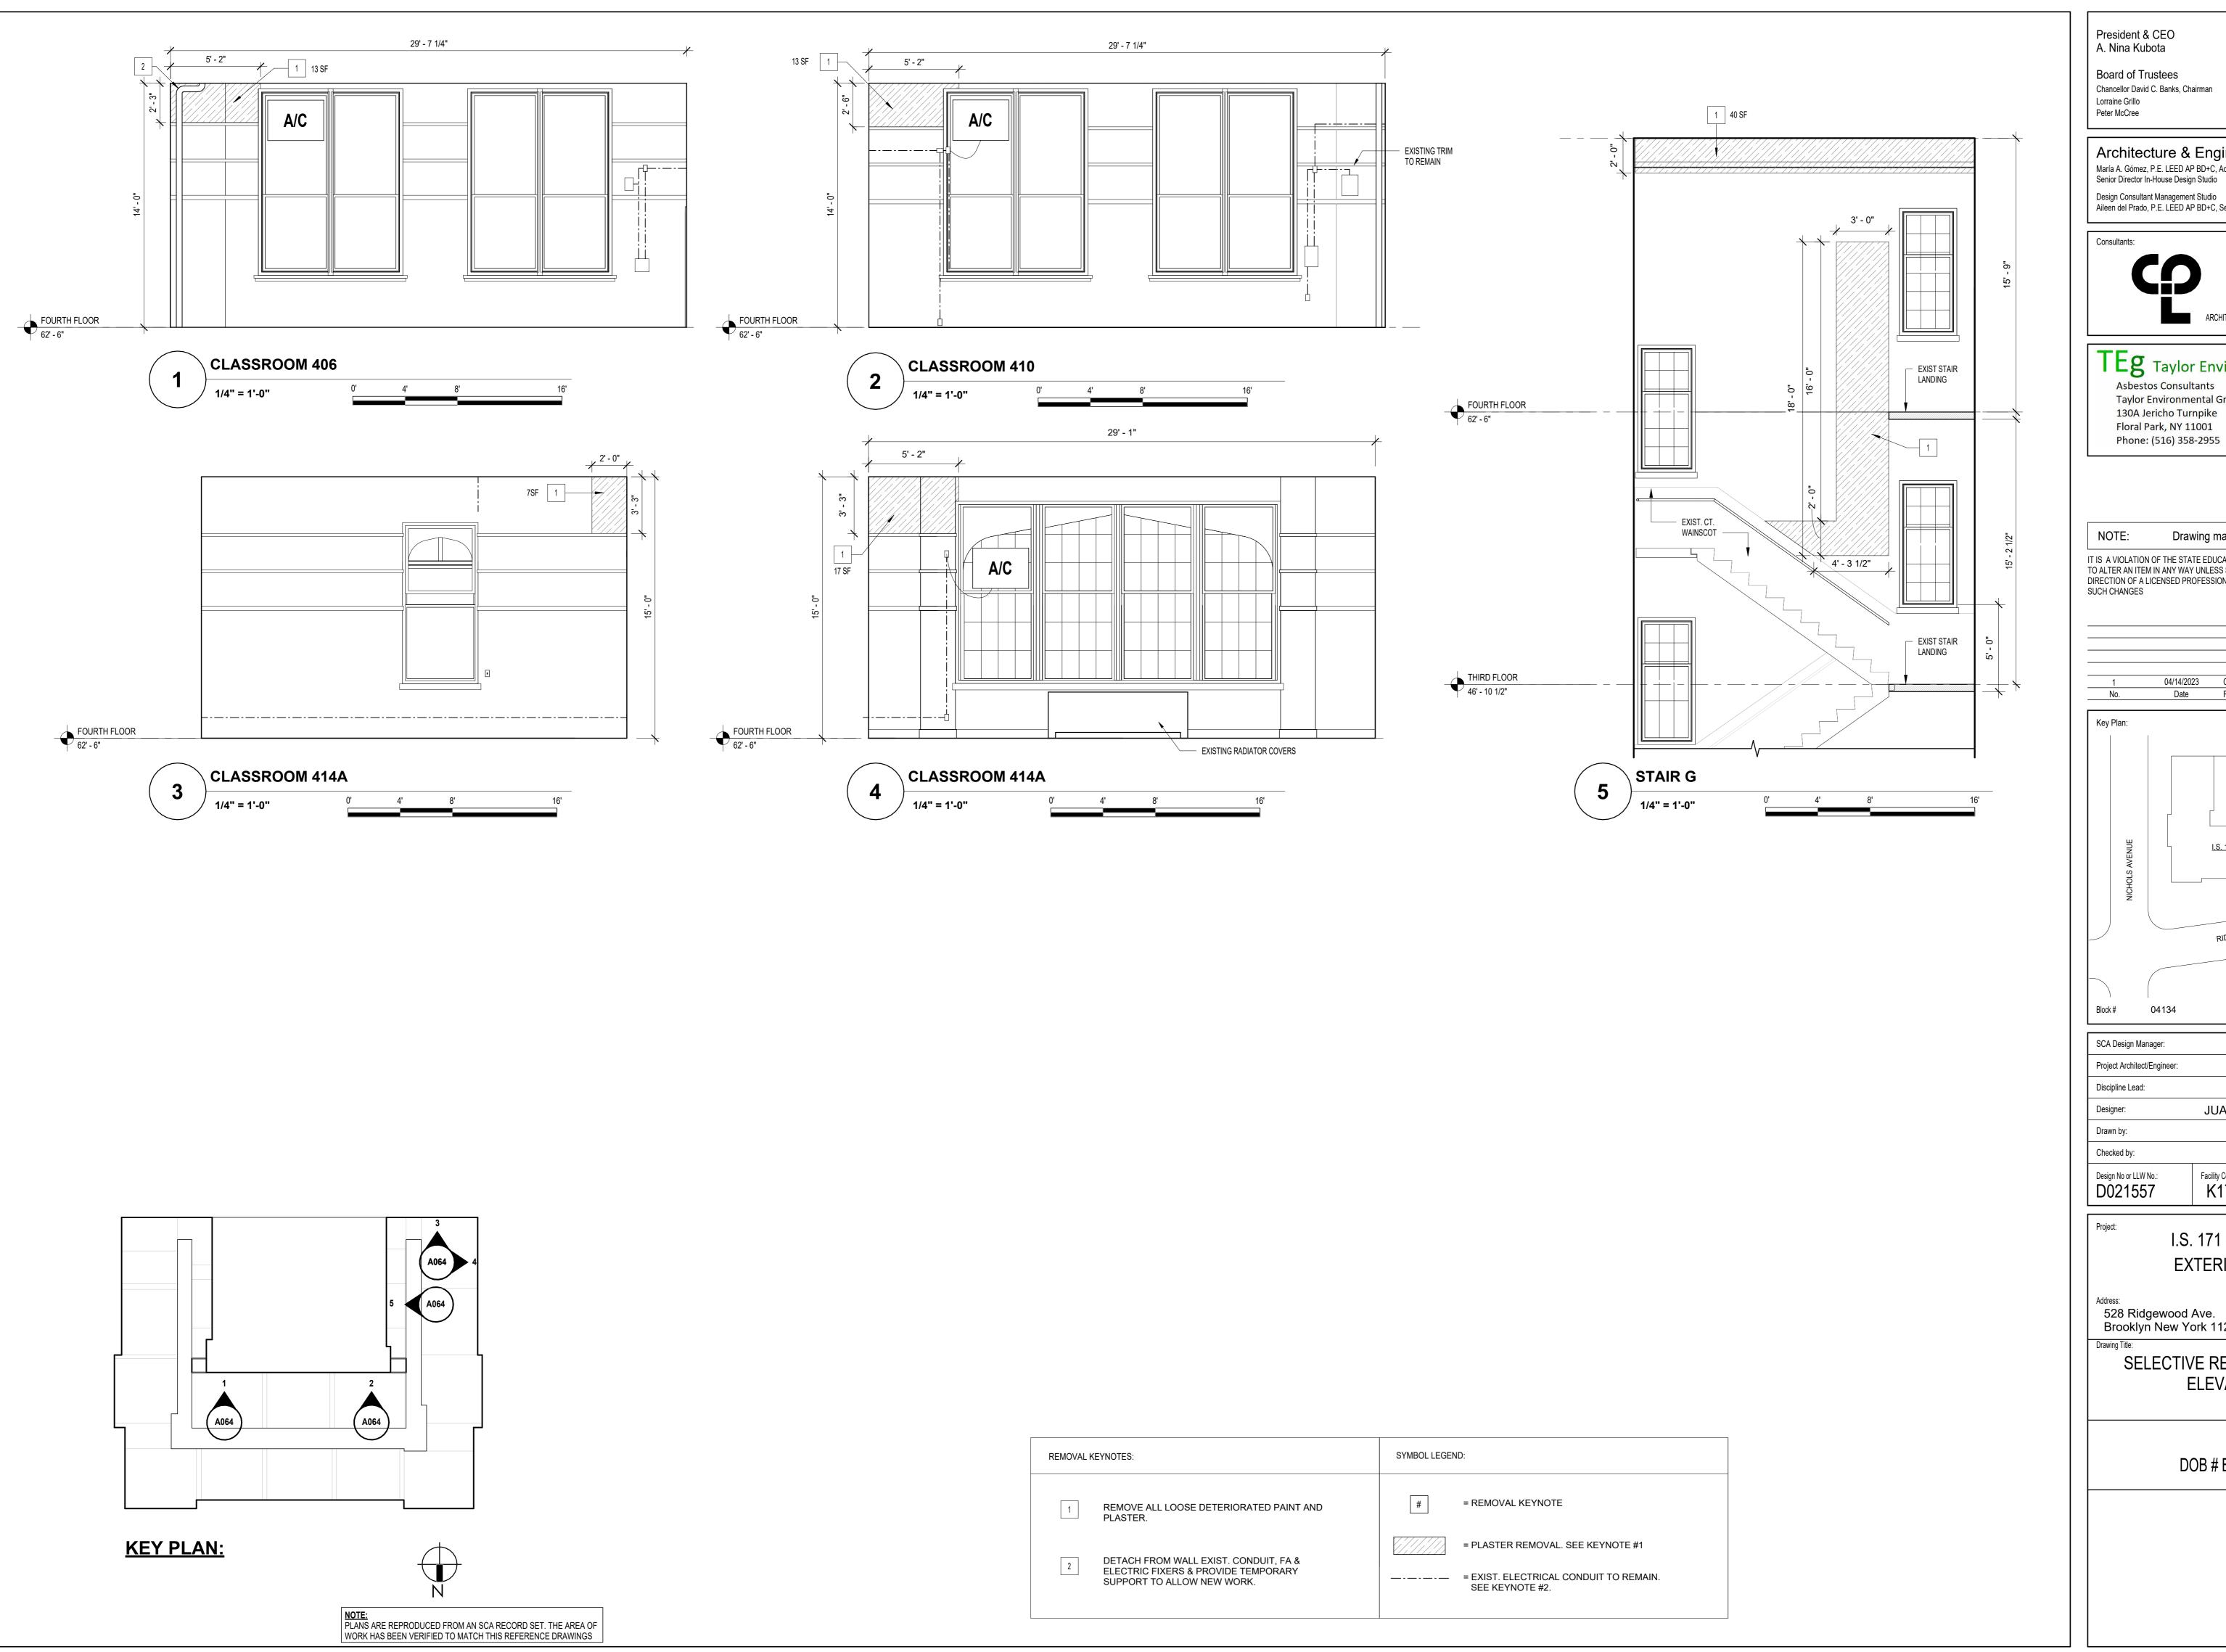

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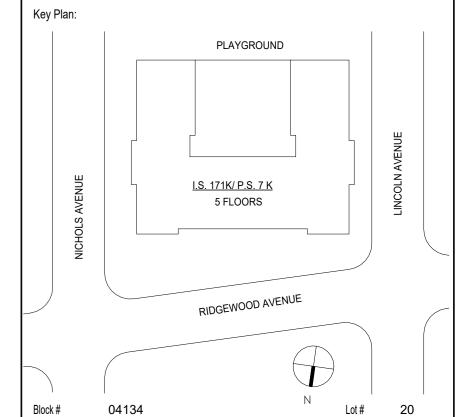
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04/14/2023 Construction Documents Date Revisions



ASHRAF ELIAS, P.E SCA Design Manager: DAVID SAMMEL, R.A Project Architect/Engineer: DAVID HUNSBERGER, R.A Discipline Lead: JUAN SANTOS / JUAN POLANCO Designer: ANA LIDIA LARA DAVID SAMMEL, R.A Checked by: Facility Code: Design No or LLW No.: D021557 K171 04/14/2023

I.S. 171 - BROOKLYN **EXTERIOR MASONRY** 

528 Ridgewood Ave. Brooklyn New York 11208


SELECTIVE REMOVAL - INTERIOR **ELEVATIONS - 2** 

DOB # B00836762 - I1

A064.00

Sheets in GC Work Type Contract Set : 18 OF 43

Sheets in GC Work Type DOB Filing Set: 18 OF 38

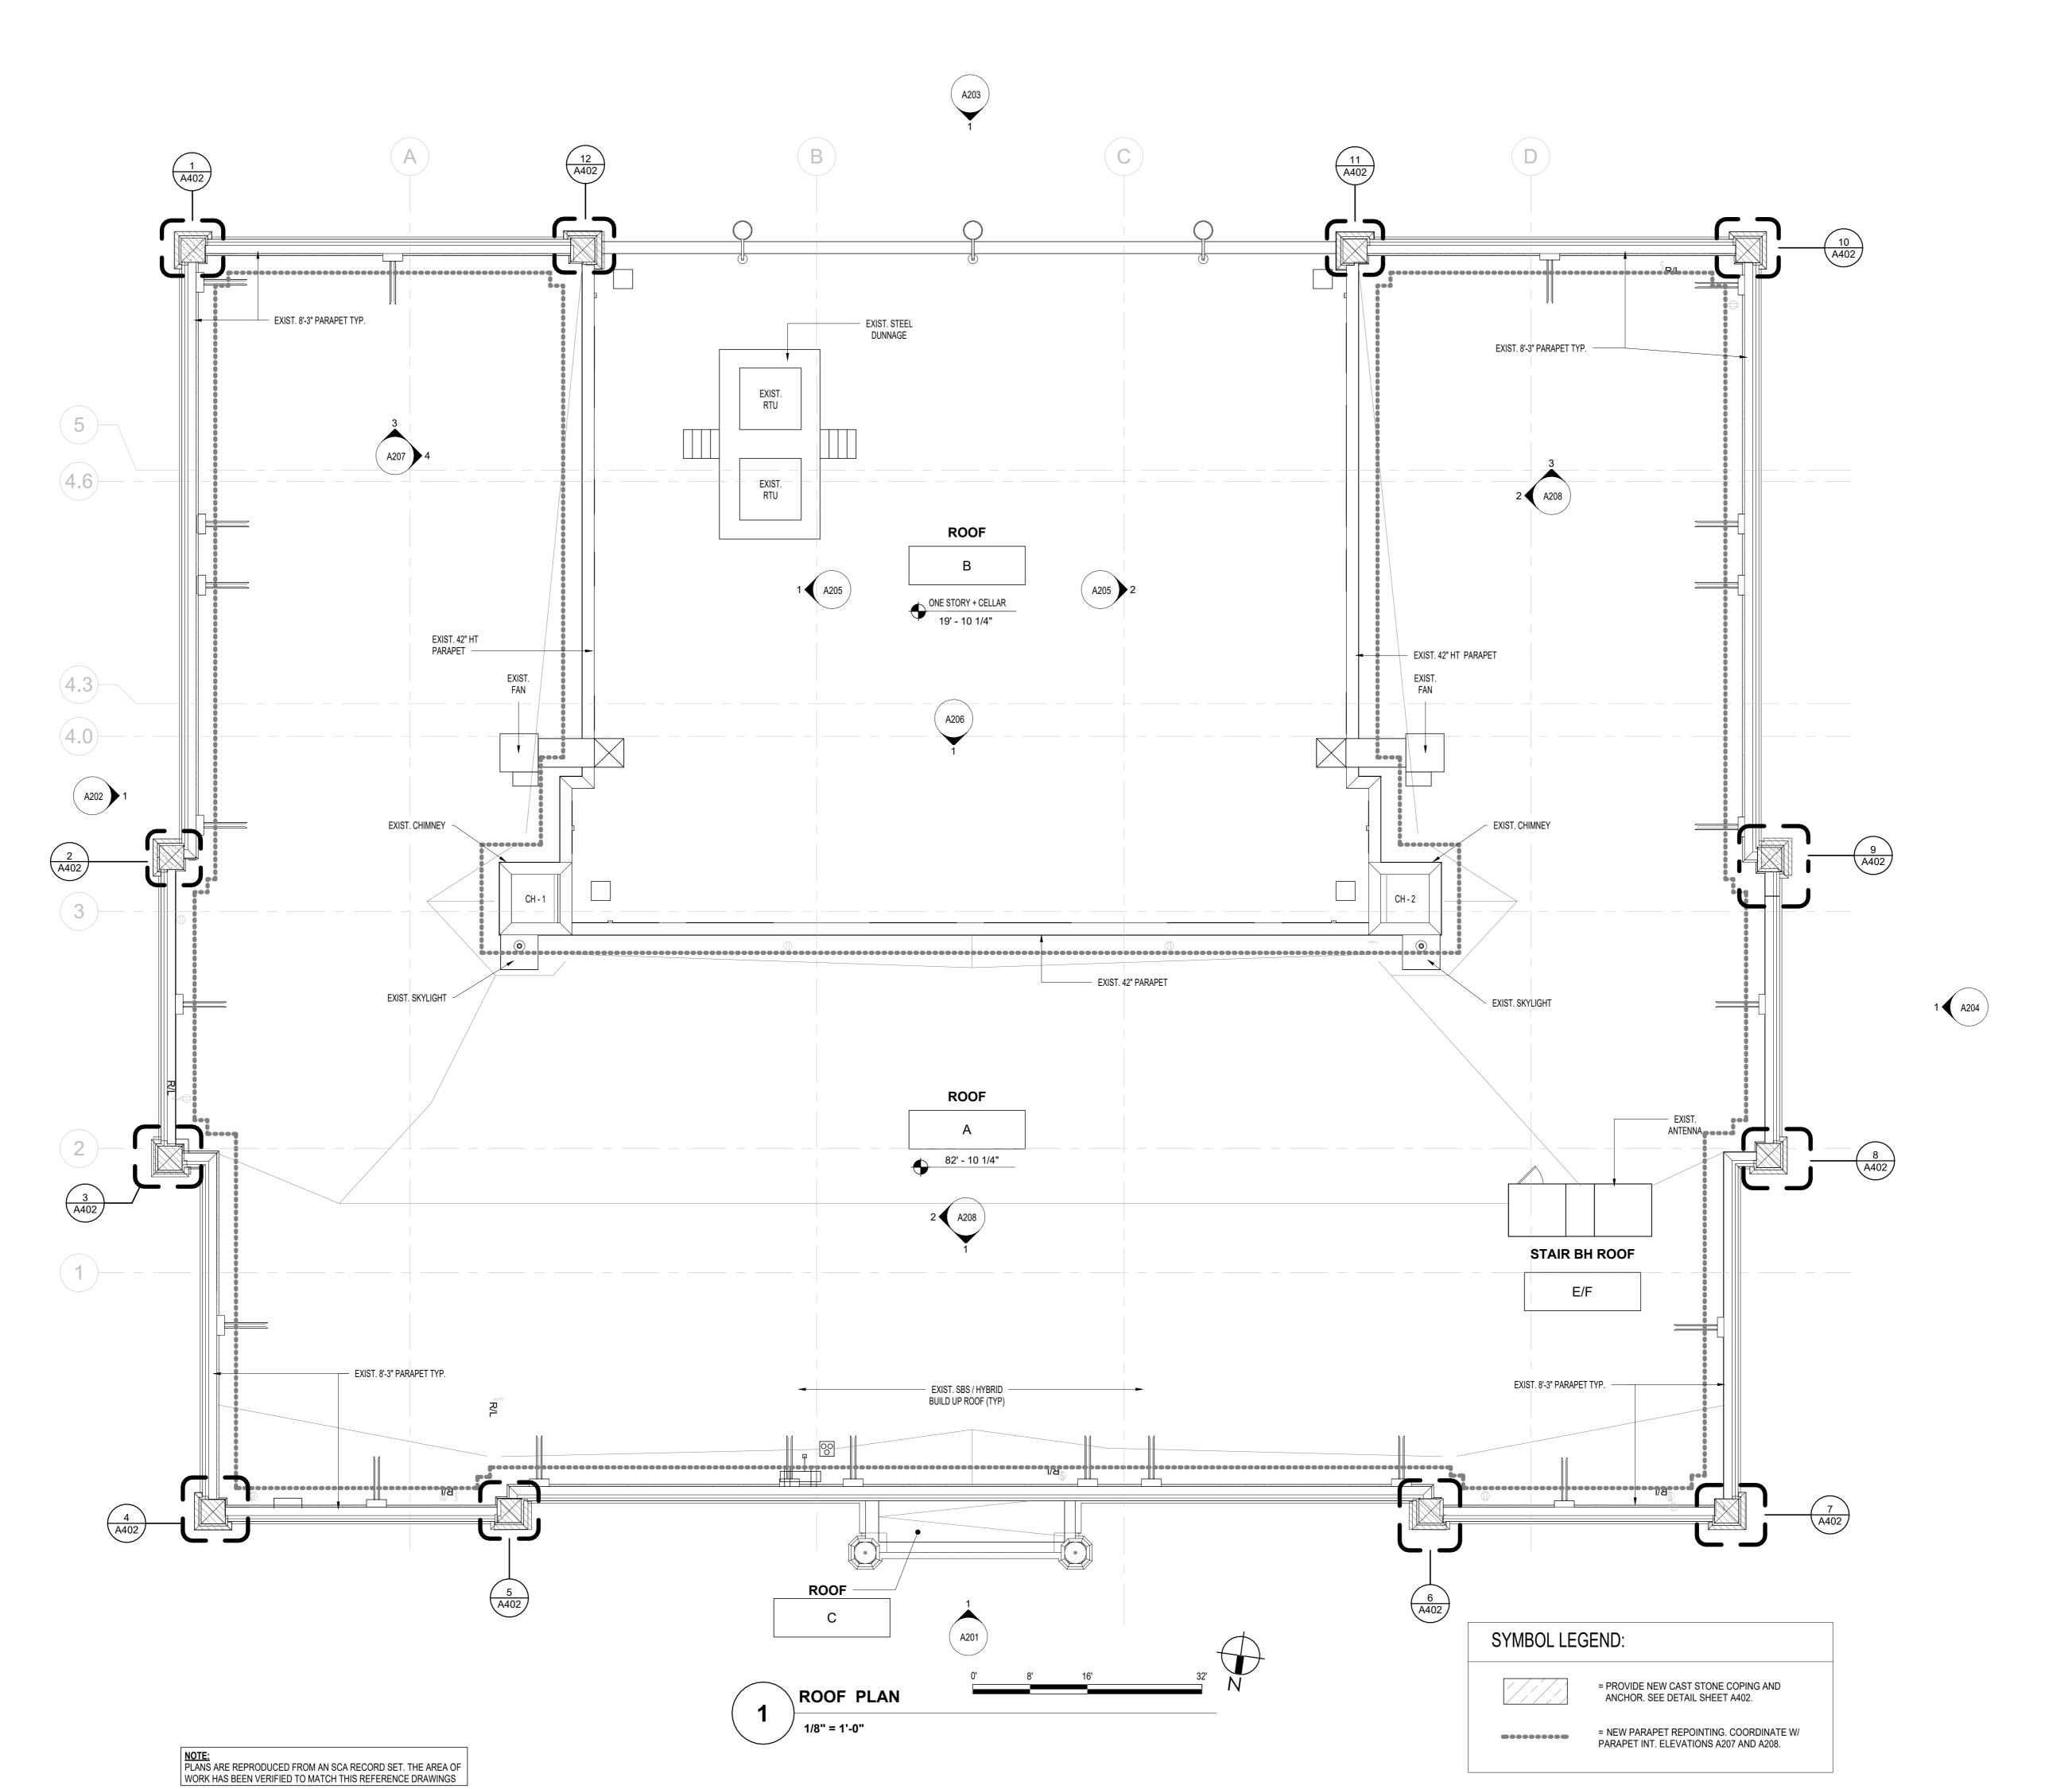

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Design Consultant Management Studio

Design Consultant Management Studio
Aileen del Prado, P.E. LEED AP BD+C, Senior Director

sultants:


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KATONAH, NEW YORK 10536
TEL (914) 276-0777
FAX (914) 276-0779
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ARCHITECTURE ENGINEERING PLANNING

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Asbestos Consultants
Taylor Environmental Group, Inc.
130A Jericho Turnpike
Floral Park, NY 11001
Phone: (516) 358-2955

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	03/17/2023	100% Q.C. Submission
	03/03/2023	BCC Submission
	02/27/2023	IEH Submission
1	02/01/2023	50% Q.C. Submission
No.	Date	Revisions



SCA Design Manager:	ASHRAF ELIAS, P.E	
Project Architect/Engineer:	DAVID SAMMEL, R.A	
Discipline Lead:	DAVID HUNSBERGER, R.A	
Designer:	JUAN SANTOS / JUAN POLANCO	
Drawn by:	ANA LIDIA LARA	
Checked by:	DAVID SAMMEL, R.A	
Design No or LLW No.: D021557	Facility Code:	Date: 04/14/2023

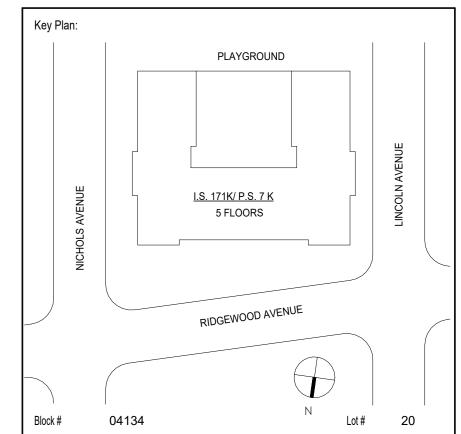I.S. 171 - BROOKLYN EXTERIOR MASONRY

Address: 528 Ridgewood Ave. Brooklyn New York 11208

Drawing Title:


NEW WORK - ROOF PLAN

DOB # B00836762 - I1


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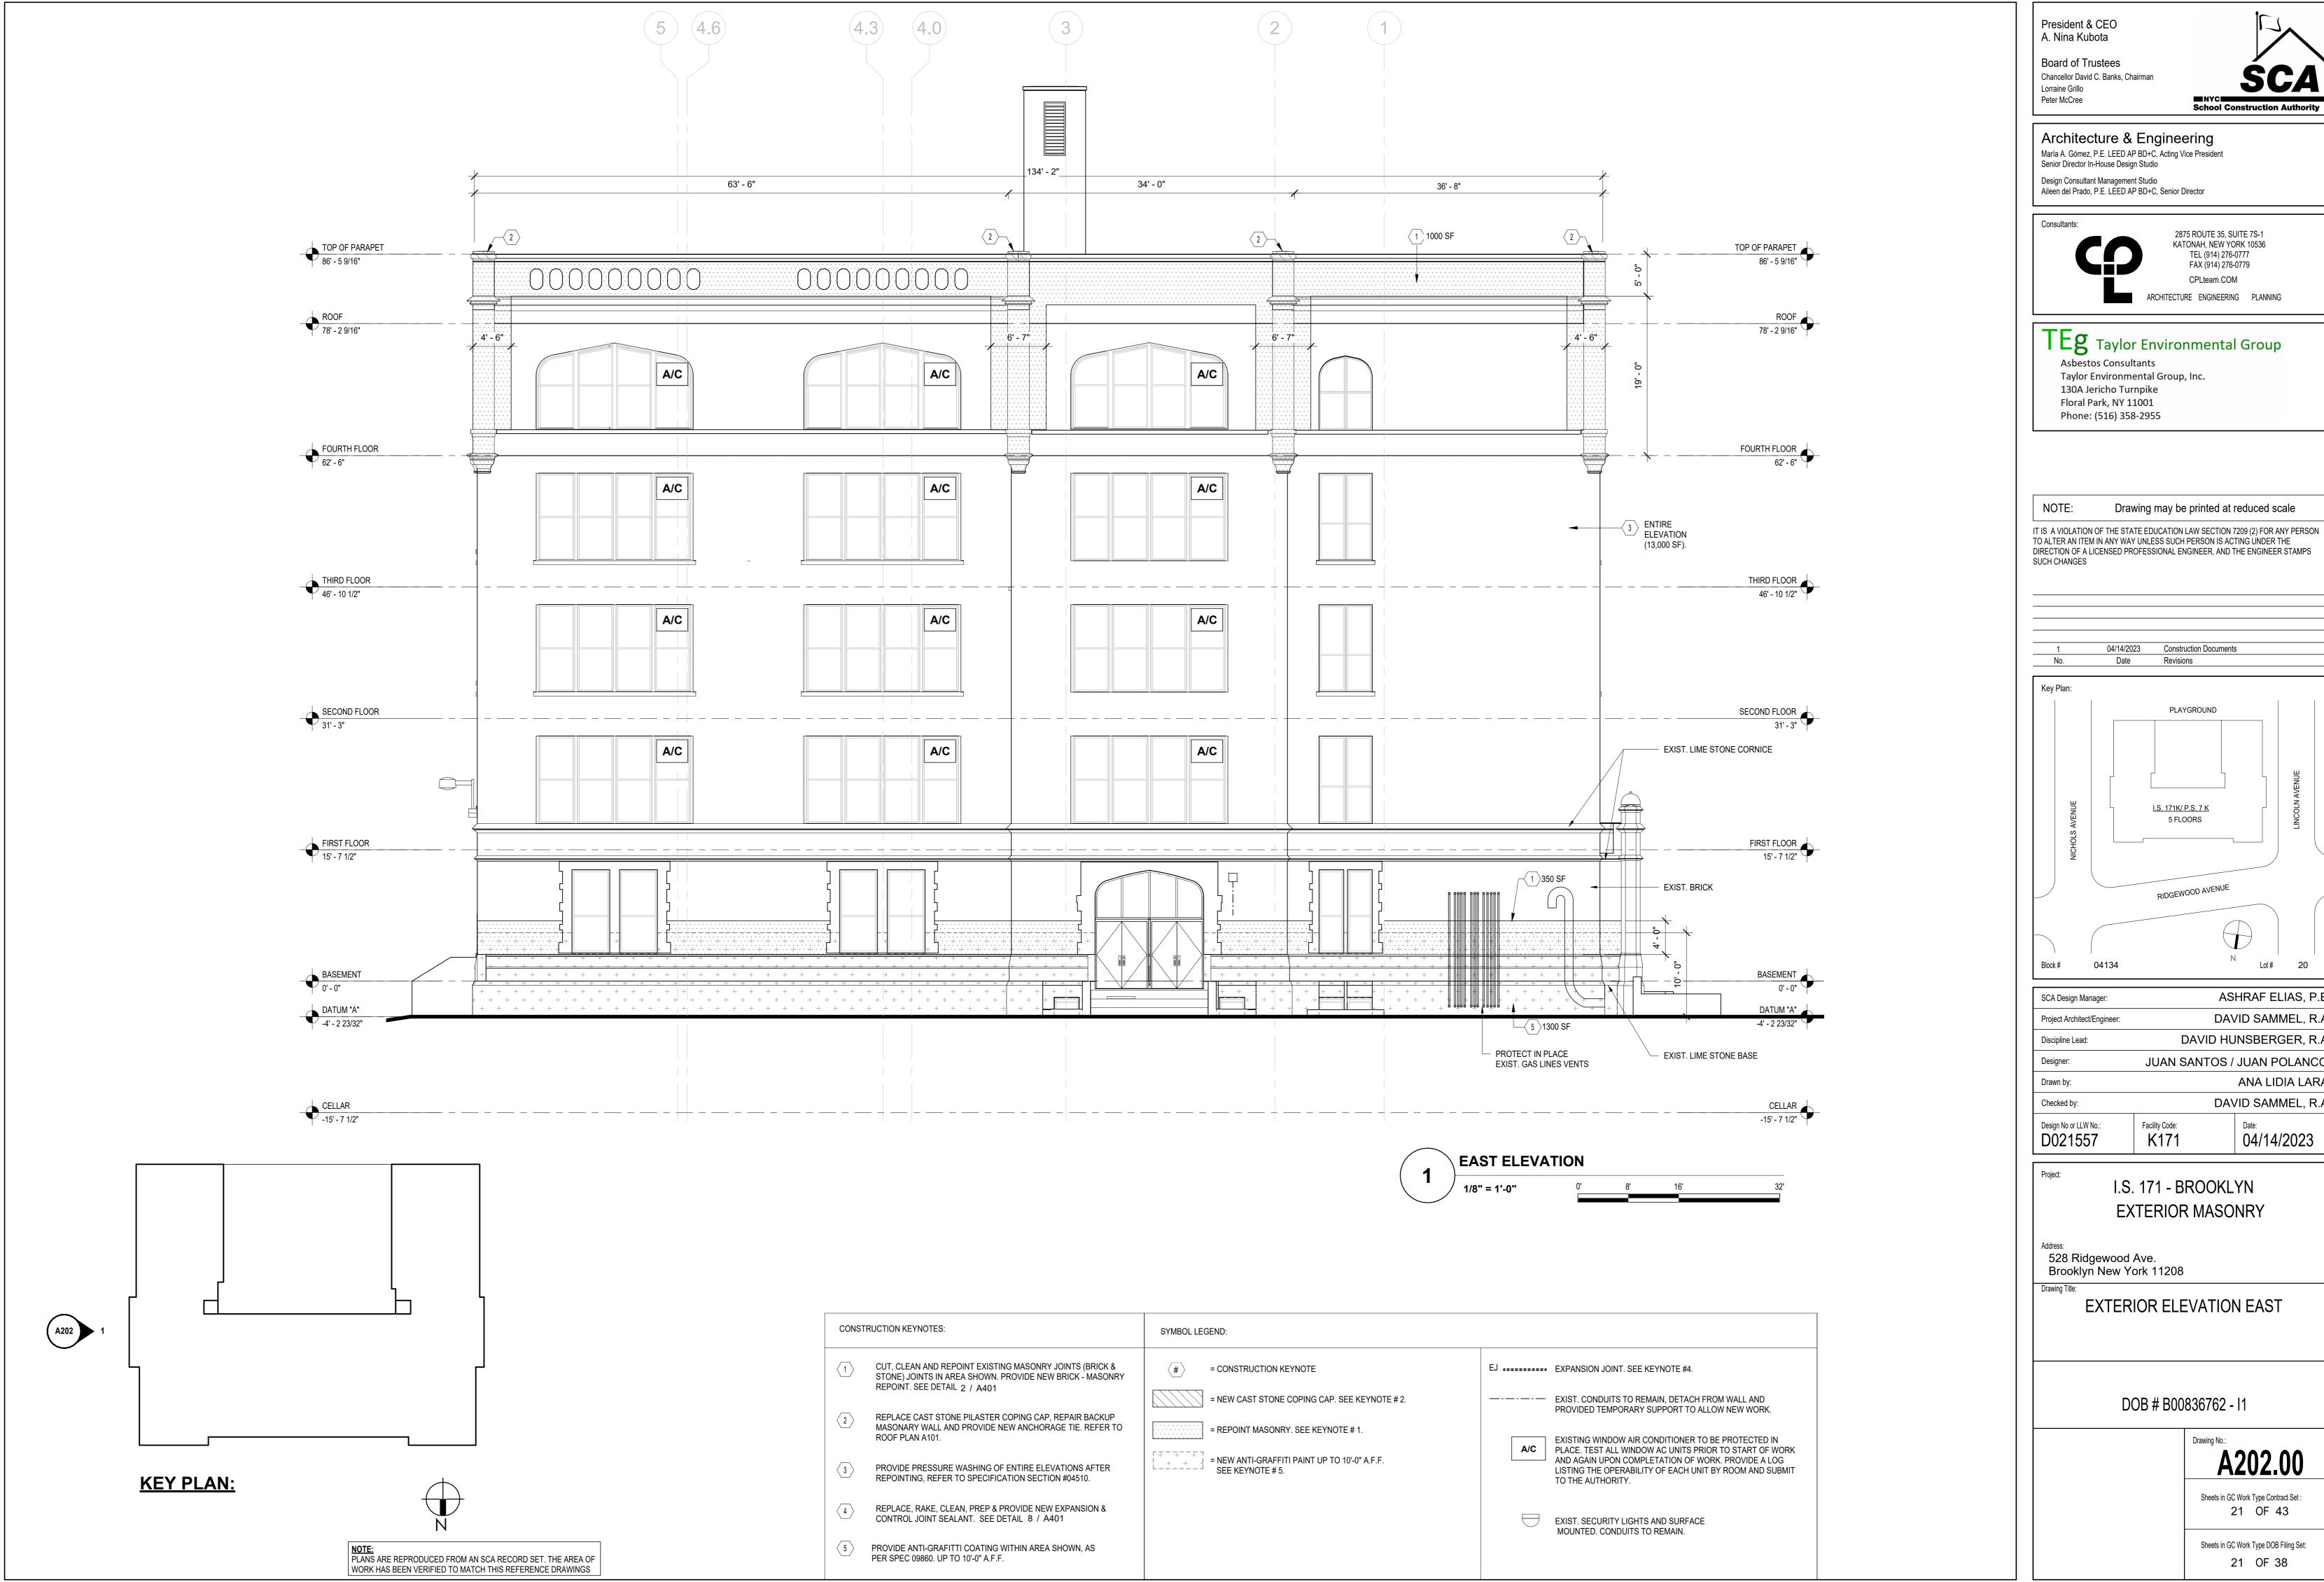
Sheets in GC Work Type Contract Set : 19 OF 43

Sheets in GC Work Type DOB Filing Set: 19 OF 38




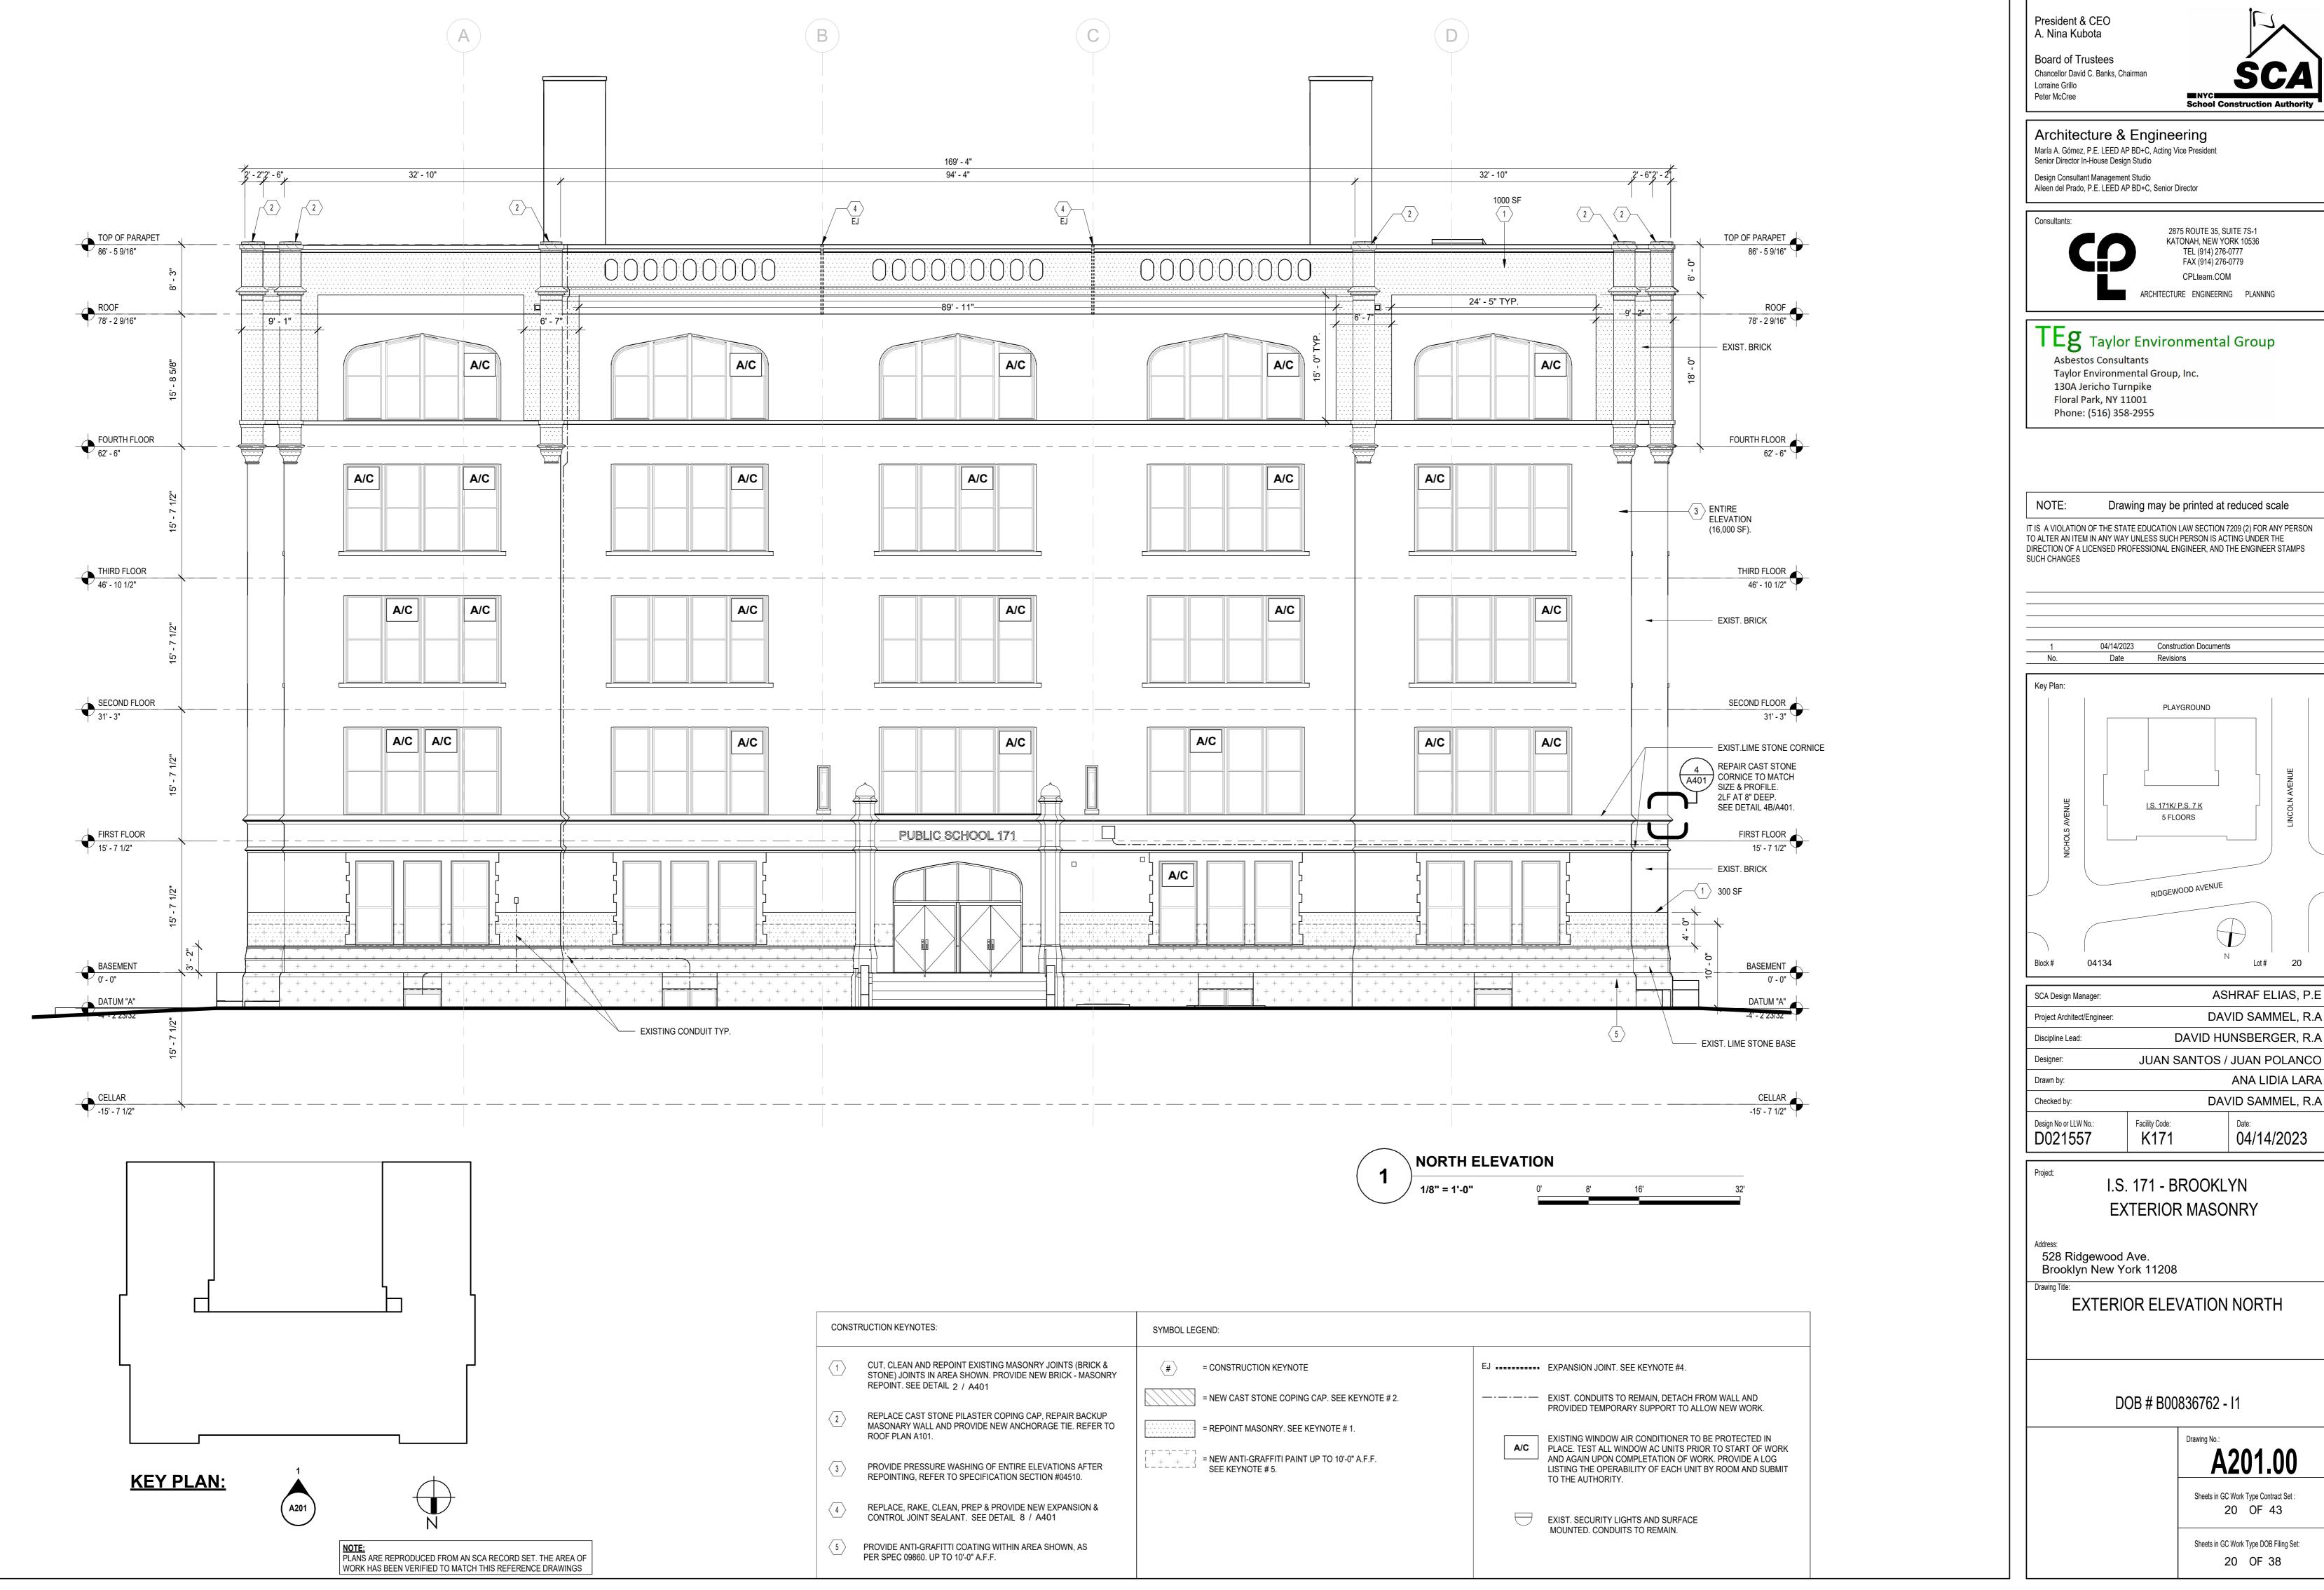




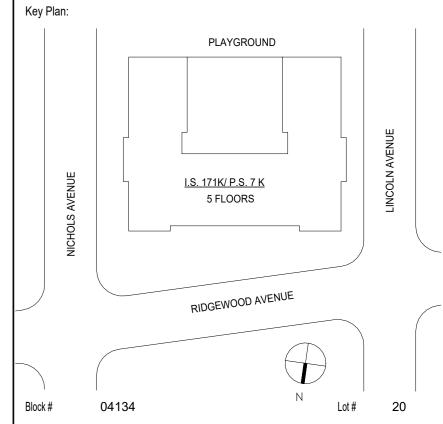




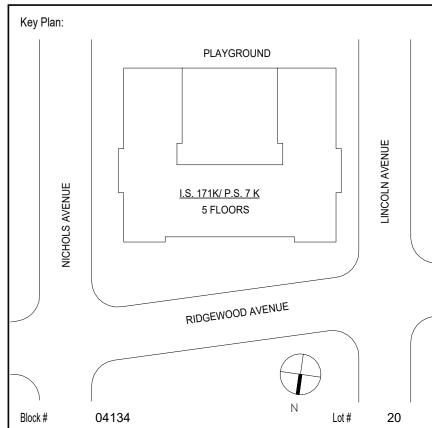


ASHRAF ELIAS, P.E DAVID SAMMEL, R.A DAVID HUNSBERGER, R.A JUAN SANTOS / JUAN POLANCO ANA LIDIA LARA DAVID SAMMEL, R.A

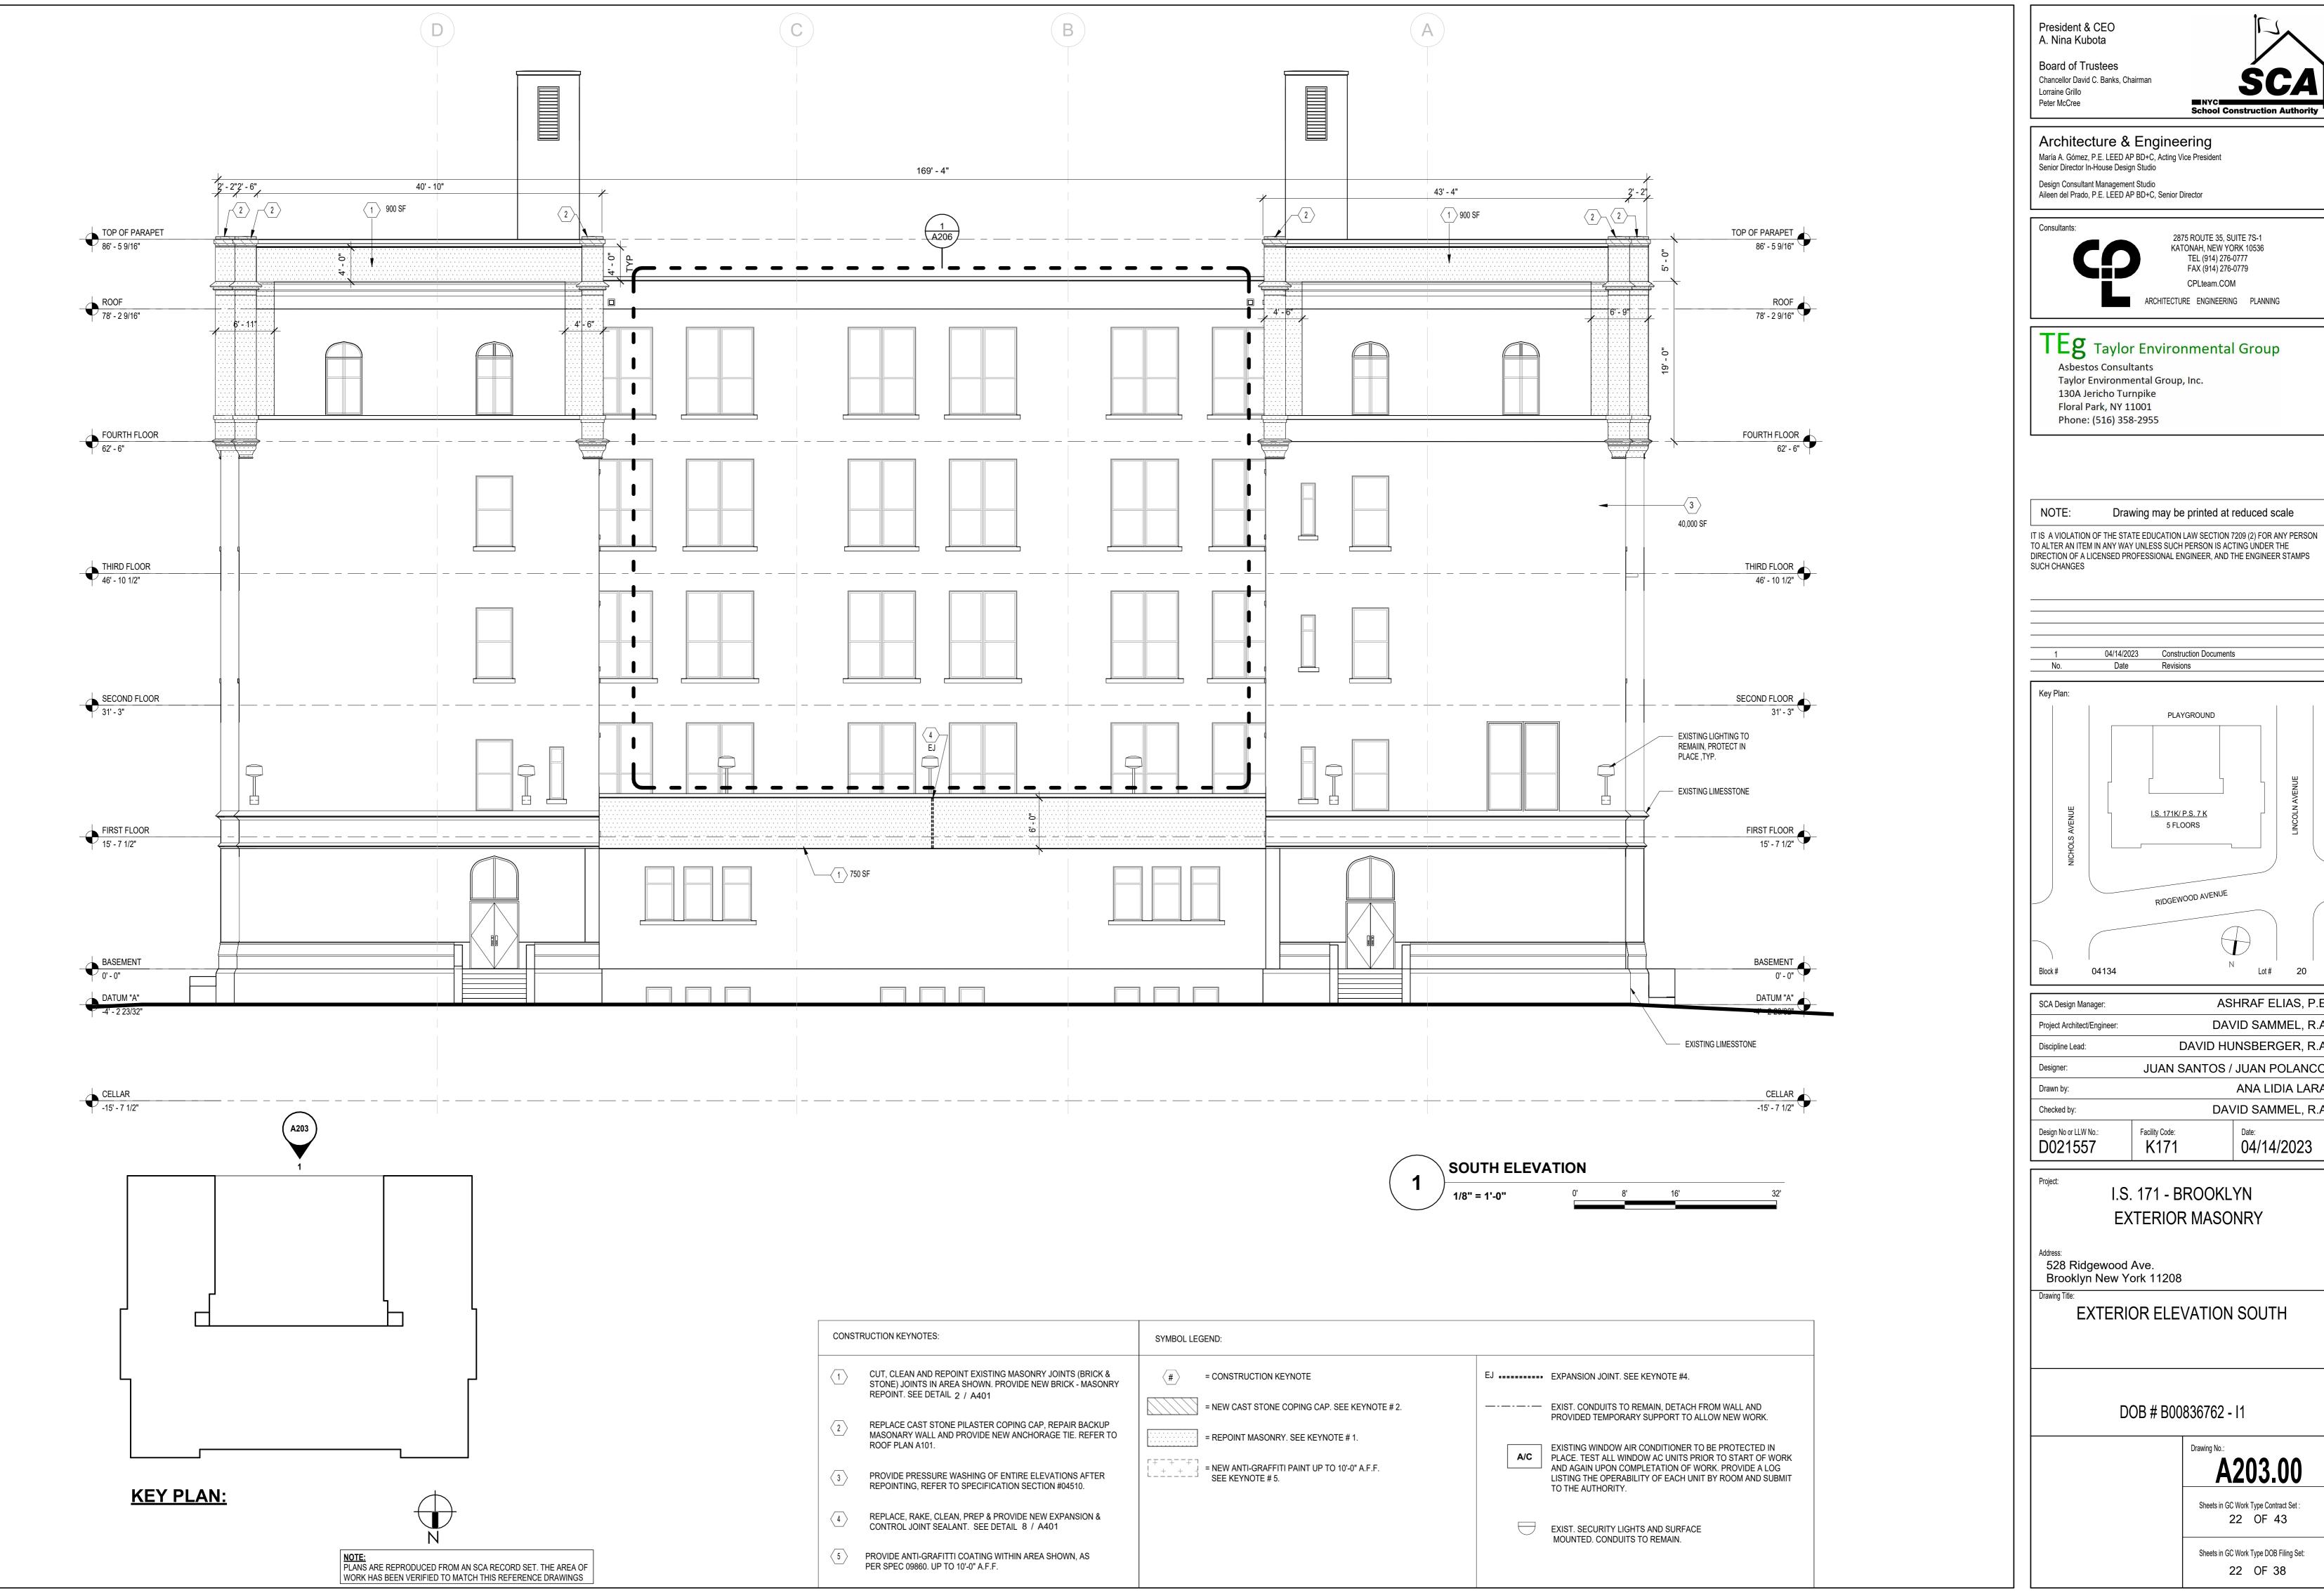




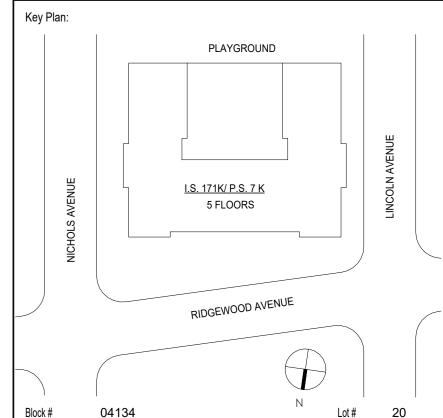



ASHRAF ELIAS, P.E DAVID SAMMEL, R.A DAVID HUNSBERGER, R.A JUAN SANTOS / JUAN POLANCO ANA LIDIA LARA DAVID SAMMEL, R.A

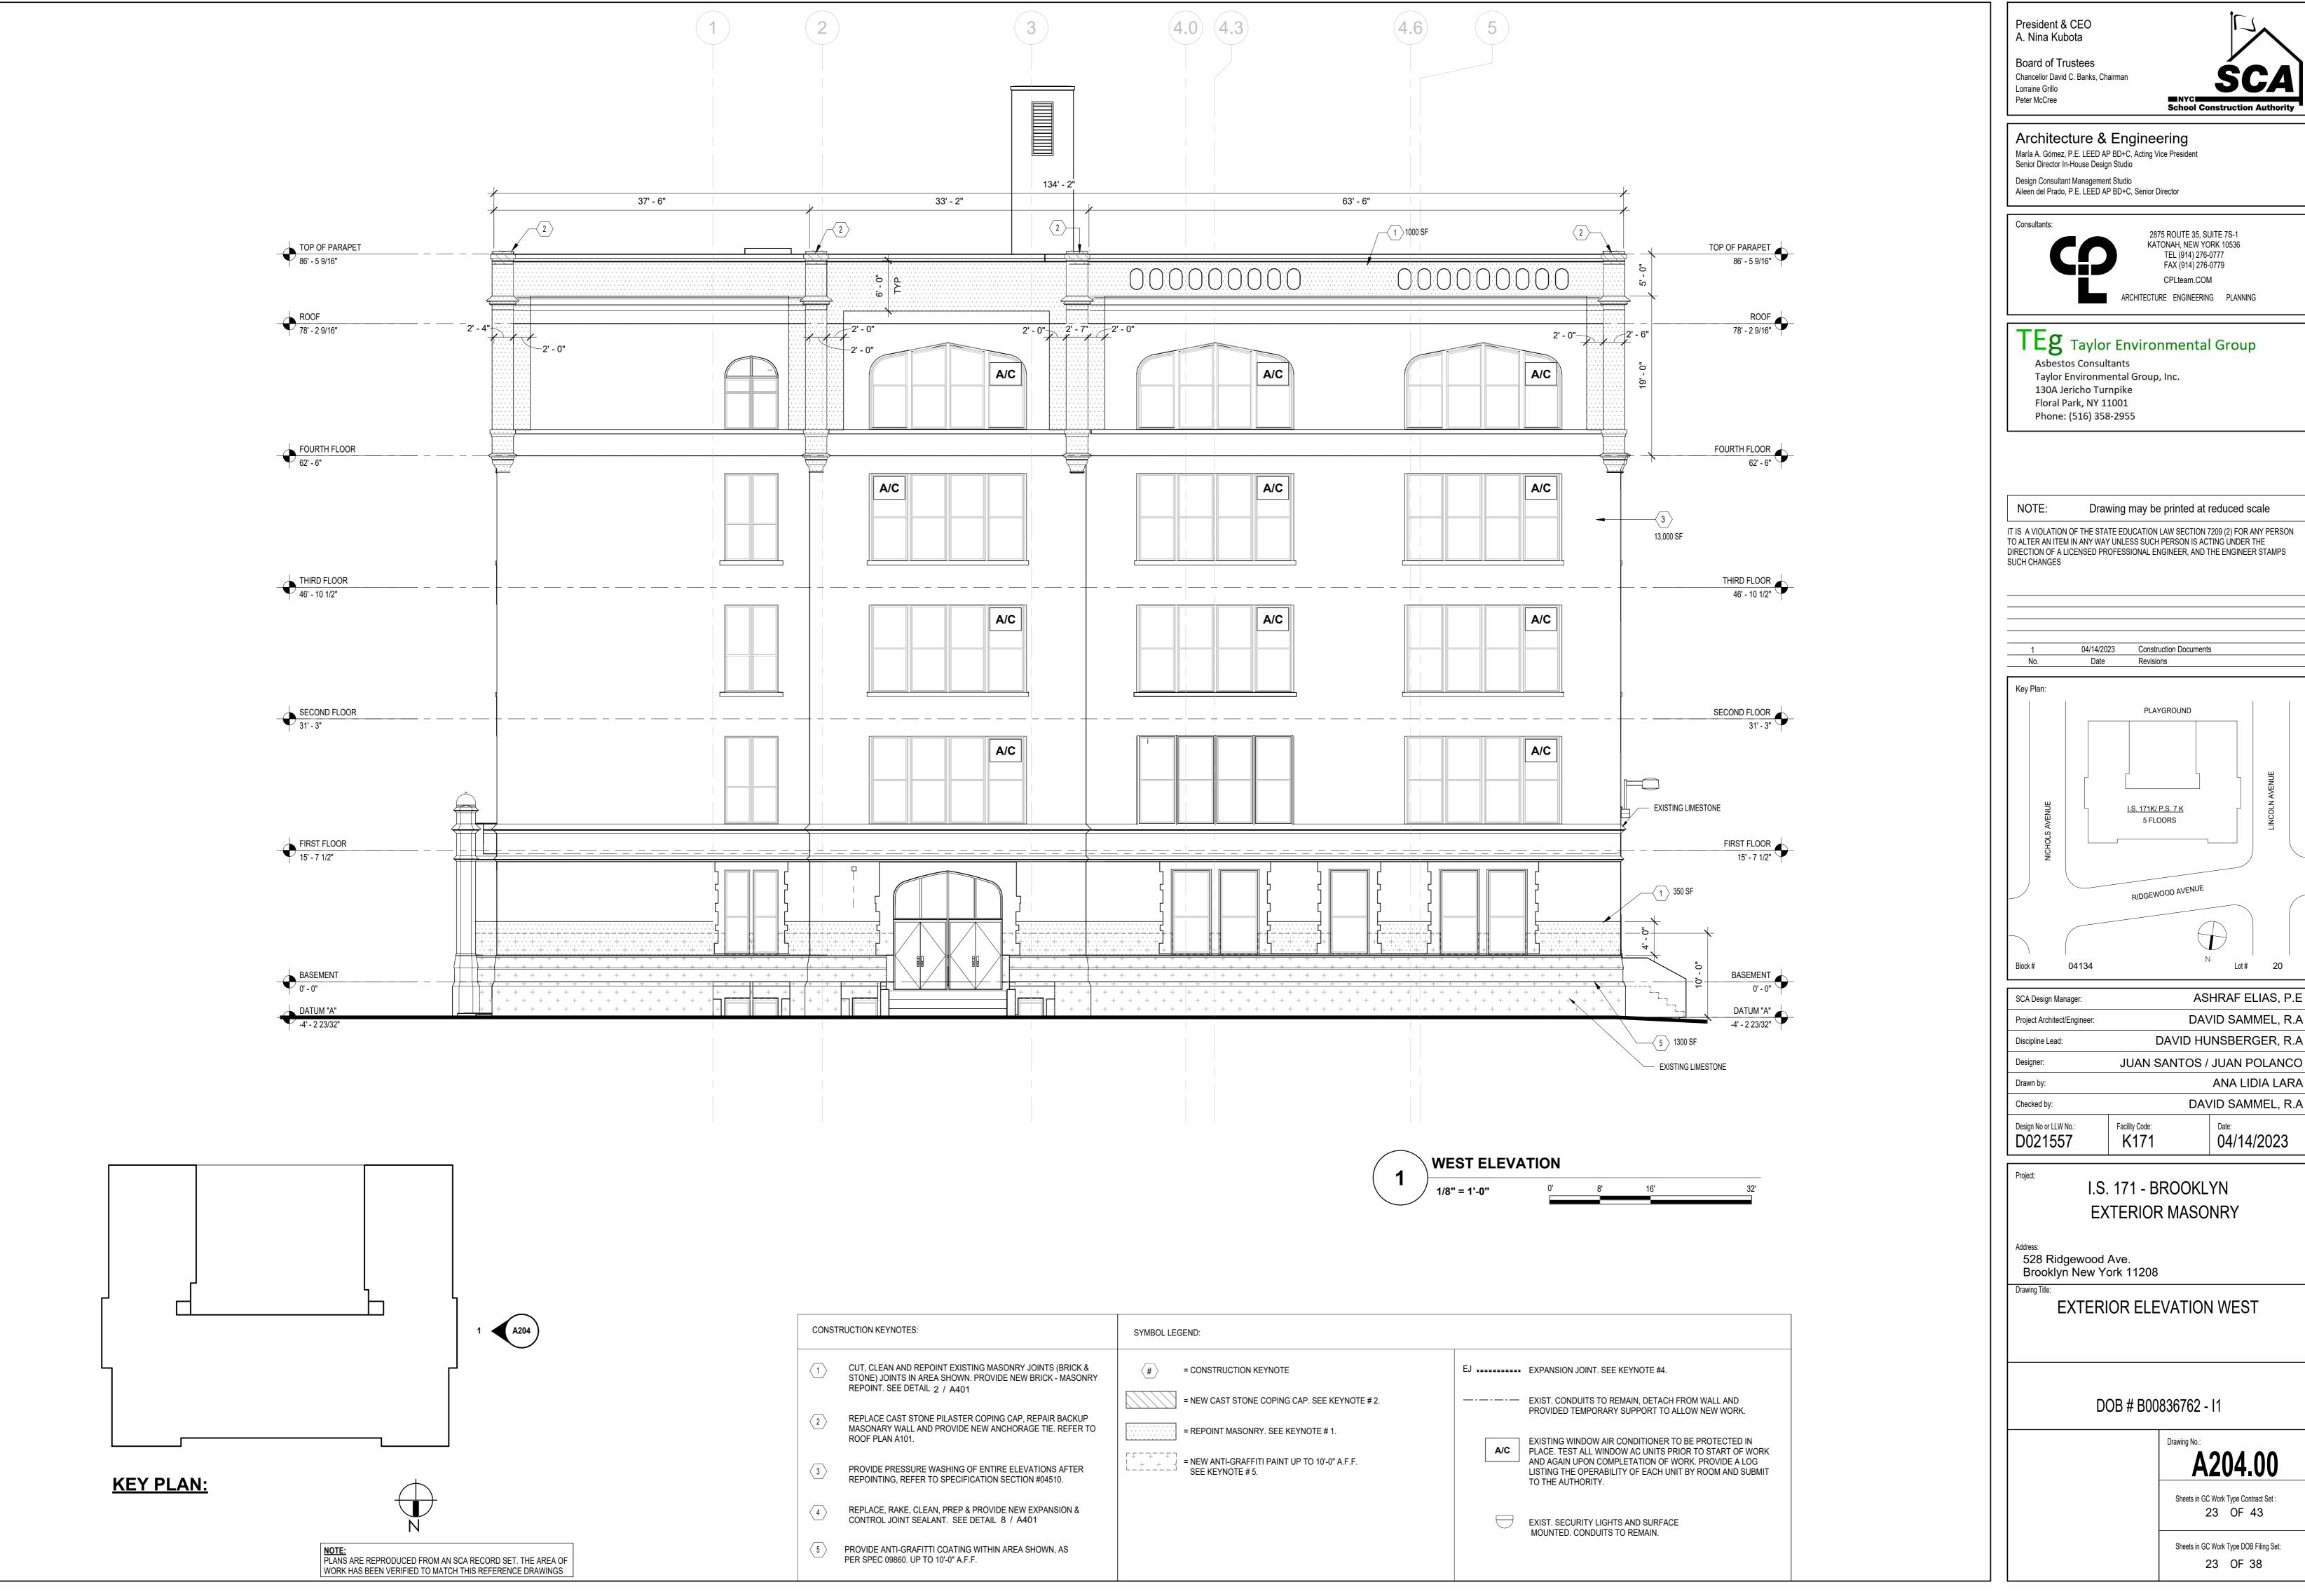




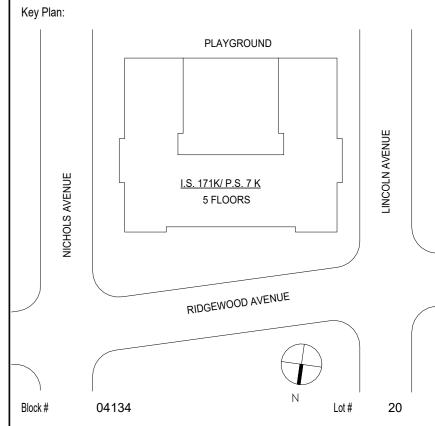

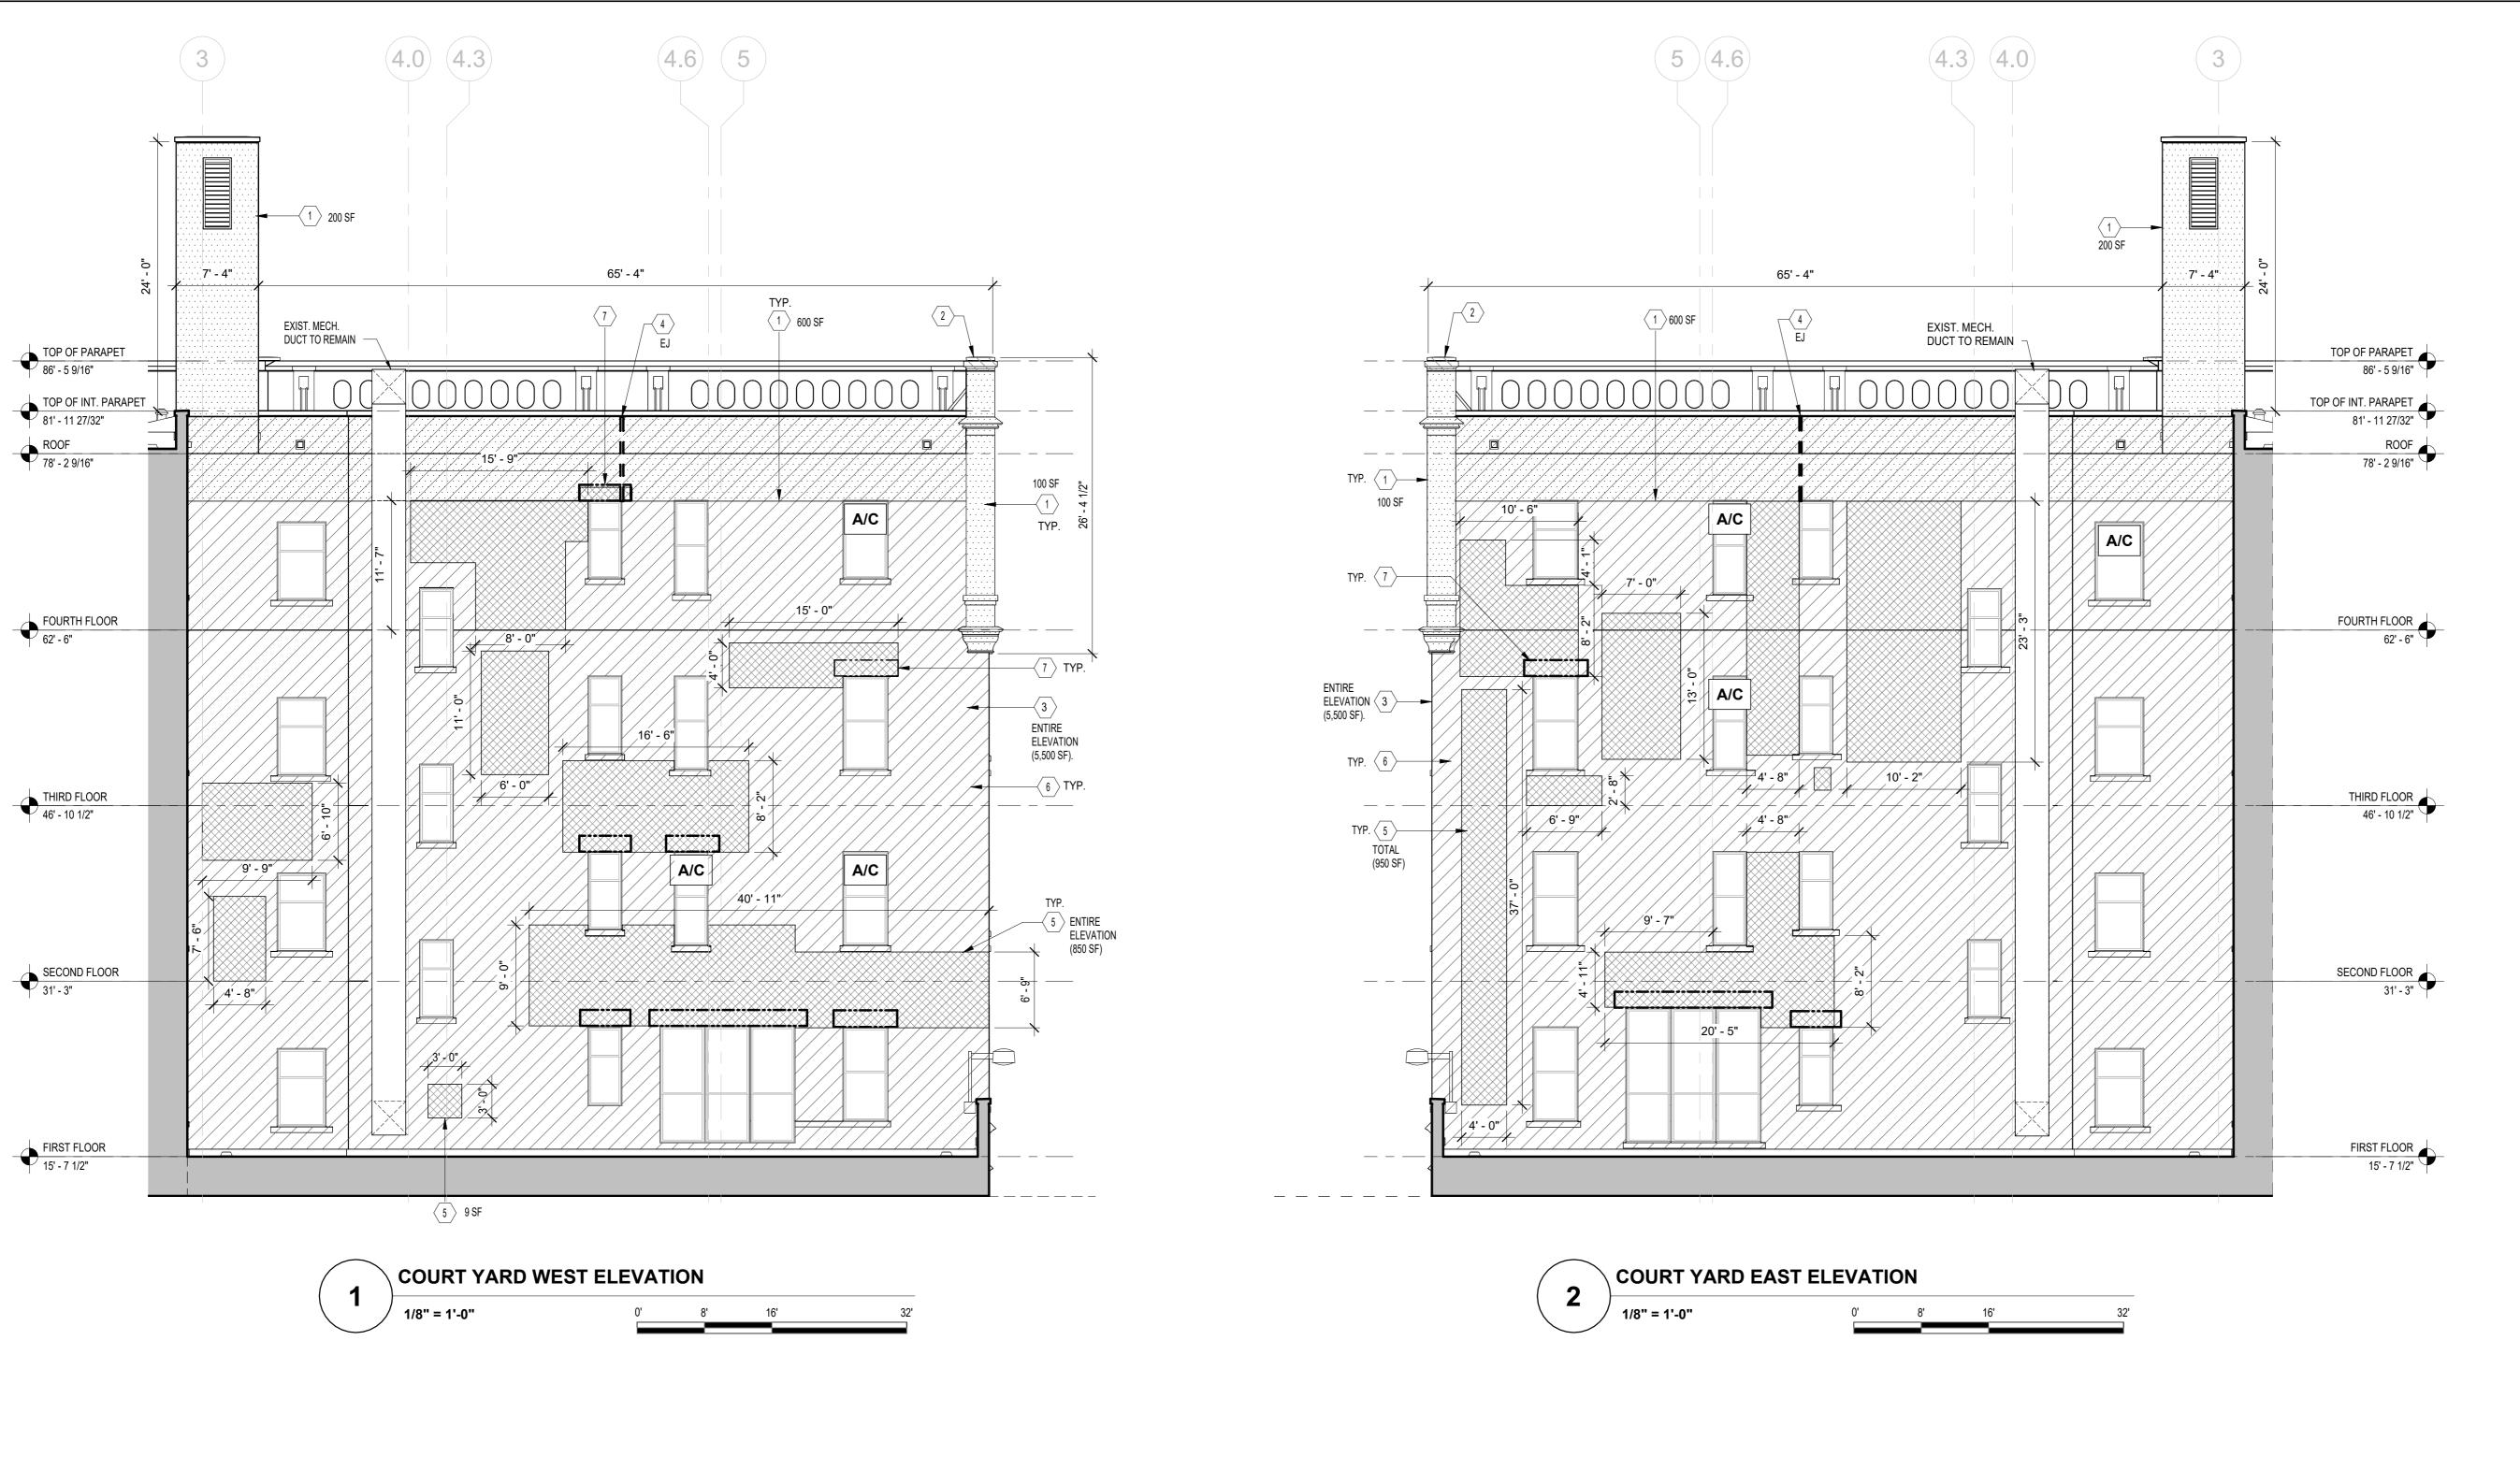

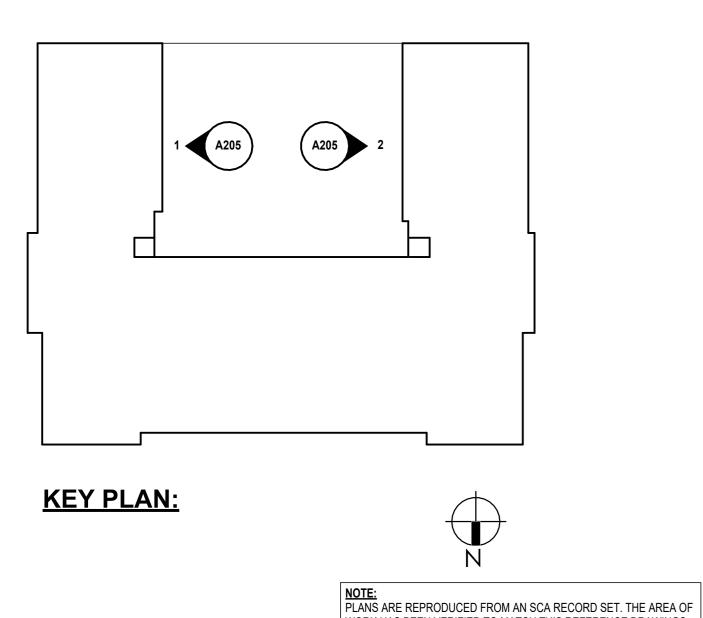

WORK HAS BEEN VERIFIED TO MATCH THIS REFERENCE DRAWINGS

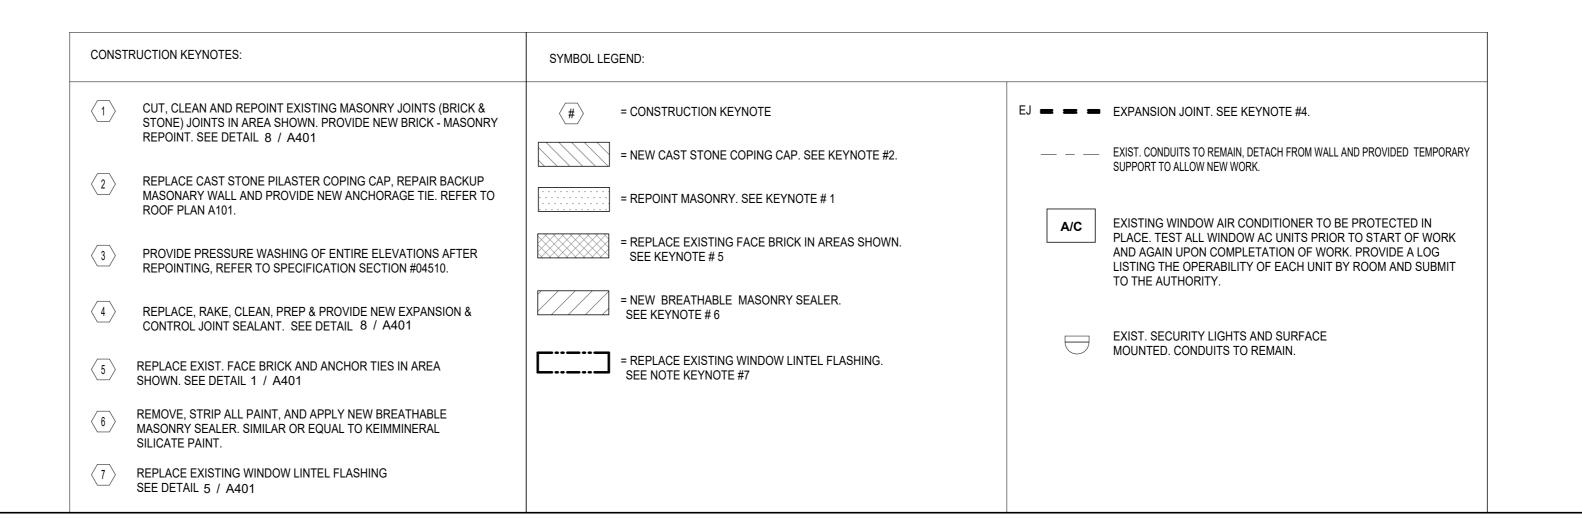

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Peter McCree

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Design Consultant Management Studio Aileen del Prado, P.E. LEED AP BD+C, Senior Director

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2875 ROUTE 35, SUITE 7S-1

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04/14/2023 Construction Documents Date Revisions Key Plan: PLAYGROUND I.S. 171K/ P.S. 7 K RIDGEWOOD AVENUE

ASHRAF ELIAS, P.E SCA Design Manager: DAVID SAMMEL, R.A Project Architect/Engineer: DAVID HUNSBERGER, R.A Discipline Lead: JUAN SANTOS / JUAN POLANCO Designer: ANA LIDIA LARA DAVID SAMMEL, R.A Checked by: Facility Code: Design No or LLW No.: K171 D021557 04/14/2023

> I.S. 171 - BROOKLYN **EXTERIOR MASONRY**

528 Ridgewood Ave.

Brooklyn New York 11208

Block #

**EXTERIOR ELEVATIONS COURTYARD-1** 


DOB # B00836762 - I1


A205.00

Lot#


Sheets in GC Work Type Contract Set : 24 OF 43

Sheets in GC Work Type DOB Filing Set: 24 OF 38

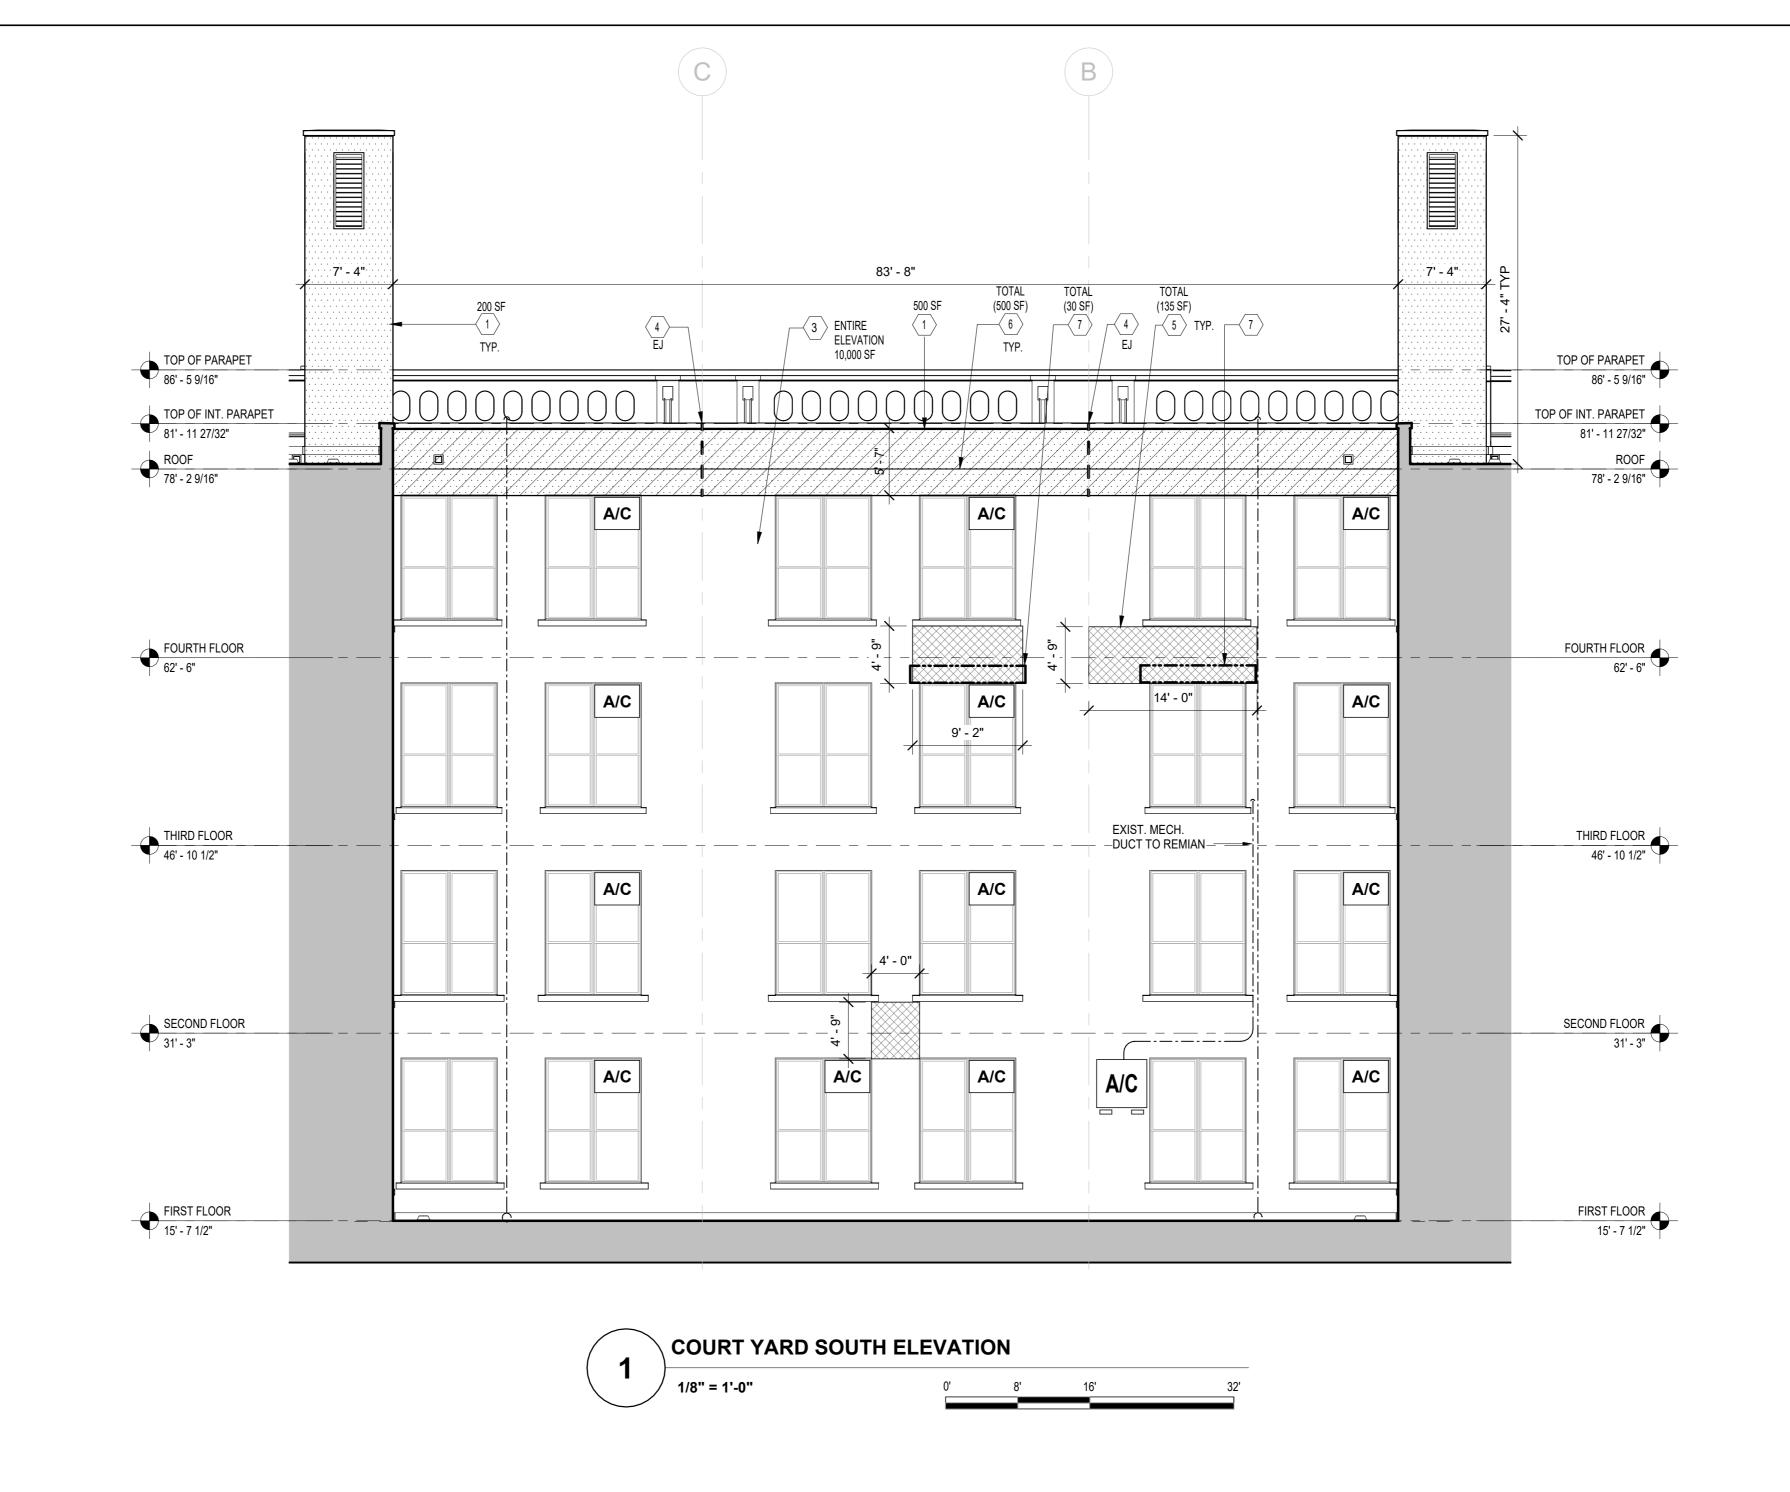

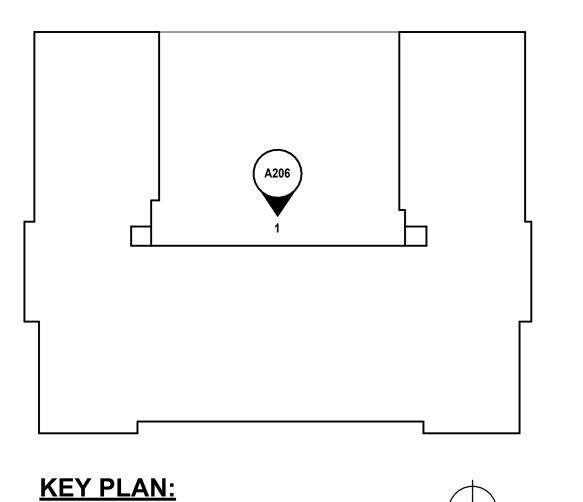

NOTE:
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President & CEO A. Nina Kubota

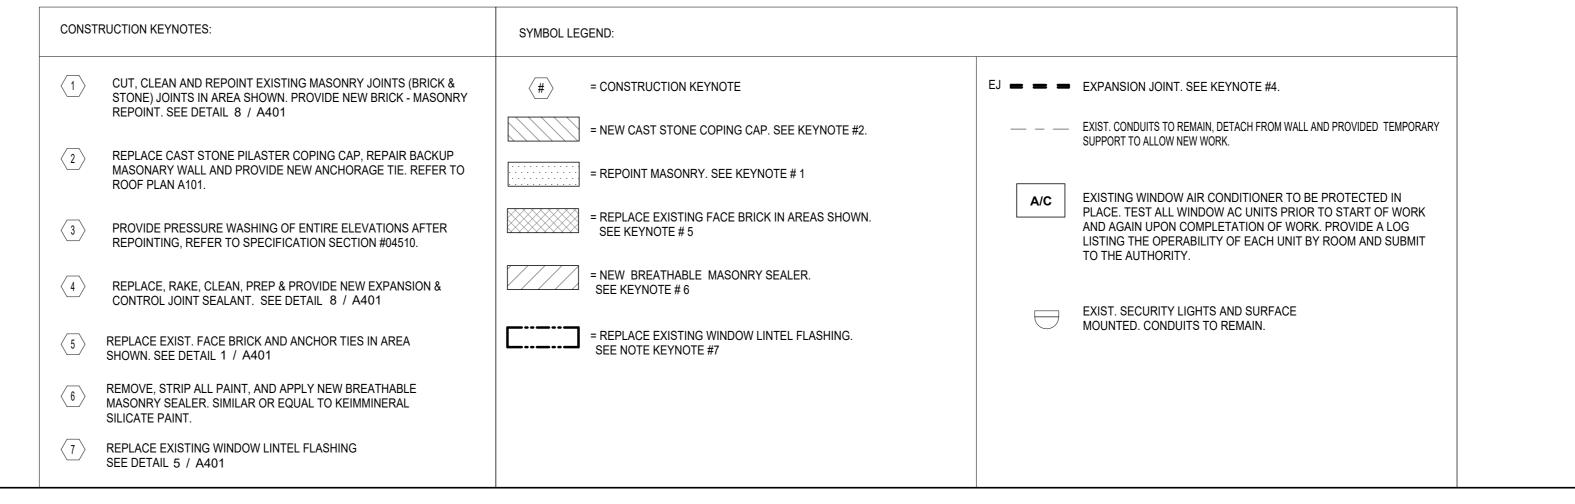Board of Trustees Chancellor David C. Banks, Chairman Lorraine Grillo Peter McCree



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María A. Gómez, P.E. LEED AP BD+C, Acting Vice President Senior Director In-House Design Studio

Design Consultant Management Studio
Aileen del Prado, P.E. LEED AP BD+C, Senior Director

Consultants:


2875 ROUTE 35, SUITE 7S-1 KATONAH, NEW YORK 10536 TEL (914) 276-0777 FAX (914) 276-0779 CPLteam.COM ARCHITECTURE ENGINEERING PLANNING

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04/14/2023 Construction Documents Date Revisions



ASHRAF ELIAS, P.E SCA Design Manager: DAVID SAMMEL, R.A Project Architect/Engineer: DAVID HUNSBERGER, R.A Discipline Lead: Designer: JUAN SANTOS / JUAN POLANCO ANA LIDIA LARA DAVID SAMMEL, R.A Checked by: Facility Code: Design No or LLW No.: K171 D021557 04/14/2023

I.S. 171 - BROOKLYN **EXTERIOR MASONRY** 

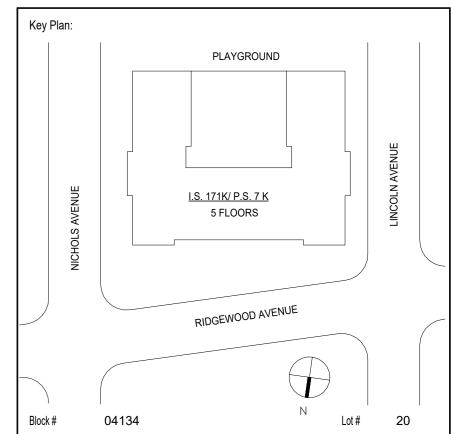528 Ridgewood Ave. Brooklyn New York 11208


**EXTERIOR ELEVATIONS COURTYARD-2** 


DOB # B00836762 - I1


A206.00

Sheets in GC Work Type Contract Set : 25 OF 43

Sheets in GC Work Type DOB Filing Set: 25 OF 38

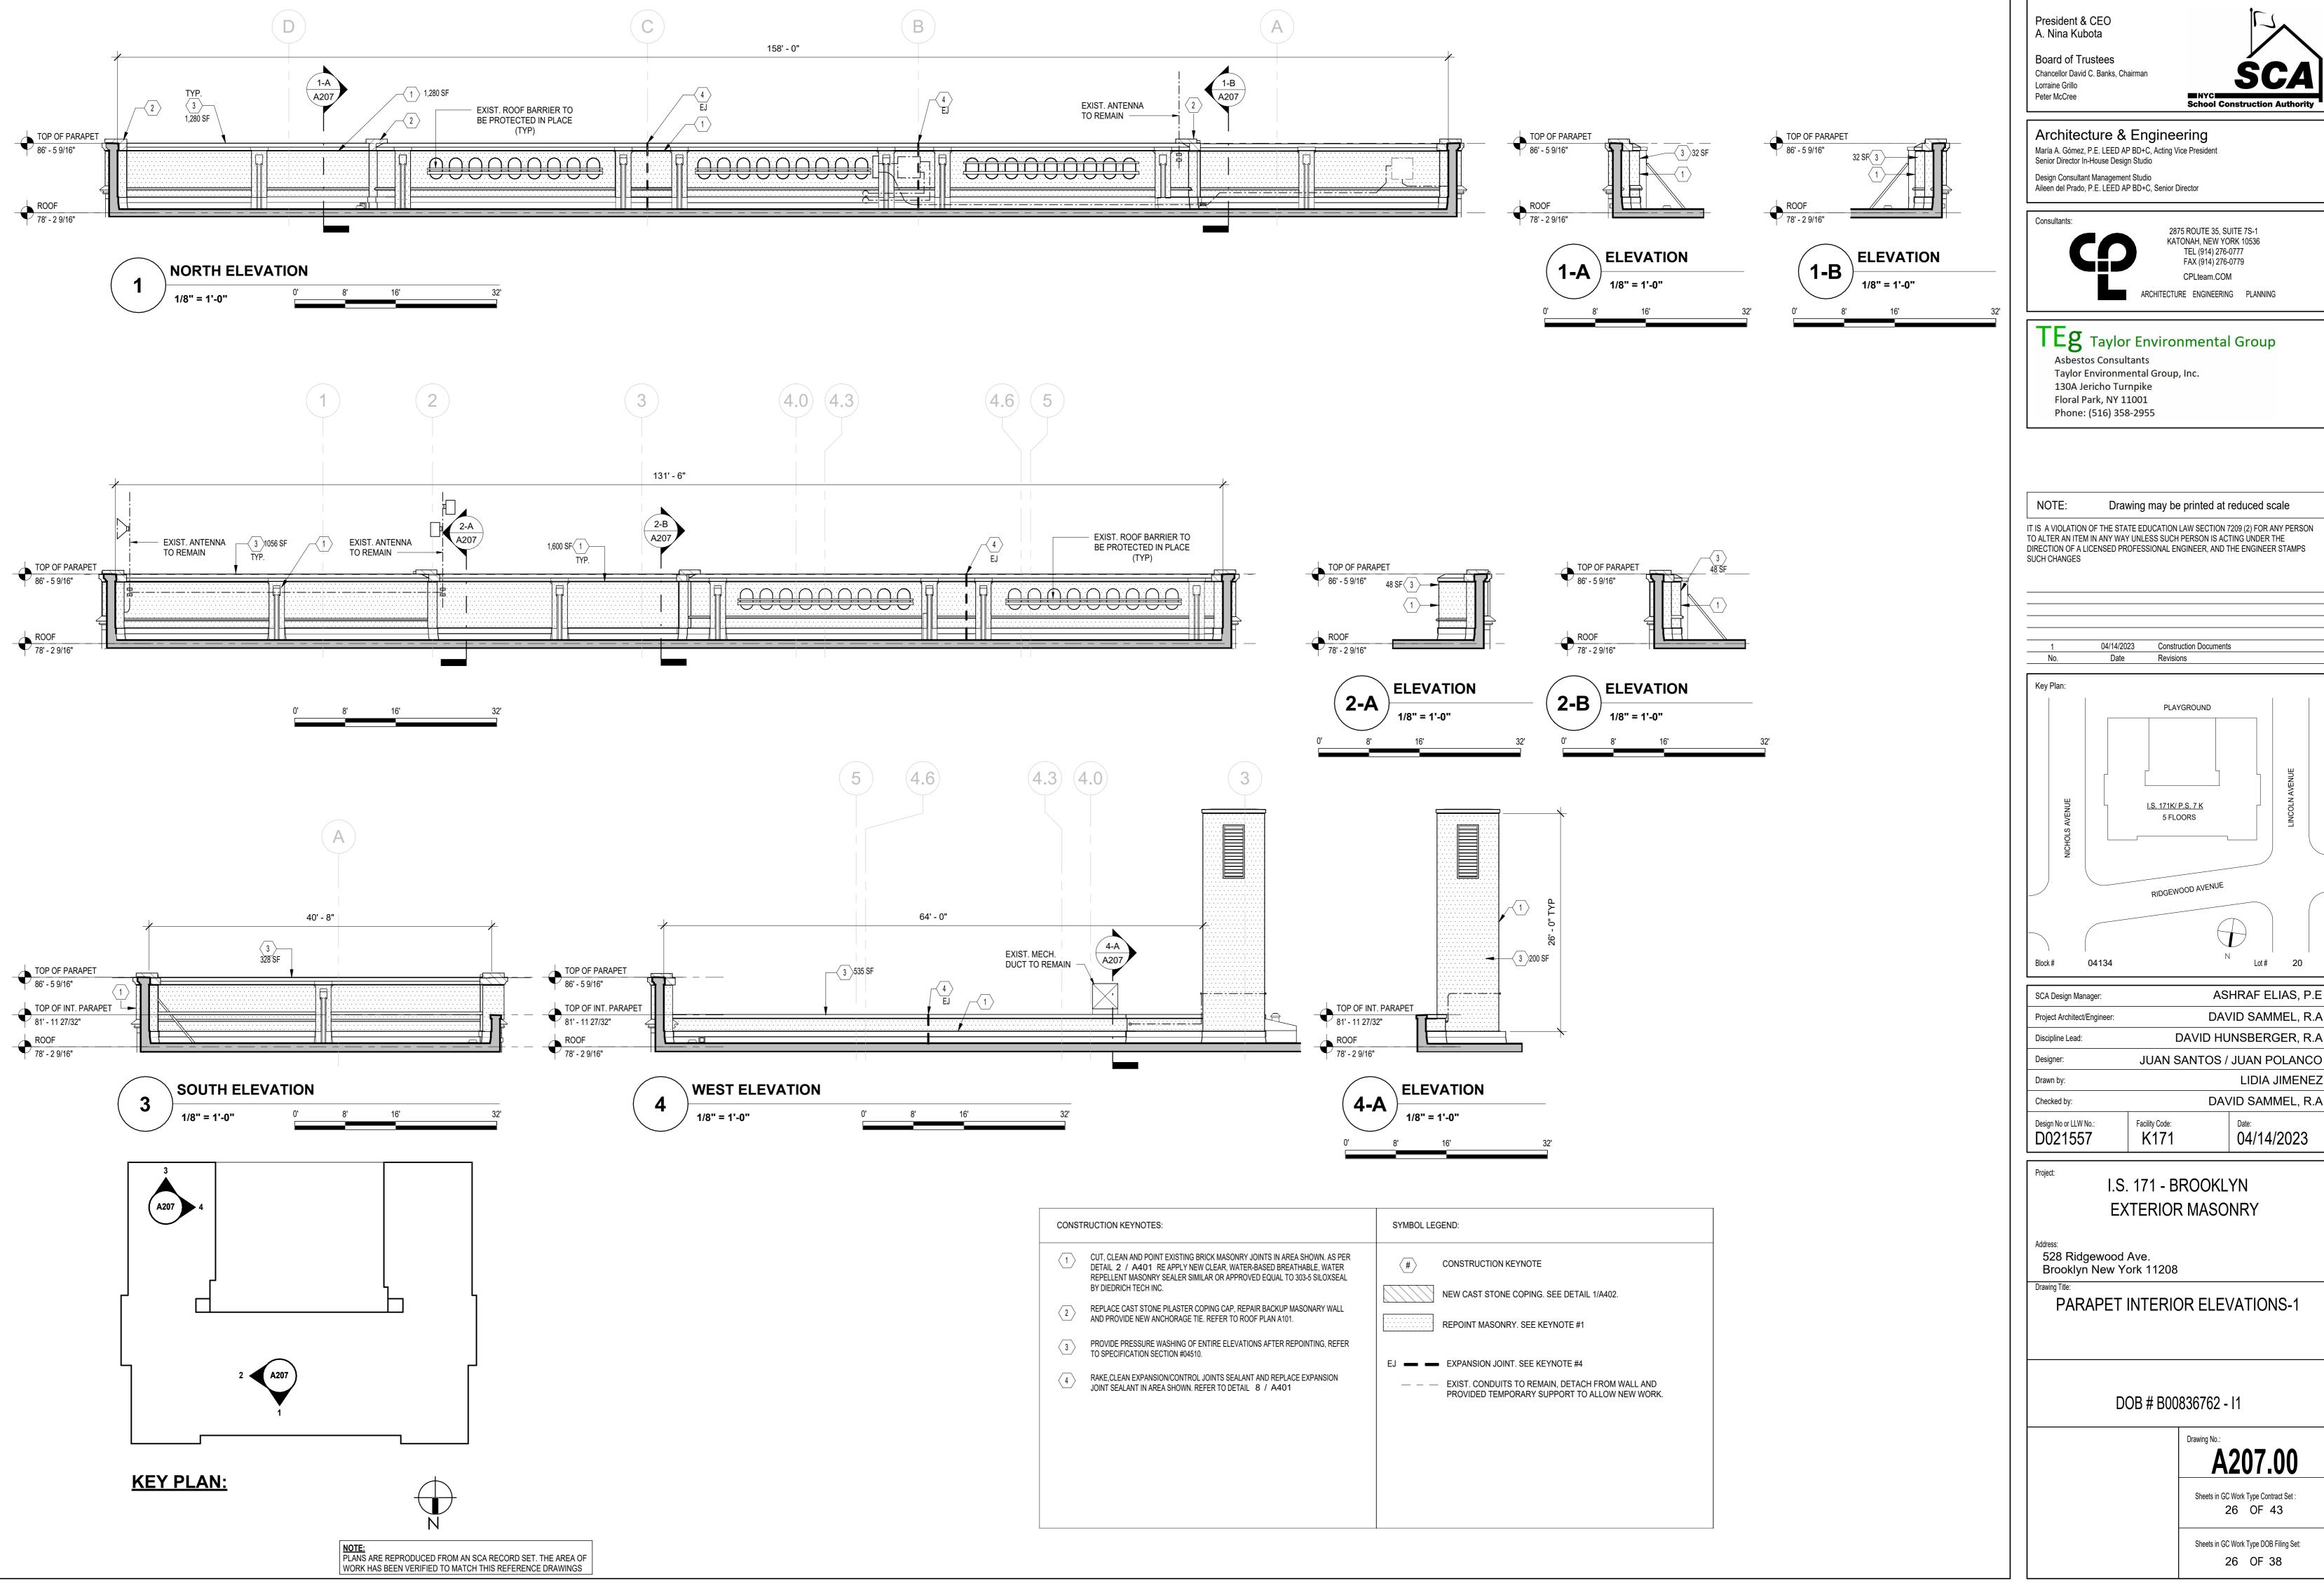


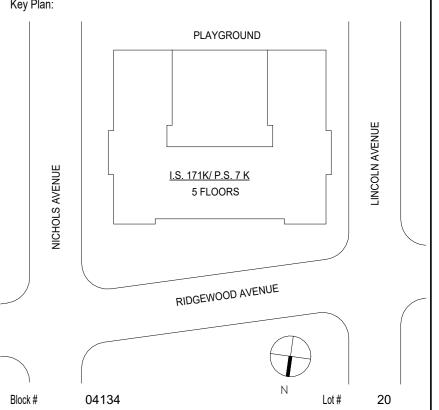


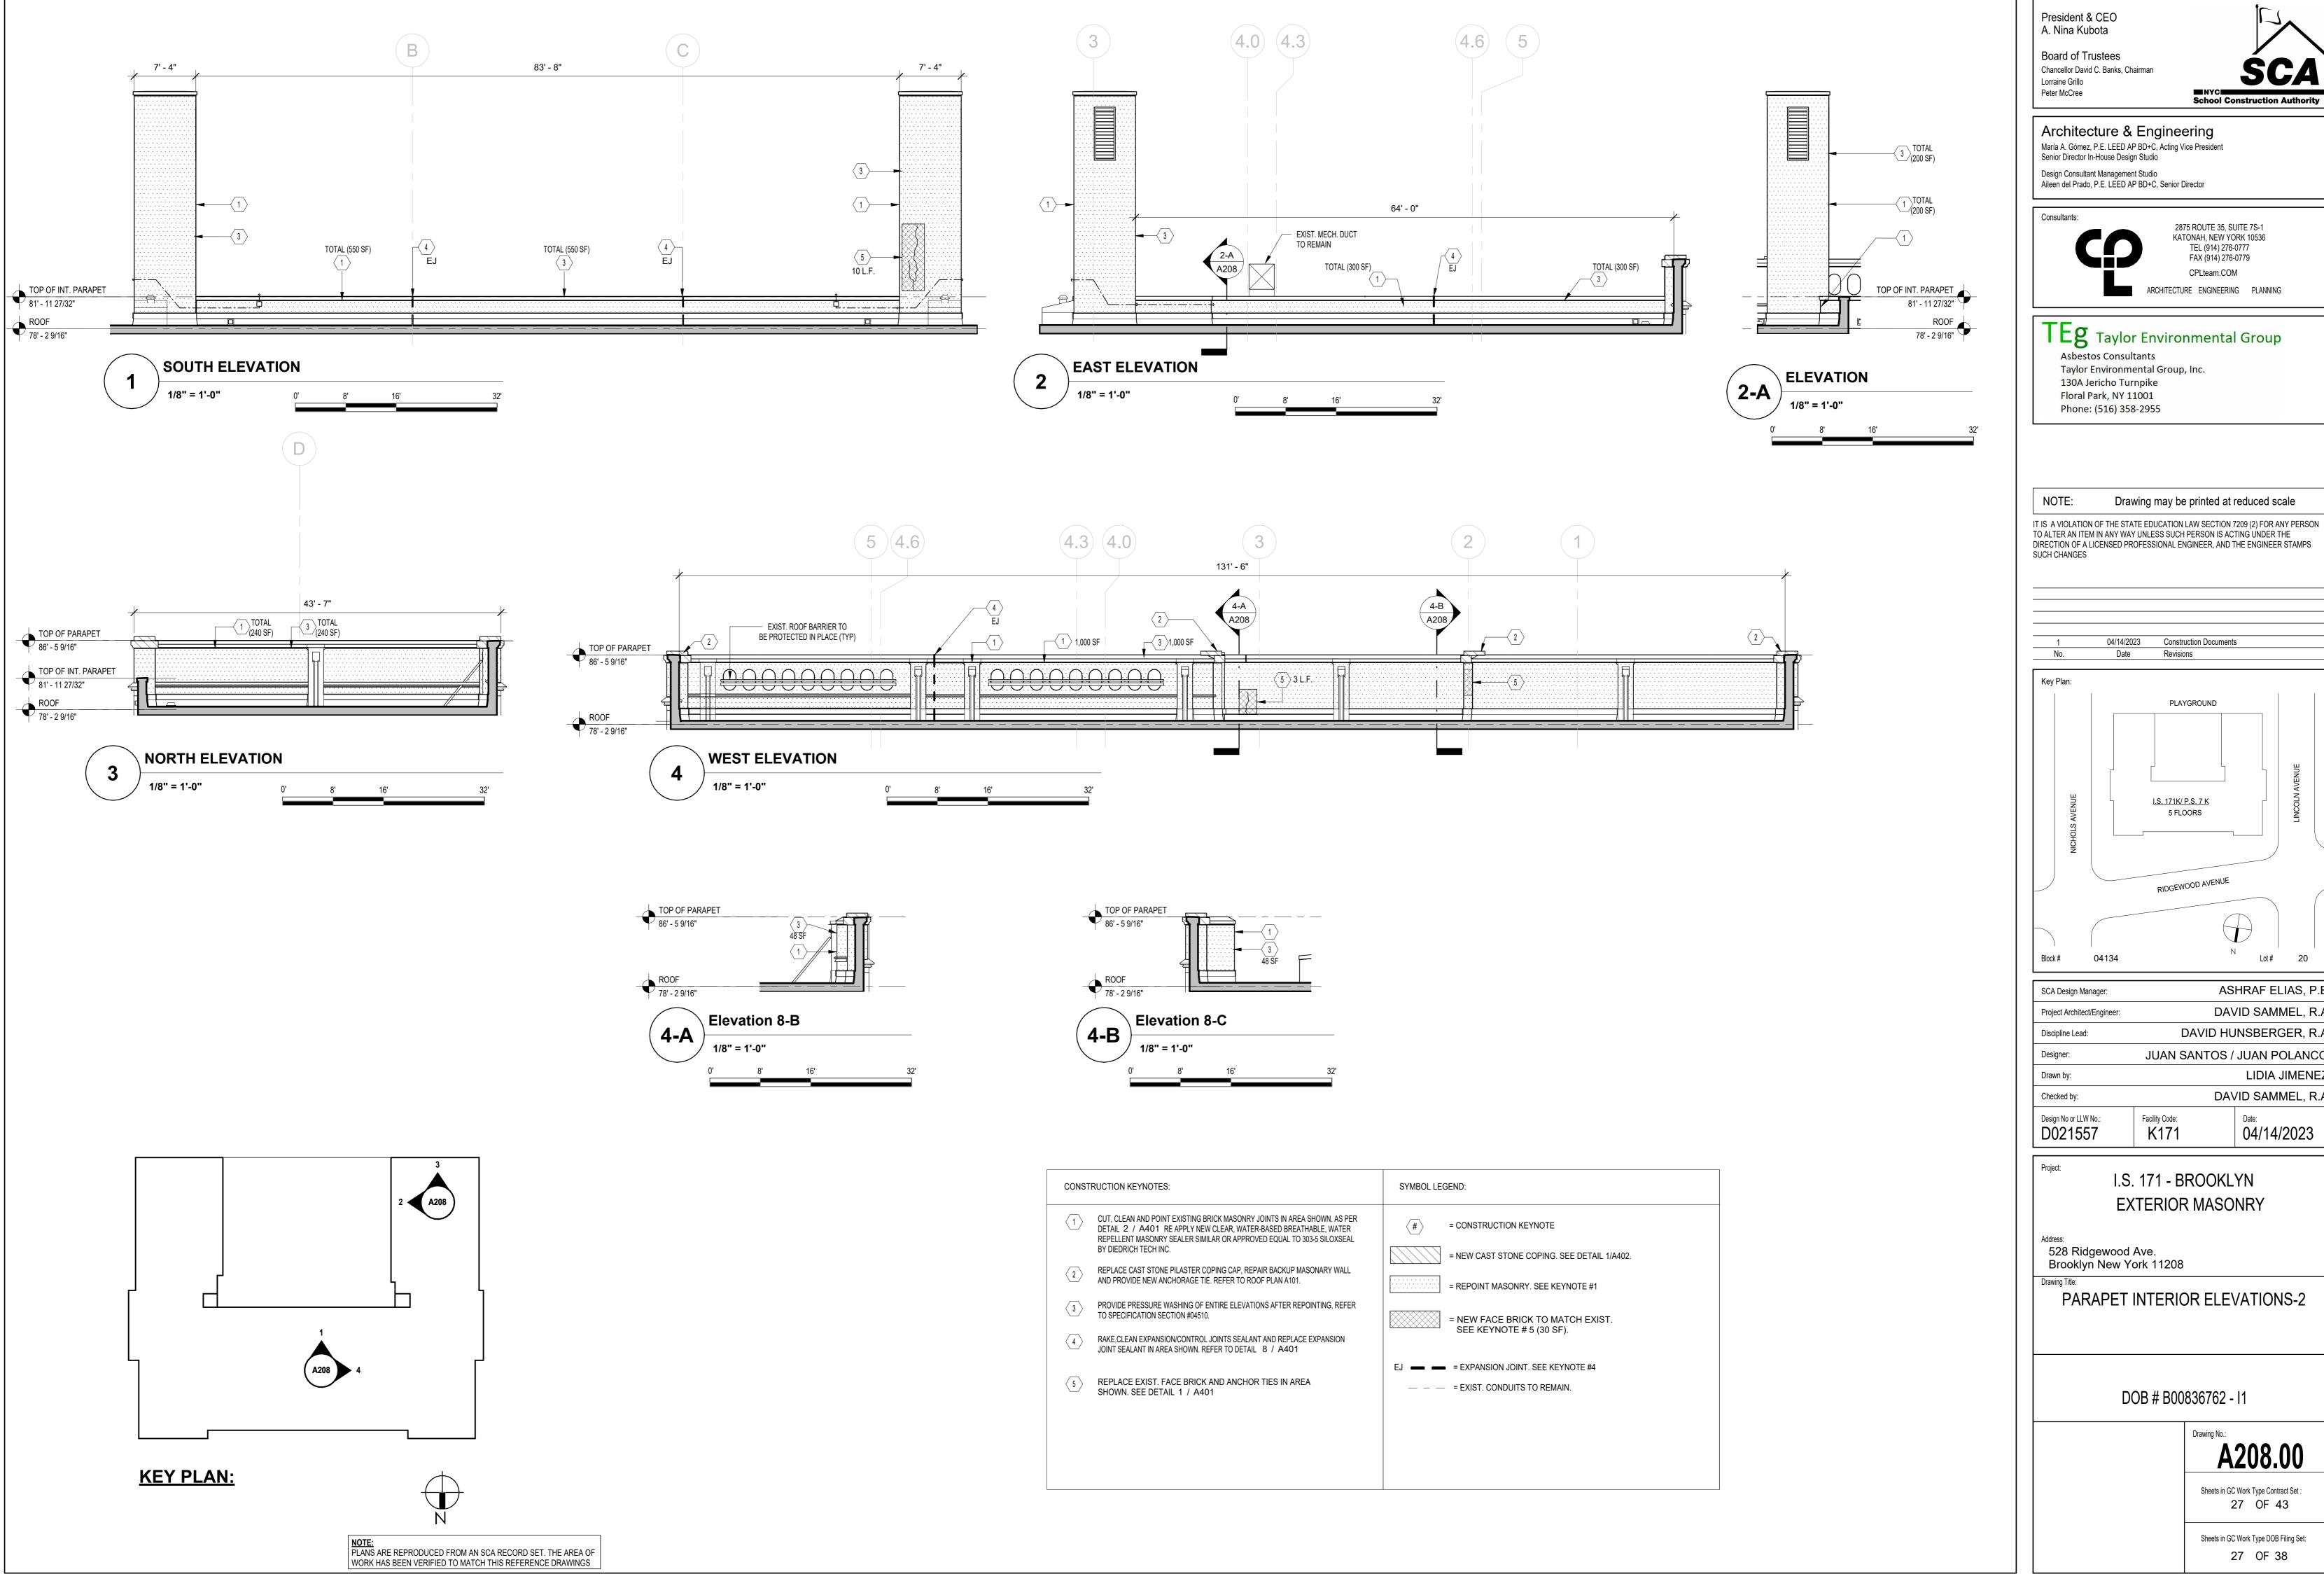



ASHRAF ELIAS, P.E DAVID SAMMEL, R.A DAVID HUNSBERGER, R.A JUAN SANTOS / JUAN POLANCO LIDIA JIMENEZ DAVID SAMMEL, R.A

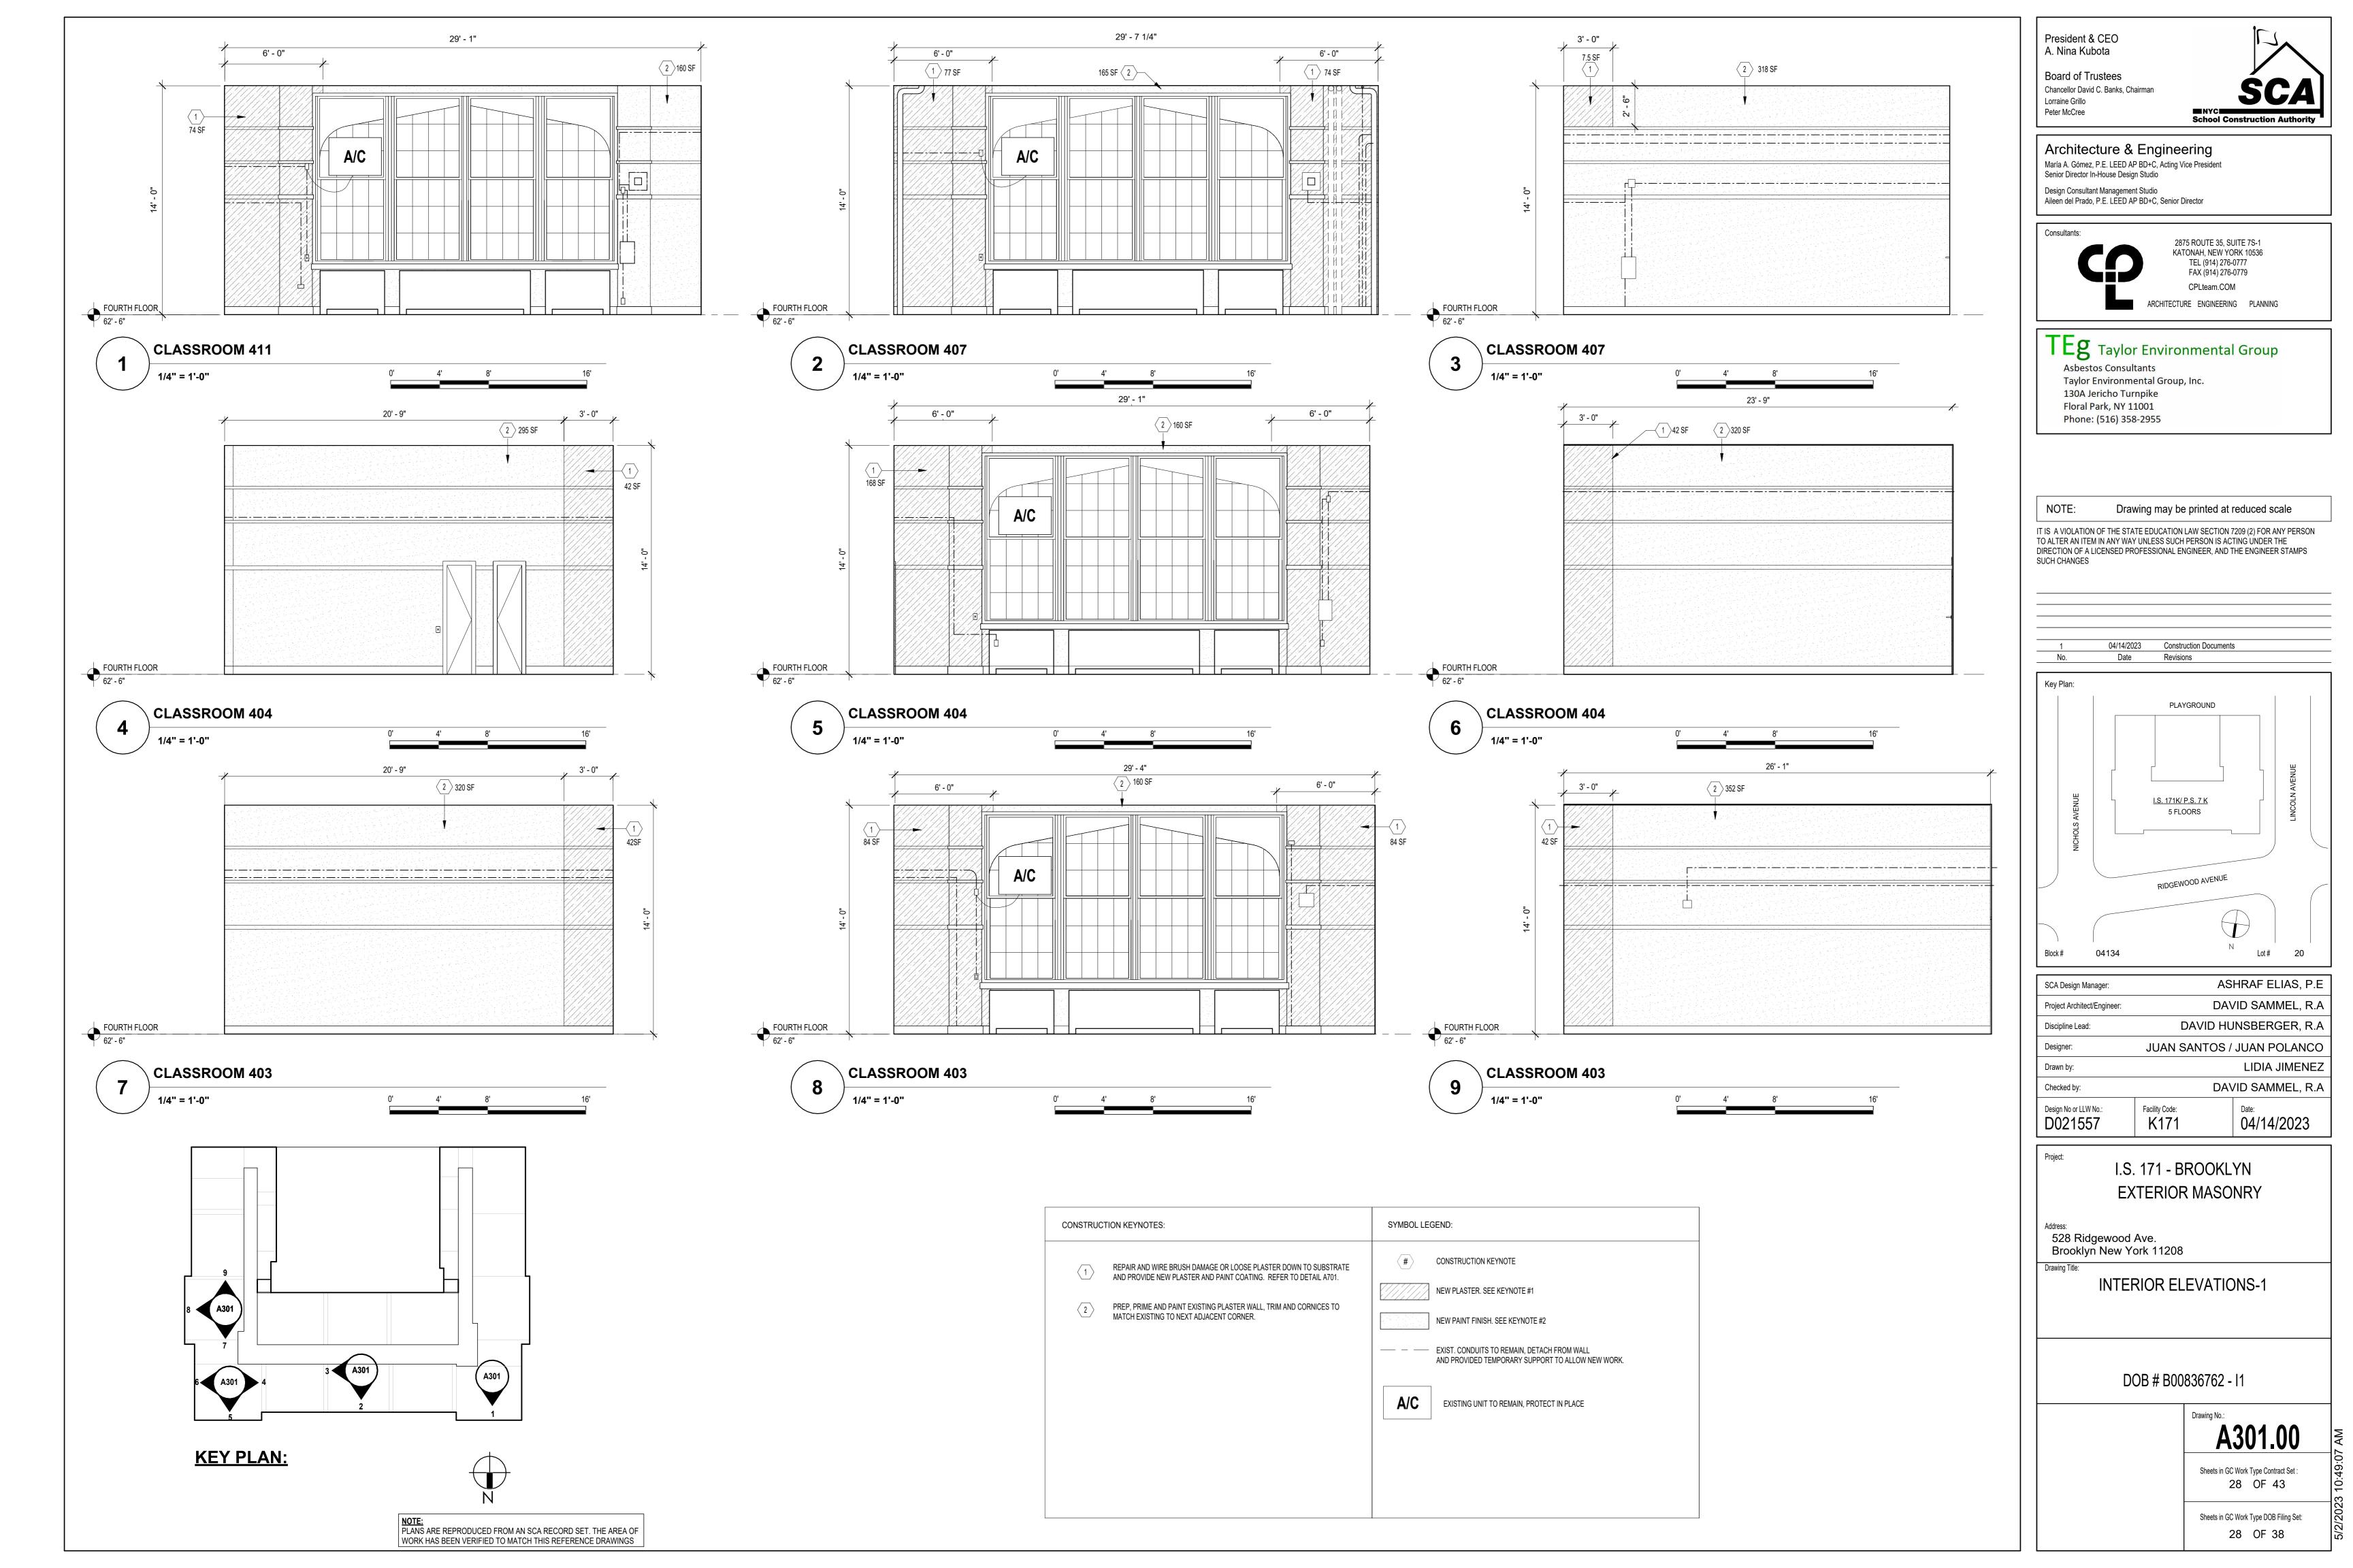

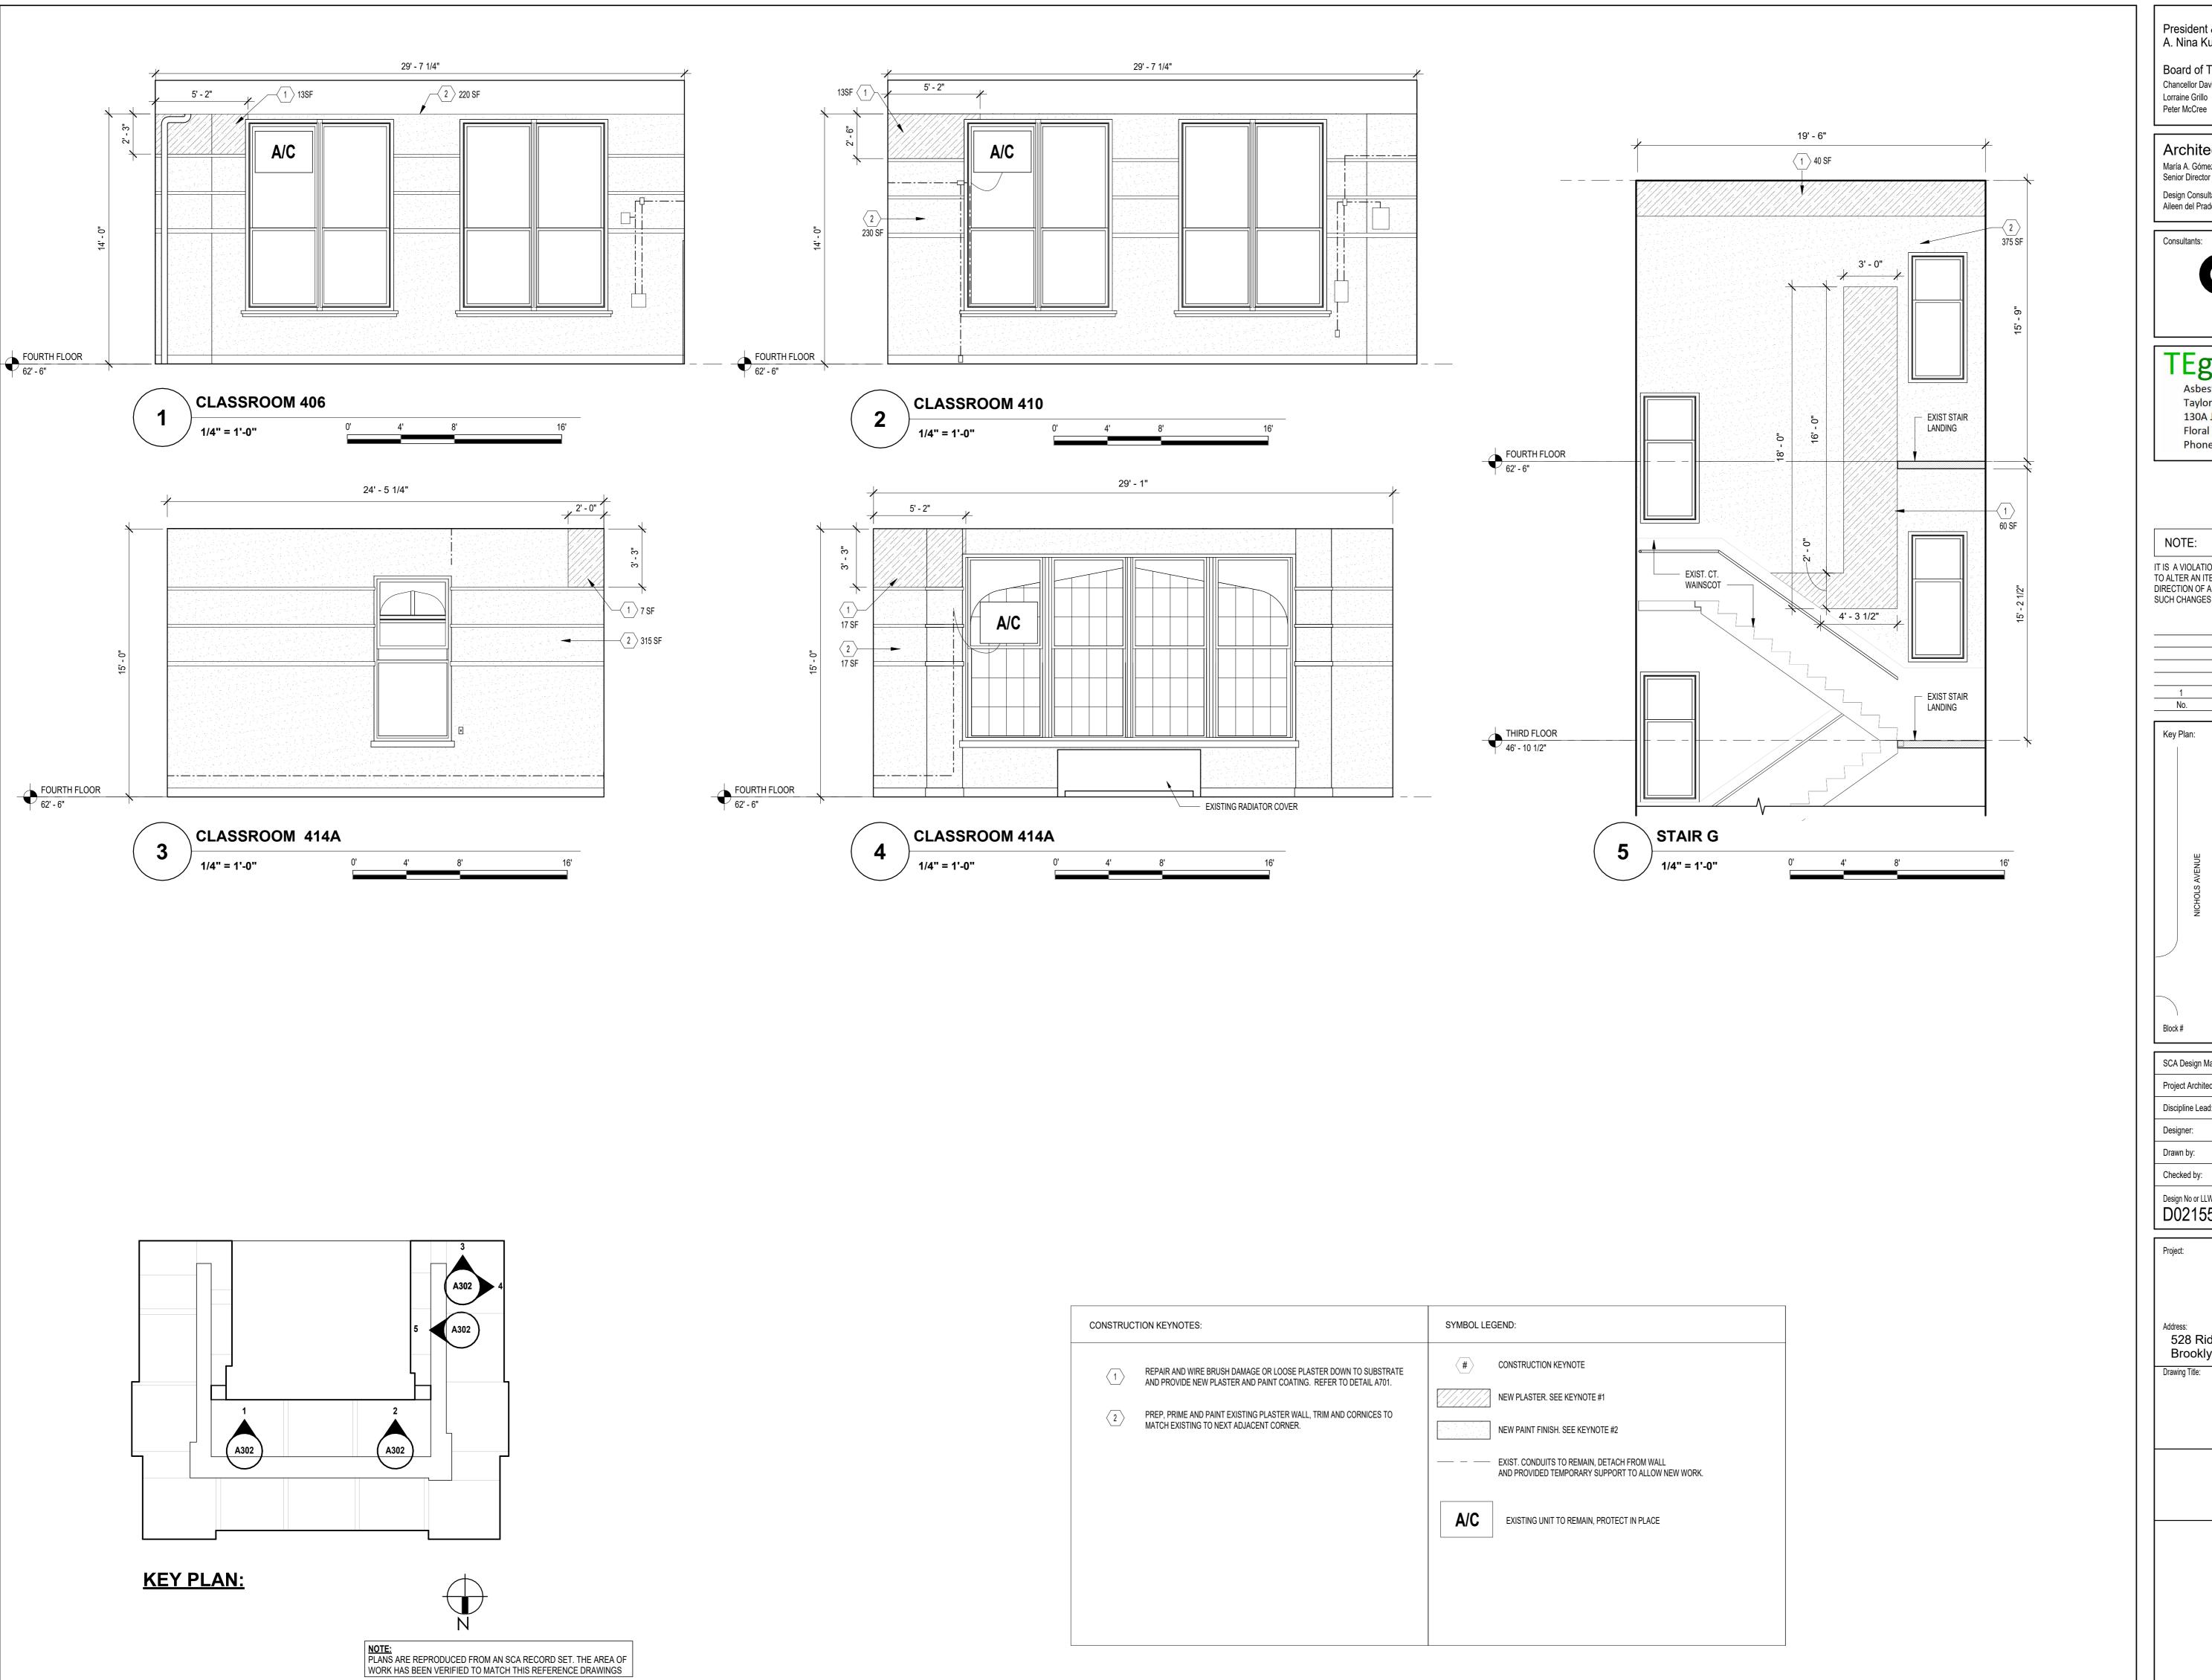

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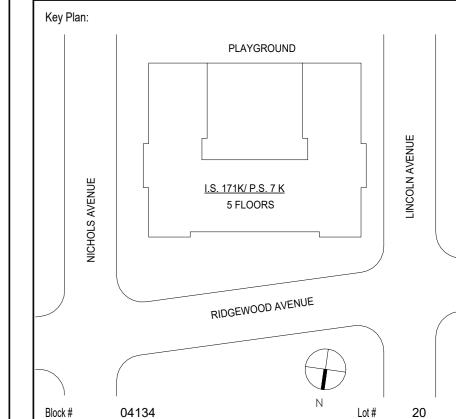
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TEg Taylor Environmental Group **Asbestos Consultants** Taylor Environmental Group, Inc. 130A Jericho Turnpike Floral Park, NY 11001 Phone: (516) 358-2955

Drawing may be printed at reduced scale

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04/14/2023 Construction Documents Date Revisions



ASHRAF ELIAS, P.E SCA Design Manager: DAVID SAMMEL, R.A Project Architect/Engineer: DAVID HUNSBERGER, R.A Discipline Lead: JUAN SANTOS / JUAN POLANCO Designer: LIDIA JIMENEZ DAVID SAMMEL, R.A Checked by: Facility Code: Design No or LLW No.: D021557 K171 04/14/2023

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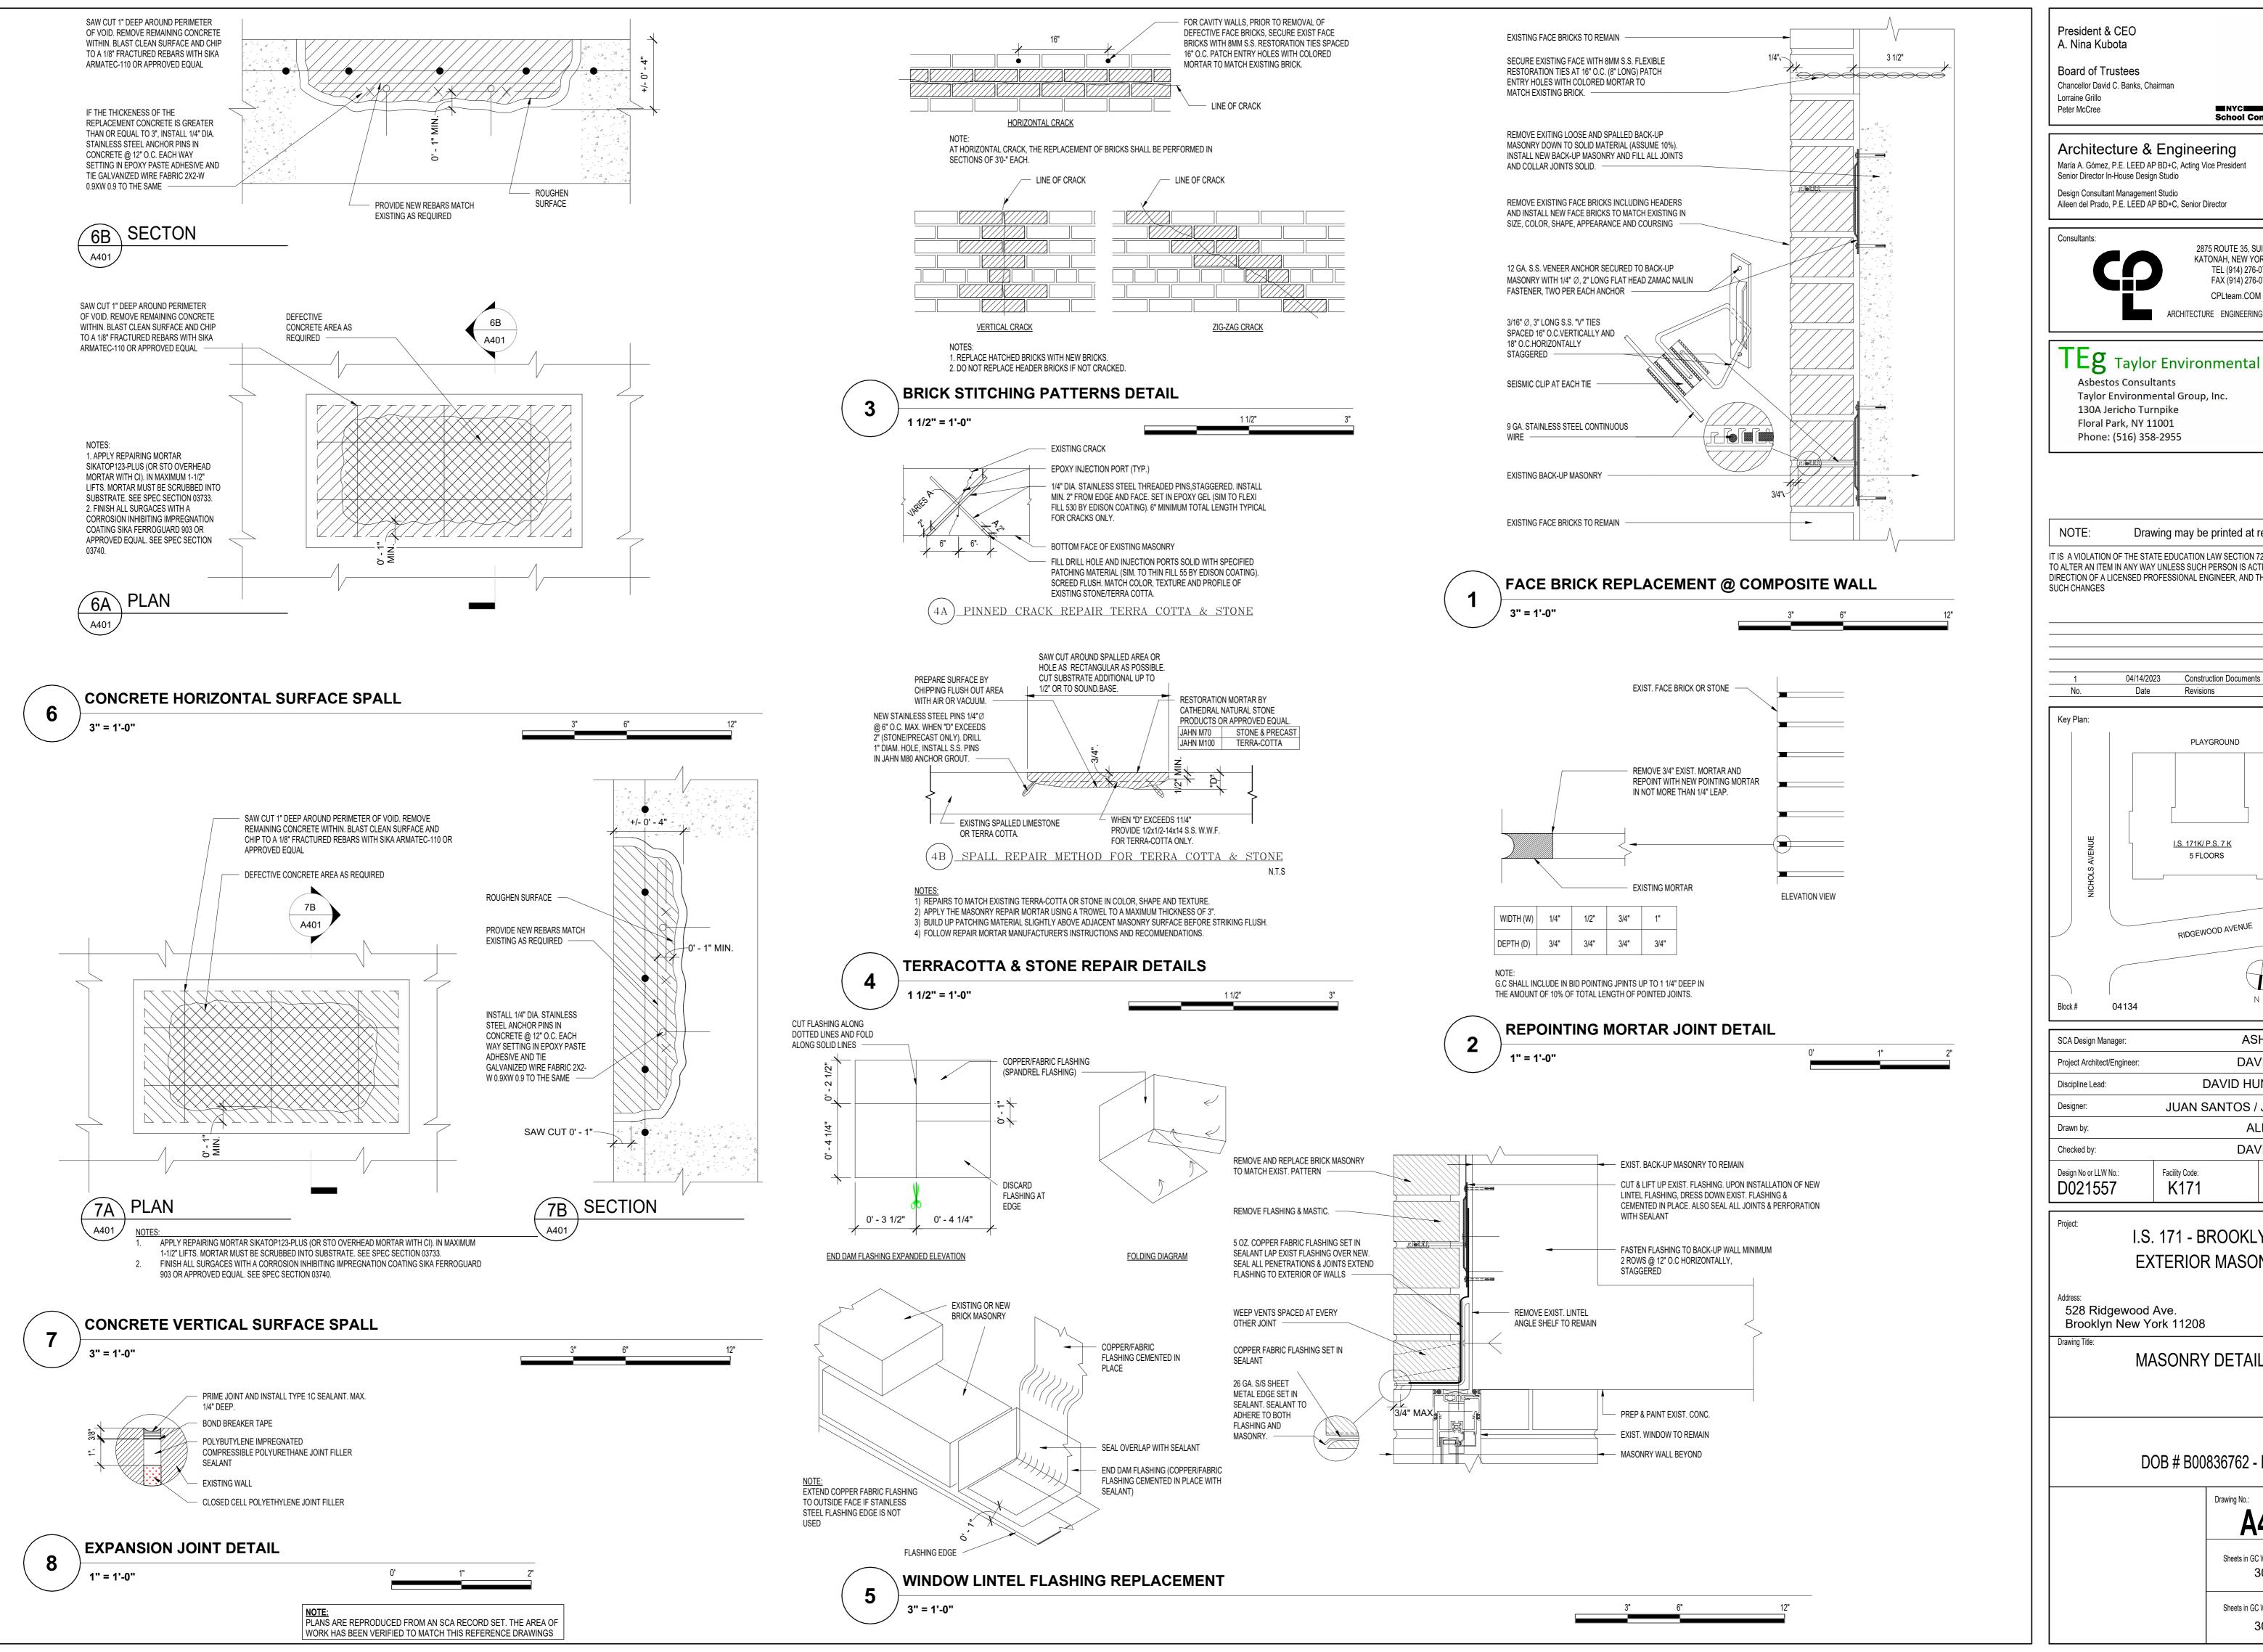
**INTERIOR ELEVATIONS-2** 

DOB # B00836762 - I1

A302.00

Sheets in GC Work Type Contract Set : 29 OF 43

Sheets in GC Work Type DOB Filing Set: 29 OF 38





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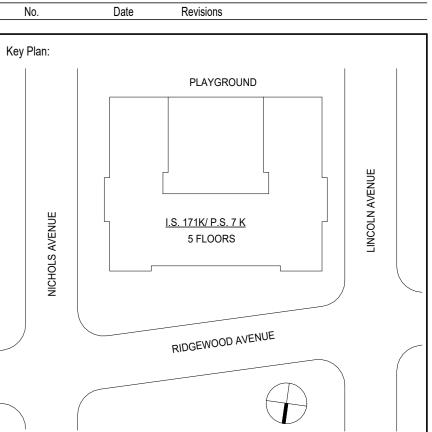
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Lot #

ASHRAF ELIAS, P.E DAVID SAMMEL, R.A DAVID HUNSBERGER, R.A JUAN SANTOS / JUAN POLANCO ALEXIS O'ROURKE DAVID SAMMEL, R.A Facility Code: K171 04/14/2023

> I.S. 171 - BROOKLYN **EXTERIOR MASONRY**

Brooklyn New York 11208


MASONRY DETAILS


DOB # B00836762 - I1

A401.00

Sheets in GC Work Type Contract Set: 30 OF 43

Sheets in GC Work Type DOB Filing Set: 30 OF 38

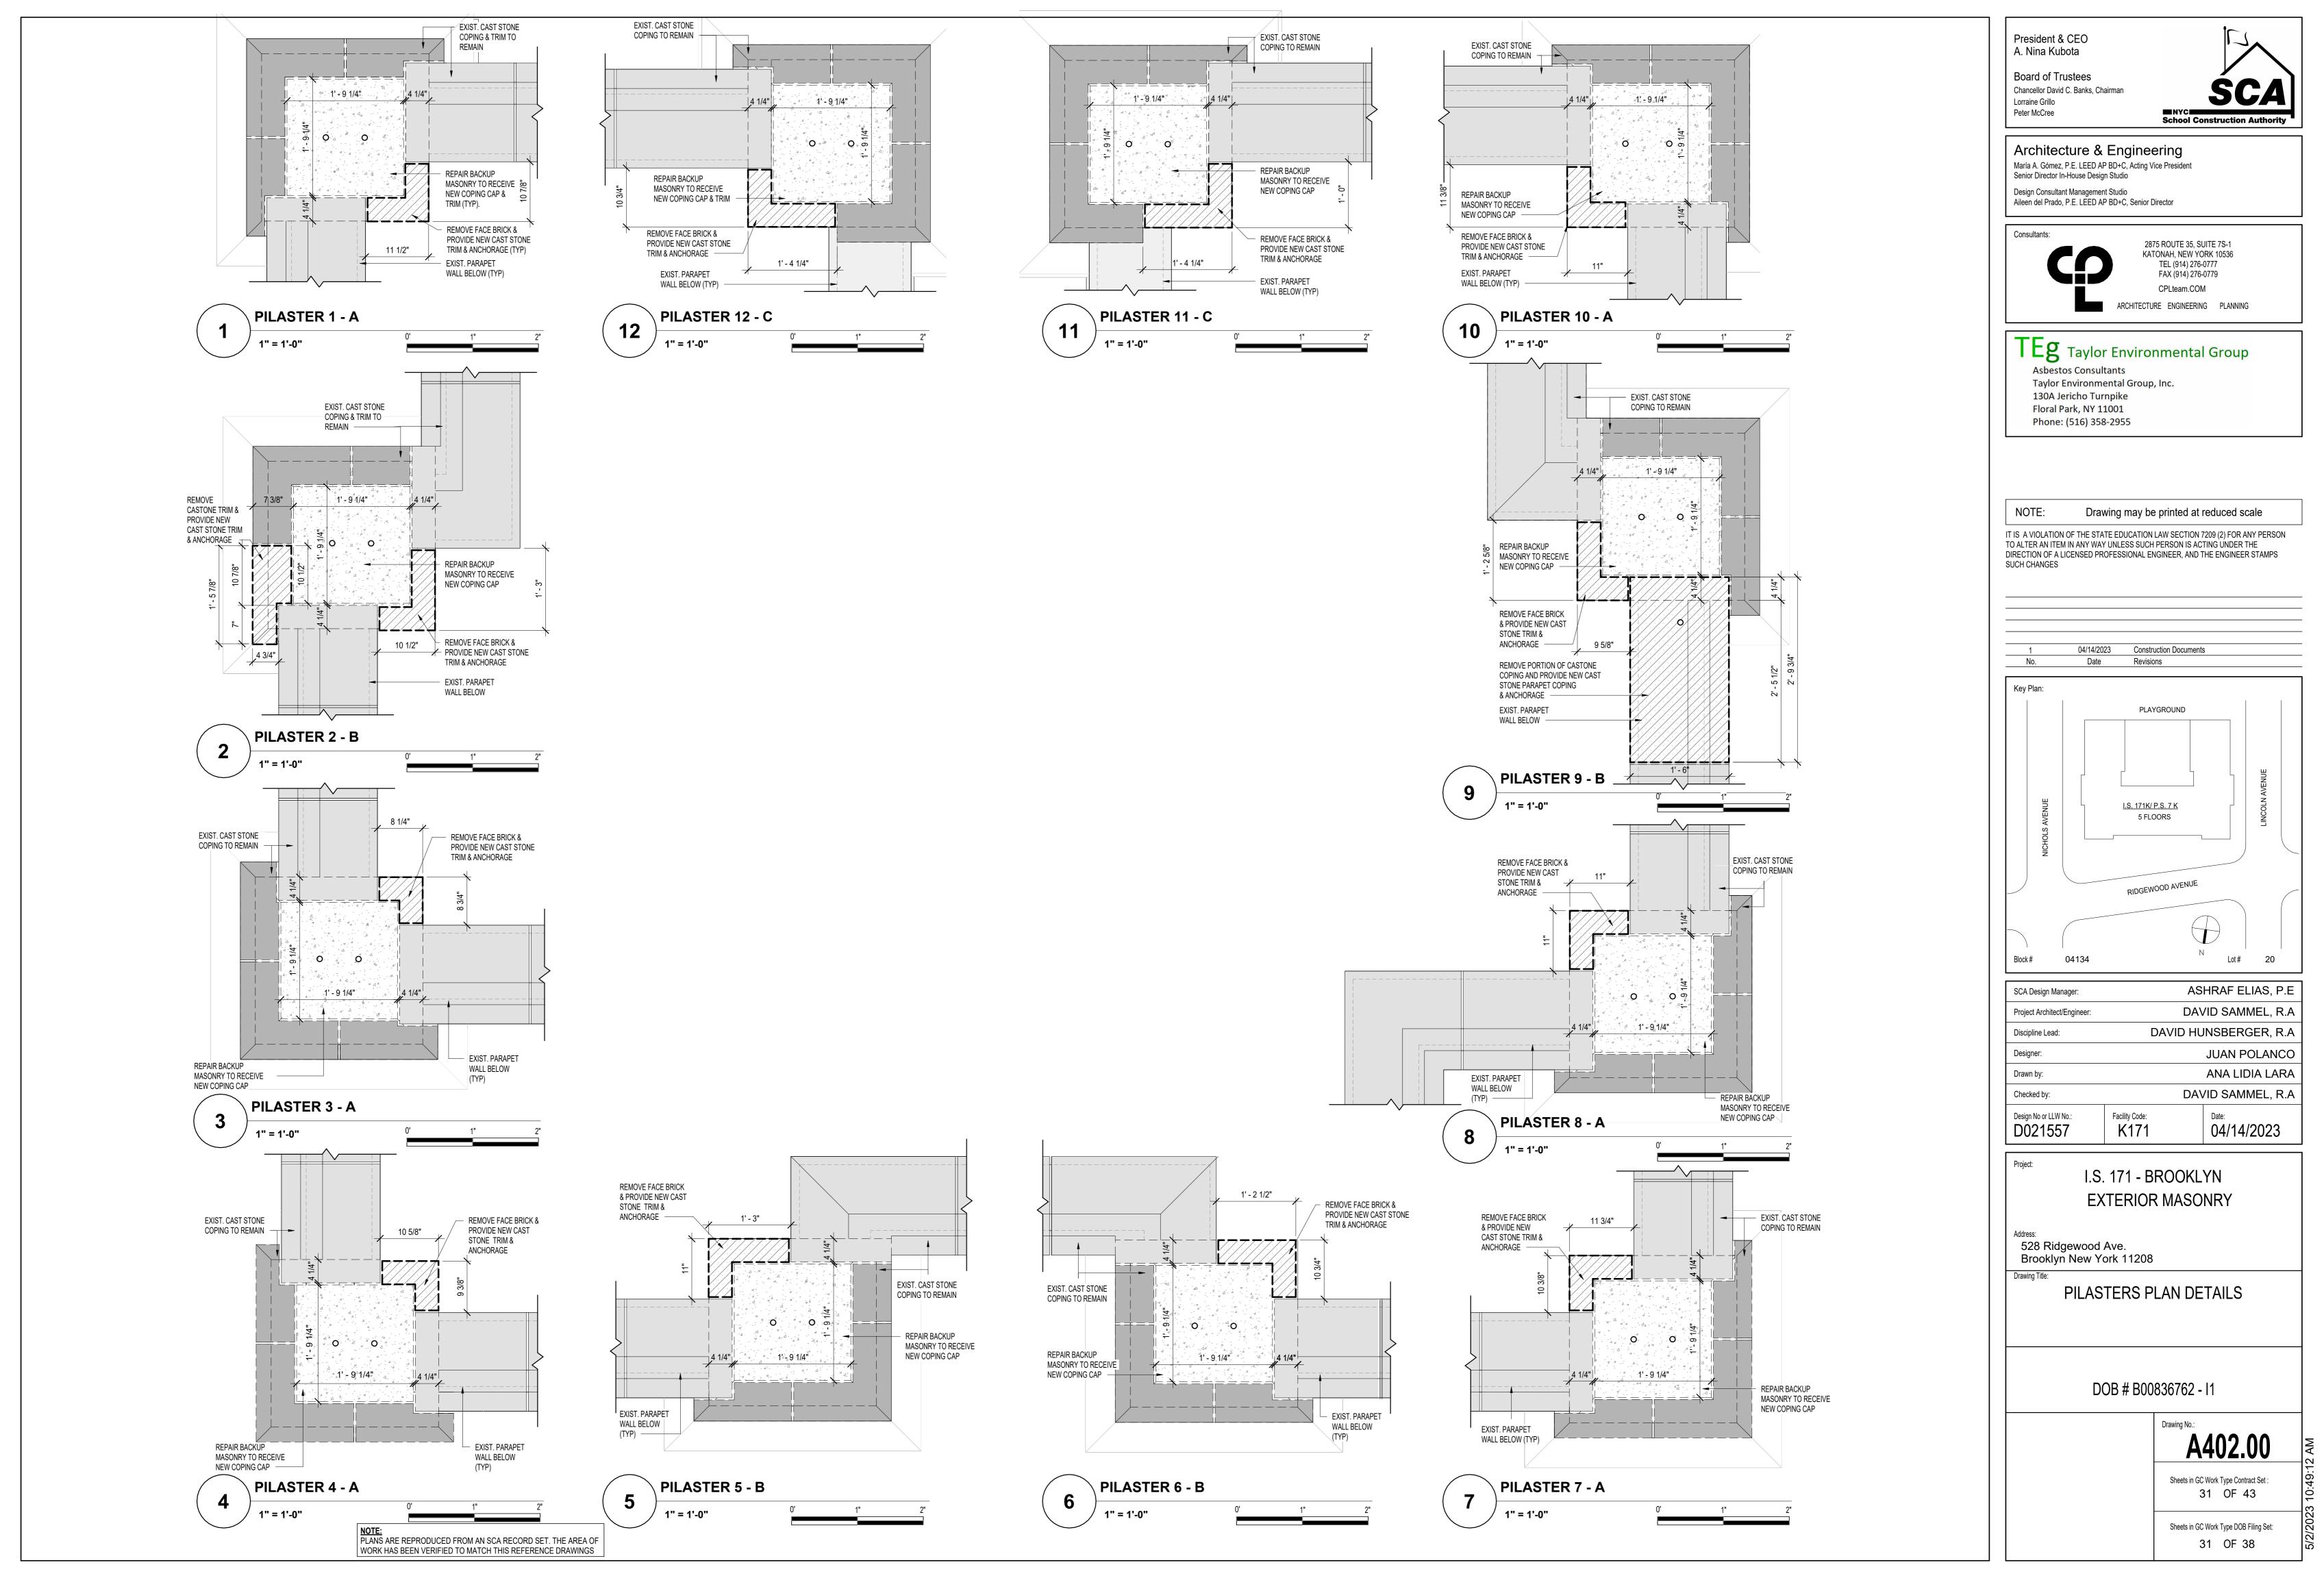

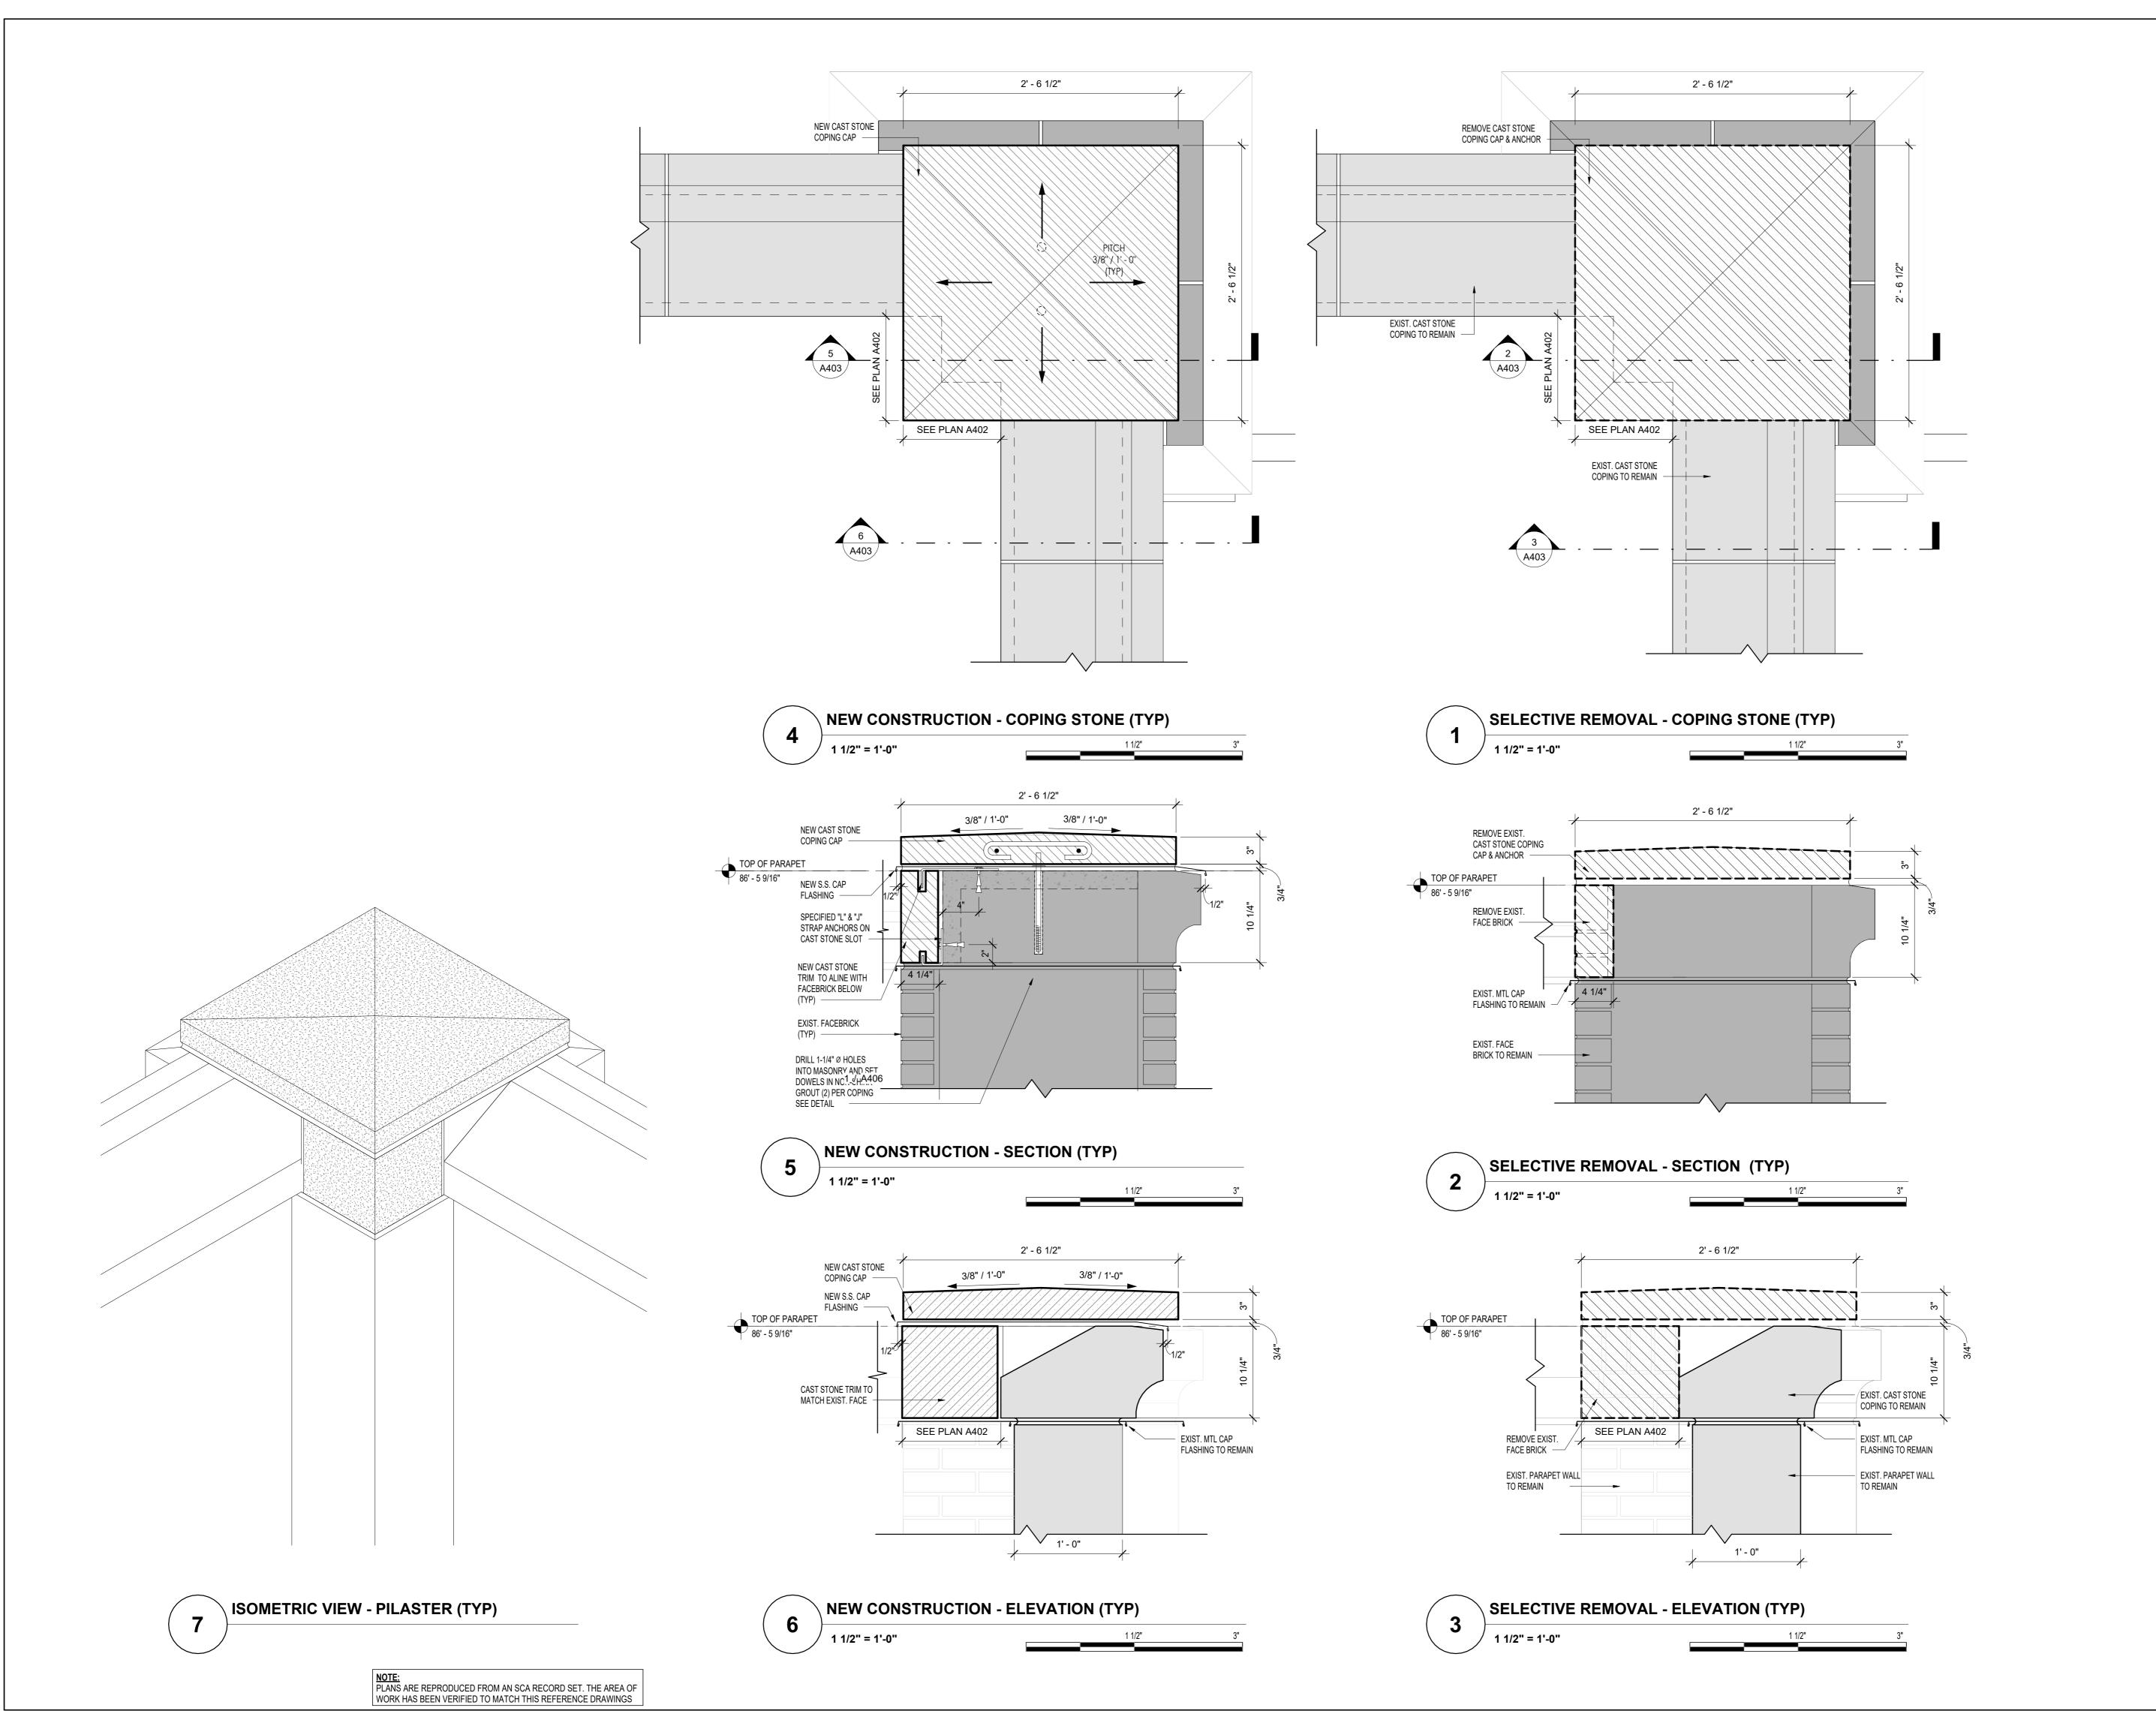

> Lorraine Grillo Peter McCree

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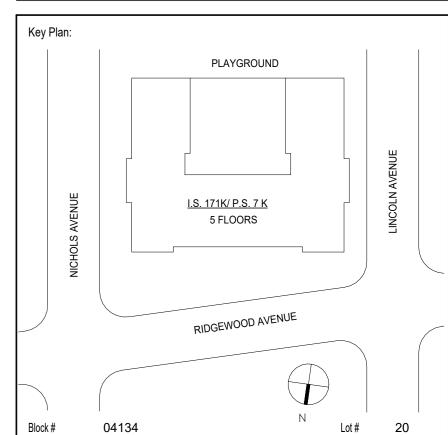
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04/14/2023 Construction Documents Date Revisions



Designer: JUAN POLANCO				
Discipline Lead:  Designer:  JUAN POLANCO  Drawn by:  ANA LIDIA LARA  Checked by:  Design No or LLW No.:  Facility Code:  DAVID HUNSBERGER, R.A  JUAN POLANCO  ANA LIDIA LARA  DAVID SAMMEL, R.A  Date:	SCA Design Manager:	AS	HRAF ELIAS, P.E	
Designer:  Drawn by:  ANA LIDIA LARA  Checked by:  Design No or LLW No.:  Facility Code:  Date:	Project Architect/Engineer:	DA\	/ID SAMMEL, R.A	
Drawn by:  Checked by:  David Sammel, R. Design No or LLW No.:  Facility Code:  Date:	Discipline Lead:	DAVID HUNSBERGER, R.A		
Checked by:  David Sammel, R. A  Design No or LLW No.:  Facility Code:  Date:	Designer:	JUAN POLANCO		
Design No or LLW No.: Facility Code: Date:	Drawn by:		ANA LIDIA LARA	
,	Checked by:	DA\	/ID SAMMEL, R.A	
	•	•		

I.S. 171 - BROOKLYN **EXTERIOR MASONRY** 


528 Ridgewood Ave. Brooklyn New York 11208

PILASTER DETAILS - 1

DOB # B00836762 - I1

Sheets in GC Work Type Contract Set : 32 OF 43

Sheets in GC Work Type DOB Filing Set: 32 OF 38

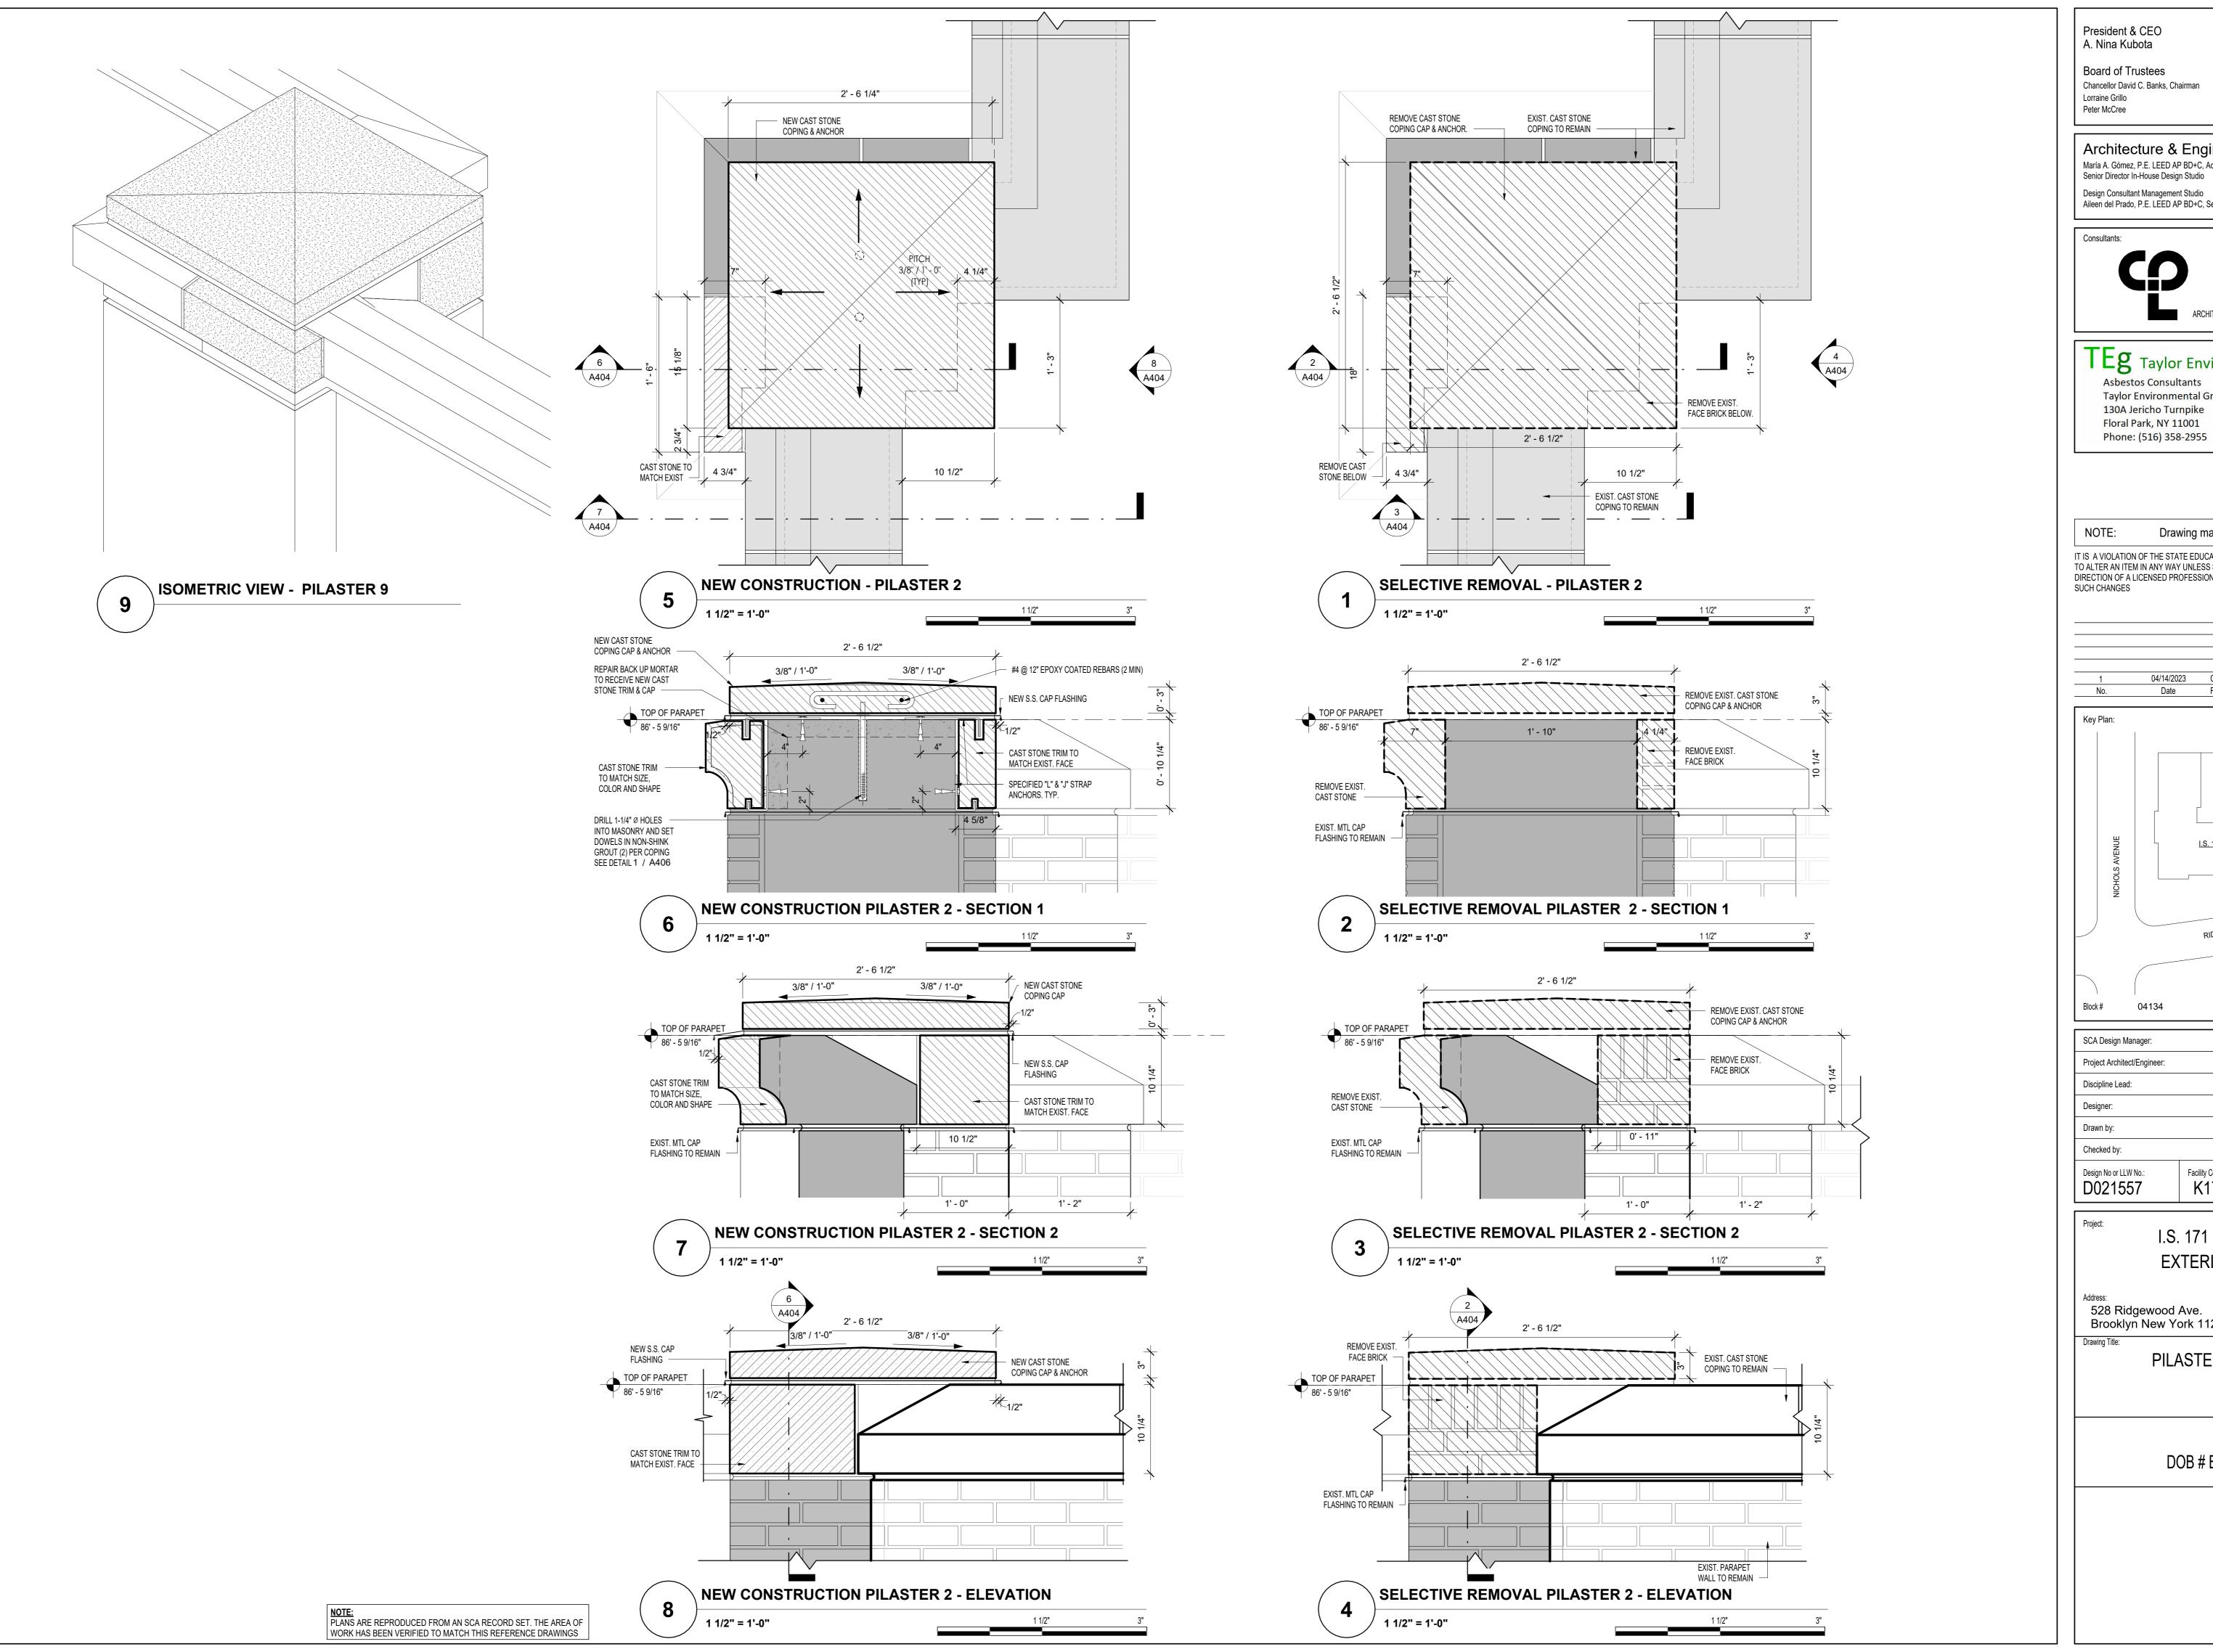



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Design Consultant Management Studio
Aileen del Prado, P.E. LEED AP BD+C, Senior Director


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04/14/2023 Construction Documents Revisions



ASHRAF ELIAS, P.E DAVID SAMMEL, R.A DAVID HUNSBERGER, R.A JUAN POLANCO ANA LIDIA LARA DAVID SAMMEL, R.A Facility Code: K171 04/14/2023

> I.S. 171 - BROOKLYN **EXTERIOR MASONRY**

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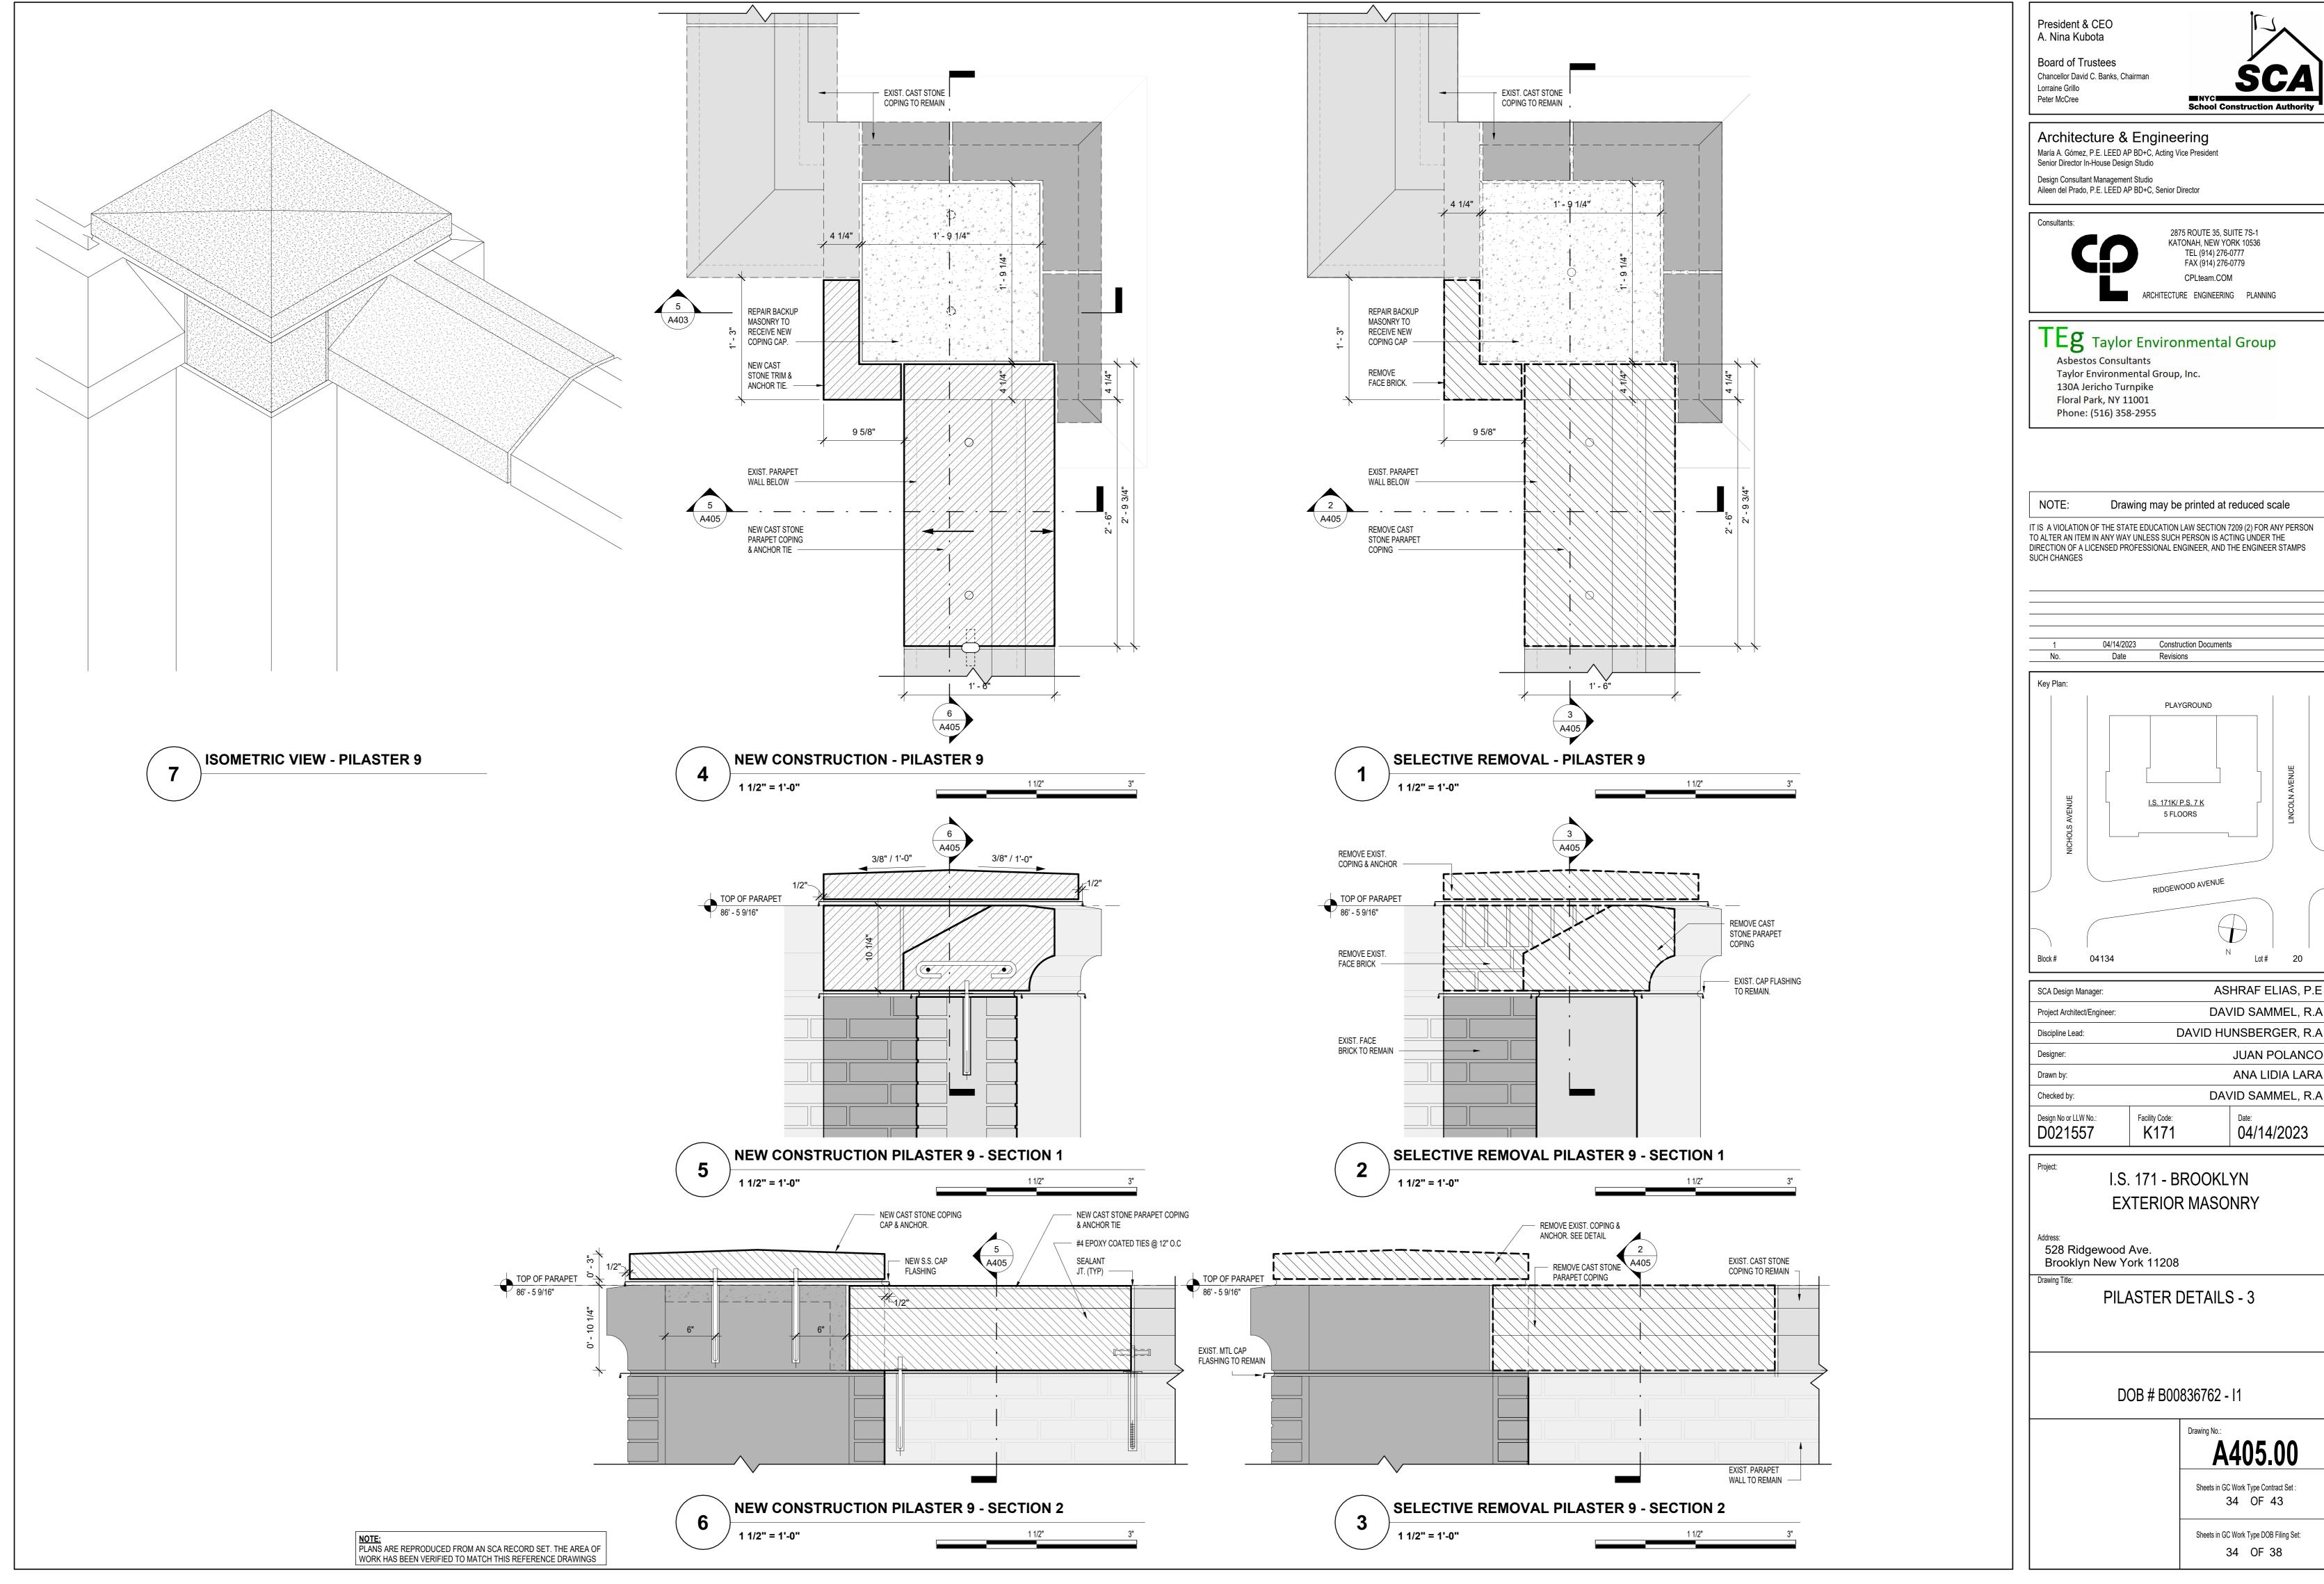
PILASTER DETAILS - 2

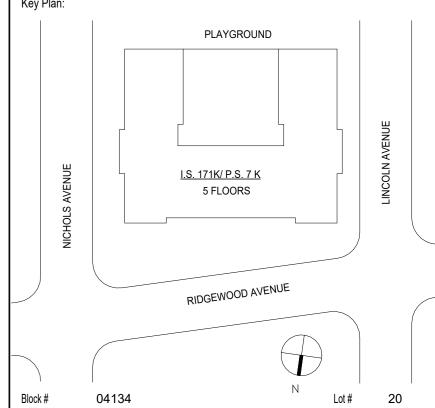DOB # B00836762 - I1


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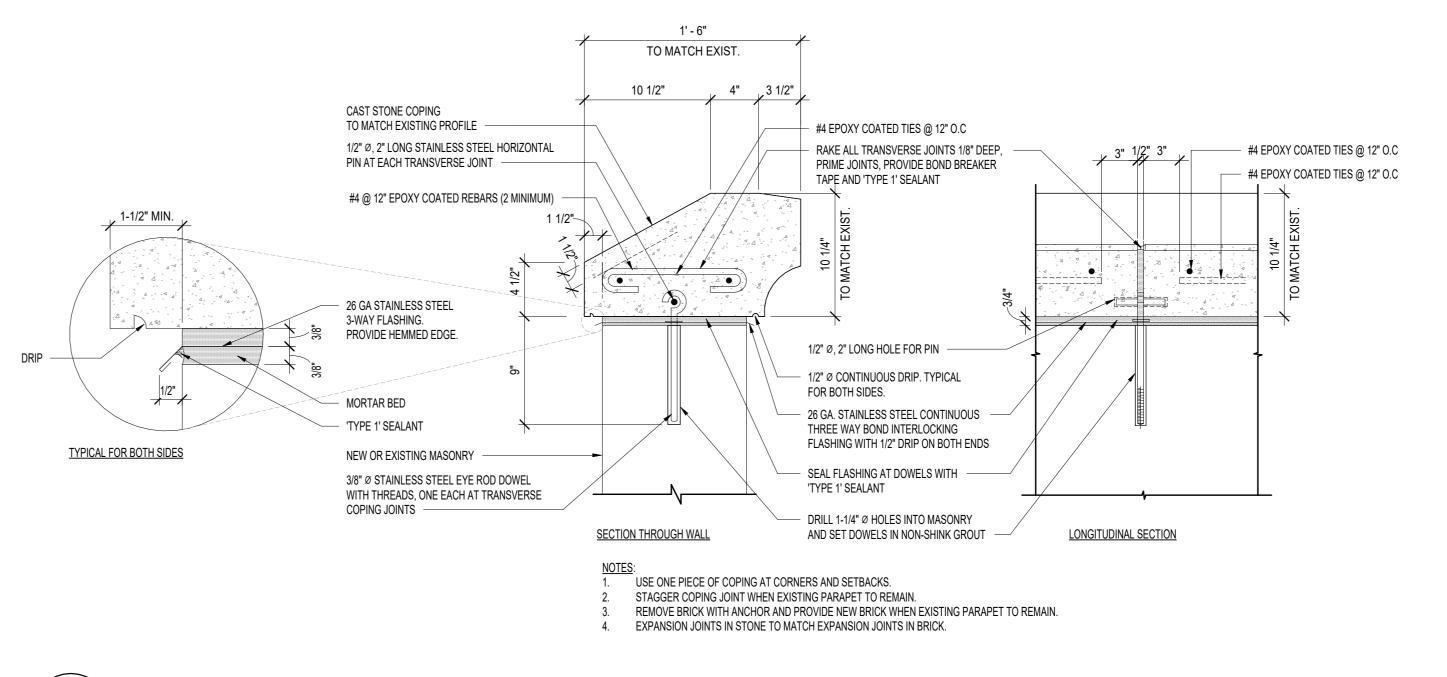
Sheets in GC Work Type Contract Set : 33 OF 43

Sheets in GC Work Type DOB Filing Set: 33 OF 38







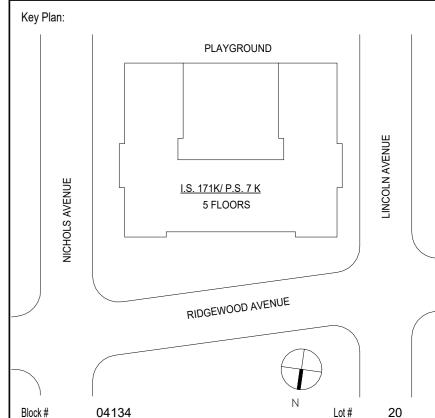

**CAST STONE COPING DETAIL** 1 1/2" = 1'-0"

President & CEO A. Nina Kubota

Lorraine Grillo

Peter McCree

Board of Trustees Chancellor David C. Banks, Chairman



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Design Consultant Management Studio
Aileen del Prado, P.E. LEED AP BD+C, Senior Director

Consultants:


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04/14/2023 Construction Documents Date Revisions



ASHRAF ELIAS, P.E SCA Design Manager: DAVID SAMMEL, R.A Project Architect/Engineer: DAVID HUNSBERGER, R.A Discipline Lead: JUAN POLANCO Designer: ANA LIDIA LARA / ALEXIS O'ROURKE DAVID SAMMEL, R.A Checked by: Facility Code: Design No or LLW No.: K171 D021557 04/14/2023

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528 Ridgewood Ave. Brooklyn New York 11208

**COPING DETAILS** 

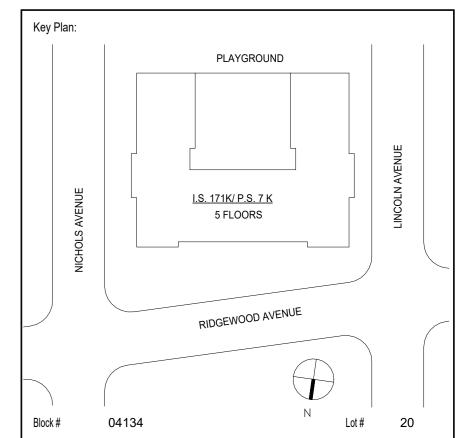
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A406.00


Sheets in GC Work Type Contract Set : 35 OF 43

Sheets in GC Work Type DOB Filing Set: 35 OF 38

NOTE:
PLANS ARE REPRODUCED FROM AN SCA RECORD SET. THE AREA OF WORK HAS BEEN VERIFIED TO MATCH THIS REFERENCE DRAWINGS




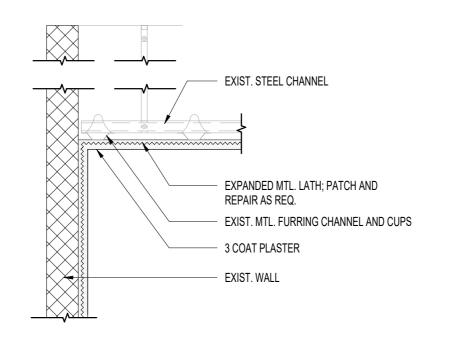

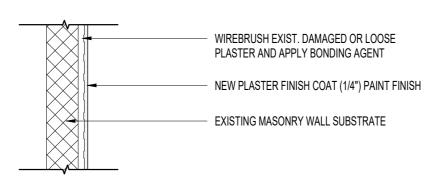


TYPICAL WALL FINISH DETAIL

1" = 1'-0"

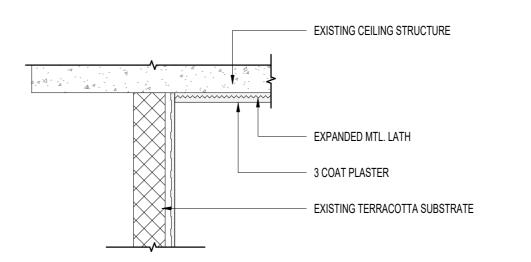

NEW PLASTER CEILING DETAIL

1" = 1'-0"

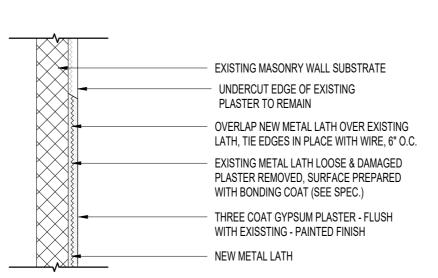

TYPICAL PLASTER WALL PATCH DETAIL

1" = 1'-0"

0' 1" 2"

#### INTERIOR REPAIR

- 1. SEE INTERIOR ELEVATIONS A301 TO A304, AND INTERIOR FINISH NOTES ON SHEET A701 FOR FURTHER INFORMATION.
- 2. REMOVE ACOUSTIC TILE, PLASTER, LATH, GYPSUM BOARD ETC., IN ALL AREAS TO RECIEVE NEW PLASTER OR GYP. BOARD FINISH.
- REMOVE AND REPLACE ANY LIGHT SWITCHES, CONDUITS, SWITCHES ETC, AS NEXESSARY TO PERFORM THE WORK INDICATED BY E.C.
- CONTRACTOR SHALL REMOVE AND PROTECT ALL FURNITURE, CABINETS, SUPPLIES, ETC, AS NECESSARY
- NEWLY INSTALLED, PATCHED WORK AND ALL AFFECTED AREAS SHALL BE PAINTED, ALL PAINTED WORK SHALL BE PERFORMED TO COVER THE ENTIRE HORIZONTAL OR VERTICAL SURFACE TO THE CLOSET CORNER IN ALL FOUR DIRECTIONS, COLOR TO MATCH EXISTING.

TO PERFORM THE WORK INDICATED BY E.C.

#### NOTES FOR REPAIR OF PLASTER/PAINT/FINISHES

- P-1 SOUND EXISTING PLASTER TO DETERMINE WHETHER IT IS BONDED TO THE SUBSTRATE, CUT OUT TO CLEAN MATERIAL ALL DAMAGED PLASTER AND ALL PLASTER WHERE THE BOND TO THE SUBSTRATE HAS FAILED. BACK CUT EACH EDGE WITH SQUARE OR DOVETAIL EDGE CUTS TO PROVIDE MECHANICAL BOND FOR NEW PLASTER. INSTALL NEW METAL LATH WITH METAL FURRING STRIPS SECURED TO THE BRICK WALL. PATCH WITH NEW PLASTER TO MATCH ADJACENT SURFACES.
- P-2 REMOVE EXISTING PLASTER AND LATH TO EXPOSE CLEAN SUBSTRATE. BACK CUT EACH EDGE WITH SQUARE OR DOVETAIL EDGE CUTS TO PROVIDE MECHANICAL BOND FOR NEW PLASTER. INSTALL NEW METAL LATH WITH METAL FURRING STRIPS SECURED TO THE BRICK WALL. PATCH WITH NEW PLASTER TO MATCH ADJACENT SOUND WORK. PAINT PLASTER TO MATCH COLOR AND TEXTURE OF ADJACENT SURFACES.
- P-3 REPAIR SMAL HOLES IN PLASTER LESS THAN 4 INCHES IN DIAMETER TO MATCH TEXTURE AND COMPOSITION OF ADJACENT SOUND PLASTER. PAINT PLASTER TO MATCH COLOR AND TEXTURE OF ADJACENT SURFACES.
- P-4a AT CRACKS LESS THAN 1.4" WIDE, WHICH REMAIN IN THE FINISH COAT, AND WHERE PLASTER IS BONDED TO SUBSTRATE, APPLY BONDING AGENT TO EXTEND FROM CRACK 6" AT ALL SIDES. APPLY NEW FINISH (SKIM) COAT OVER PLASTER REPAIR. PAINT TO MATCH COLOR AND TEXTURE OF ADJACENT SURFACES.
- P-4b AT CRACKS GREATER THAN 3/16" WIDE, CUT OUT CRACK. BACK CUT EACH EDGE WITH SQUARE OR DOVETAIL EDGE CUTS TO PROVIDE MECHANICAL BOND FOR NEW PLASTER. PATCH WITH NEW PLASTER TO MATCH THE CONSTITUENT COMPOSITION, THICKNESS, TEXTURE AND PROFILES OF ADJACENT SOUND WORK.
- P-5 REMOVE PEELING PAINT, PREPARE SURFACE AND PAINT 100% OF ROOM CEILINGS AND WALLS.

President & CEO A. Nina Kubota

Lorraine Grillo

Peter McCree

Board of Trustees
Chancellor David C. Banks, Chairman



# Architecture & Engineering

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Design Consultant Management Studio
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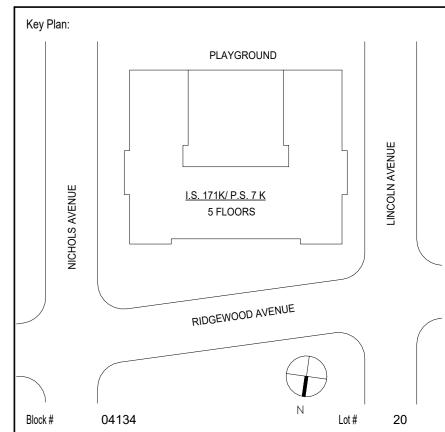
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1 04/14/2023 Construction Documents

No. Date Revisions



SCA Design Manager:	A	SHRAF ELIAS, P.E	
Project Architect/Engineer:	tect/Engineer: DAVID SAMMEL, R.A		
Discipline Lead:	DAVID HUNSBERGER, R.A		
Designer:	JUAN POLANCO		
Drawn by:	ALEXIS O'ROURKE		
Checked by:	DA	AVID SAMMEL, R.A	
Design No or LLW No.: D021557	Facility Code: K171	Date: 04/14/2023	

I.S. 171 - BROOKLYN EXTERIOR MASONRY

Address: 528 Ridgewood Ave. Brooklyn New York 11208

Drawing Title

INTERIOR DETAILS

DOB # B00836762 - I1

Drawing No.: **A701.00** 

Sheets in GC Work Type Contract Set : 36 OF 43

36 OF 38

Sheets in GC Work Type DOB Filing Set:

NOTE:
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